



STATE OF NEW YORK
OFFICE OF GENERAL SERVICES
DESIGN AND CONSTRUCTION GROUP
THE GOVERNOR NELSON A. ROCKEFELLER
EMPIRE STATE PLAZA
ALBANY, NY 12242



ADDENDUM NO. 1 TO PROJECT NO. 44343

**CONSTRUCTION WORK
UPGRADE CONCESSION STAND
SUFFOLK COUNTY CRIMINAL COURT HOUSE
240 CENTER DRIVE
RIVERHEAD, NEW YORK 11901**

May 18, 2012

NOTE: This Addendum forms a part of the Contract Documents. Insert it in the Project Manual.
Acknowledge receipt of this Addendum in the space provided on the Bid Form.

SPECIFICATIONS GROUP

1. DOCUMENT 101423 SIGNS: Add the accompanying document (pages 101423 – 1 thru 101423 - 3) to the Project Manual.

DRAWINGS

2. Revised Drawings:
 - a. Drawing No. A101, noted “ADDENDUM #1 – 05/15/12” accompanies this Addendum and supercedes the same numbered originally issued drawing.
 - b. Drawing No. A102, noted “ADDENDUM #1 – 05/15/12” accompanies this Addendum and supercedes the same numbered originally issued drawing.
 - c. Drawing No. E-101, noted “ADDENDUM #1 – 05/15/12” accompanies this Addendum and supercedes the same numbered originally issued drawing.

END OF ADDENDUM

James Dirolf, P.E.
Director of Design

SECTION 101423

SIGNS

PART 1 GENERAL

1.01 SUBMITTALS

- A. Shop Drawings: Show fabrication and mounting details for each sign type and copy specified. Include sign designs, dimensions, copy style, and copy heights.
 - 1. For signs supported or anchored to permanent construction provide setting drawings for anchor bolts and other anchors to be installed under other sections.
- B. Product Data: Catalog sheets, specifications, and installation instructions for each sign type and mounting type specified.
- C. Samples:
 - 1. Full size of each sign type and copy type specified including mounting accessories. These samples will be returned and, if approved, may be used in the Work.
 - 2. Color Samples: Manufacturer's standard colors for sign material and finishes specified.
- D. Quality Control Submittals:
 - 1. Sign Fabricator Qualification Data: Certified statement from the fabricator indicating the capacity and number of years products similar to those specified for the Work have been produced.
- E. Templates: Provide full-size spacing templates for individually mounted dimensional letters and numbers.

1.02 QUALITY ASSURANCE

- A. Sign Fabricator Qualifications: The firm manufacturing the signs shall have been regularly producing signs similar to those specified for the Work, for a minimum of 5 years. The firm shall also have sufficient production capacity to produce the quantity of sign units required without causing delay in the Work.
- B. Single-Source Responsibility: For each separate type of sign required, obtain signs from one source from a single manufacturer.

1.03 PROJECT CONDITIONS

- A. Do not install the sign units until all other finishing operations, including painting, have been completed unless otherwise directed.

1.04 DELIVERY, STORAGE, AND HANDLING

- A. Deliver sign units to Site with protective covering in place.
- B. Leave protective covering on sign units until completion of installation.

PART 2 PRODUCTS

2.01 MATERIALS

- A. PVC Sheet: Routed logo and letters from ½” CAM material.
 - 1. Thickness: 1/2 inch, unless otherwise indicated.
 - 2. Color: “Express Stop” copy – Black.
 - 3. Color: Logo ‘dot & lines’ symbol – clear PVC sheet with copy matching Benjamin Moore 2084 Maple Leaf Red.
- B. Opaque Coating: Sign manufacturer’s standard or recommended non-fading inks, paints or enamels.
- C. Mounting Materials:
 - 1. Mechanical Mounting (MM): Sign manufacturer’s standard or recommended full threaded screws with tamper resistant heads.
 - a. Plaster Substrates: Furnish plastic anchors with screws.
 - 2. Sealant Mounting (SM): Sign manufacturer’s standard or recommended acrylic or silicone sealant type adhesive intended for substrates involved.
- D. Backlit Menu Boards:
 - 1. Basis of Design Product: Mainstreet Gold by Mainstreet Menu Systems (800-782-6222)
 - 2. Size: 54”x18” (2 qty 27”x18” E-module units).
 - 3. Panel Configuration: E14 Standard.
 - 4. Listing Strips: Provide 26 qty. listing strips with standard copy as directed by Director’s Representative.
 - 5. Header Strips: Provide 2 qty. header strips with standard copy as directed by Director’s Representative
 - 6. Trim: Black Contempo Trim.
 - 7. Pricing Strips: Provide individual price chips in price carrier. Provide full assortment of numbers.
 - 8. Mounting: Provide manufacturer’s standard wall mount kit.

2.02 PANEL CONFIGURATION

- A. Comply with requirements indicated for each sign type and copy. Produce smooth, even, level, sign panel surfaces, constructed to remain flat under installed conditions within a tolerance of plus or minus 1/16 inch measured diagonally.

- B. Unframed Panel Signs: Fabricate sign units with edges mechanically and smoothly finished to conform with the following conditions:
 - 1. Corner Condition: Square & Rounded to radius indicated or directed.

2.03 FABRICATION

- A. Fabricate sign units of graphic process, design, copy, dimensions and color indicated or specified.
- B. Fabricate individual sign letters.
- C. Copy shall be as stated on drawings.
 - 1. Confirm "To Be Determined" information before fabrication.

PART 3 EXECUTION

3.01 EXAMINATION

- A. Verification of Conditions: Examine surfaces to receive the signs for defects that will adversely affect the execution and quality of the Work. Do not proceed until unsatisfactory conditions are corrected.


3.02 INSTALLATION

- A. Install the work of this Section in accordance with the sign or menu board manufacturer's printed installation instructions, except as otherwise indicated or specified.
- B. Secure sign units to surfaces and locations shown on the Drawings with mounting location and mounting method specified.


3.03 CLEANING AND PROTECTION

- A. Do not remove protective coverings until directed.
- B. Clean sign units when directed.

END OF SECTION

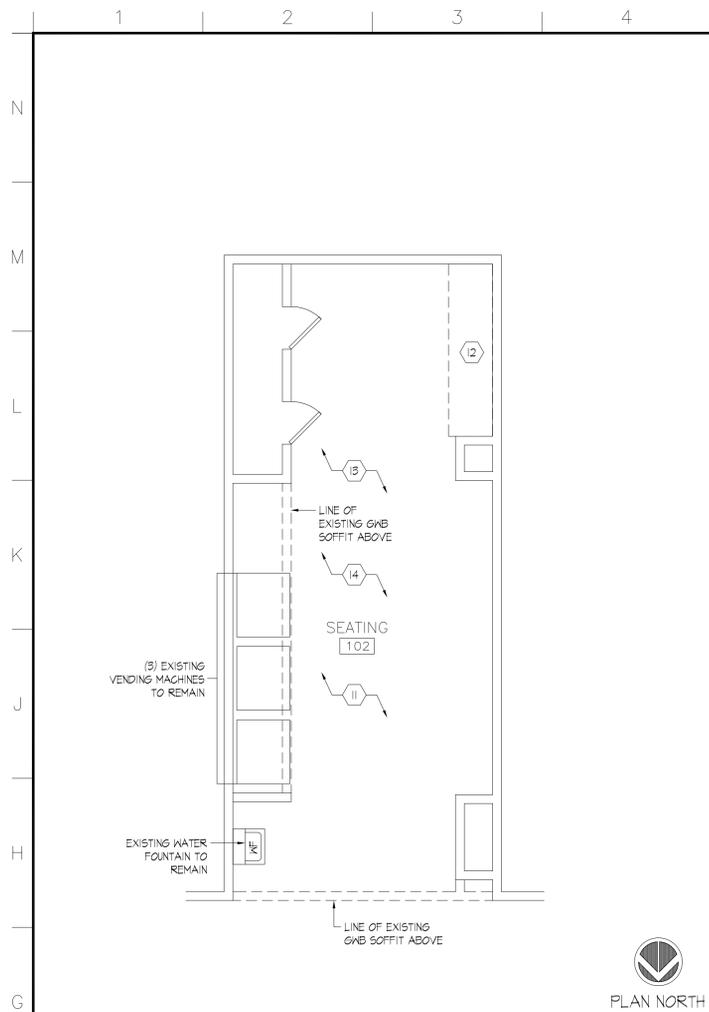

PLAN NORTH

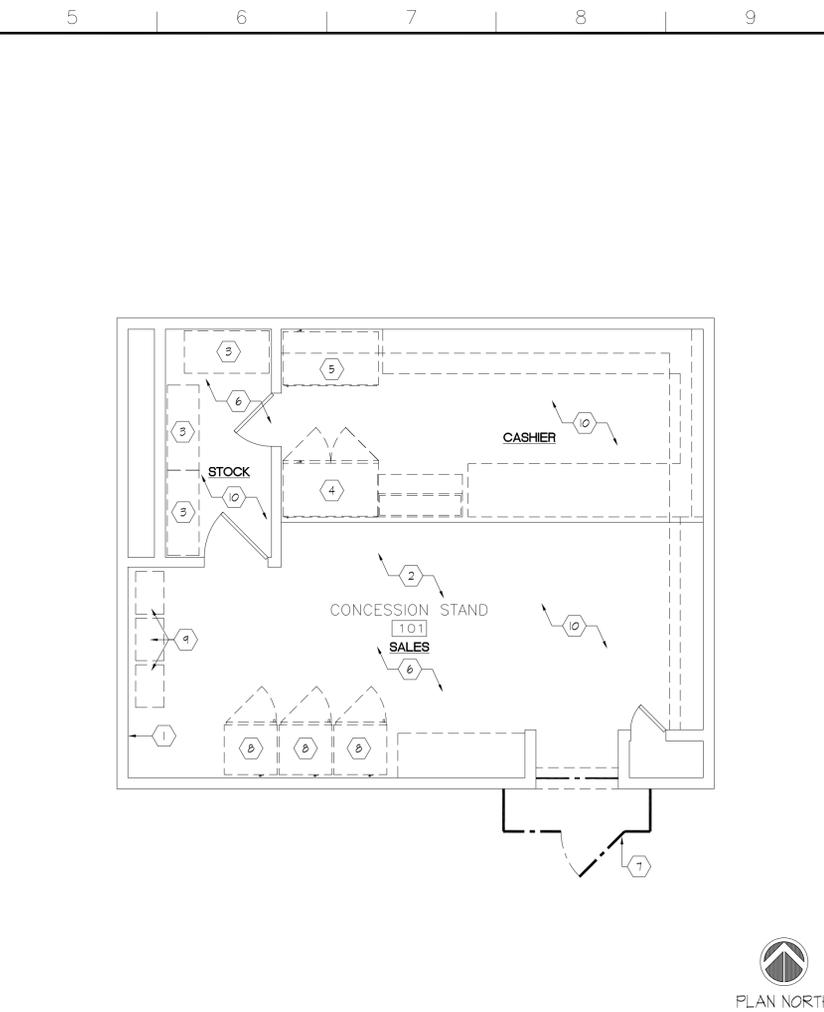

PLAN NORTH

GENERAL REMOVAL NOTES

- ALL DIMENSIONS INDICATED ON THE DRAWING ARE APPROXIMATE. THE CONTRACTOR SHALL VERIFY ALL DIMENSIONS AND REPORT ANY DISCREPANCIES TO THE DIRECTOR'S REPRESENTATIVE IN WRITING PRIOR TO STARTING OF WORK.
- THE CONTRACTOR SHALL PROTECT ALL WALLS OR FEATURES THAT ARE NOT SCHEDULED TO BE REMOVED. REPAIR AND/OR REPLACE ALL WALLS OR FEATURES DAMAGED DURING THE PROCESS OF DEMOLITION AND NEW CONSTRUCTION.
- REFER TO MECHANICAL, ELECTRICAL AND PLUMBING DRAWINGS FOR ADDITIONAL REMOVALS INFORMATION NOT INDICATED ON THIS DRAWING.
- REMOVE SECTIONS OF EXISTING NON-STRUCTURAL CONSTRUCTION AS REQUIRED, WHETHER INDICATED OR OTHERWISE, TO ACCOMMODATE NEW CONSTRUCTION WITH THE APPROVAL OF THE DIRECTOR'S REPRESENTATIVE.
- PROPERLY DISPOSE ALL ITEMS REMOVED DURING DEMOLITION UNLESS OTHERWISE INDICATED OR DIRECTED BY THE DIRECTOR'S REPRESENTATIVE.
- CONTRACTOR SHALL NOTIFY THE DIRECTOR'S REPRESENTATIVE IN WRITING IN THE EVENT OF UNANTICIPATED CONDITIONS ENCOUNTERED DURING DEMOLITION WHICH MAY CONFLICT WITH THE INTENDED FUNCTION OR DESIGN. DO NOT PROCEED WITH REMOVAL OF MATERIALS NOT INDICATED ON THE CONTRACT DOCUMENTS WITHOUT WRITTEN AUTHORIZATION FROM THE DIRECTOR'S REPRESENTATIVE.
- ROOM NAMES AND NUMBERS AS SHOWN DO NOT NECESSARILY CORRESPOND TO EXISTING DESIGNATIONS AND ARE FOR REFERENCE PURPOSES ONLY.

KEYED REMOVAL NOTES

- EXISTING CONSTRUCTION TO REMAIN, TYPICAL UNLESS NOTED OTHERWISE. PATCH ALL EXISTING WALL SURFACES DAMAGED OR DISRUPTED AS A RESULT OF THE WORK OF THIS CONTRACT AND PAINT TO MATCH ADJACENT.
- REMOVE EXISTING EQUIPMENT, CASEWORK, SHELVING, DISPLAY MILLWORK, ETC. RELOCATE COMPONENTS TO TEMPORARY SWING SPACE (ROOM 102). REMOVE AND DISPOSE ALL COMPONENTS IN TEMPORARY SWING SPACE NOT SCHEDULED TO BE REUSED UPON COMPLETION OF NEW CONCESSION STAND WORK IN ROOM 101.
- REMOVE EXISTING WIRE SHELVING UNITS. SALVAGE FOR REINSTALLATION.
- REMOVE EXISTING REFRIGERATED MERCHANDISER. SALVAGE FOR REINSTALLATION.
- REMOVE EXISTING REFRIGERATED MERCHANDISER.
- REMOVE EXISTING FLOOR TILE AND WALL BASE, TYPICAL.
- PROVIDE TEMPORARY 3 5/8" METAL STUD/ 5/8" GYPSUM BOARD PARTITION WITH 44" WIDE DOOR AT OPENING TO NEW STORE. PAINT TO MATCH ADJACENT WALLS. WALL SHALL BE ADEQUATELY SUPPORTED AND FREESTANDING. PENETRATIONS OF EXISTING FLOOR, WALL AND CEILING FINISHES WILL NOT BE ALLOWED. REMOVE TEMPORARY PARTITION ON COMPLETION OF WORK AND CLEAN EXISTING ADJACENT WALL, CEILING AND FLOOR FINISHES AS REQUIRED.
- REMOVE EXISTING BEVERAGE MERCHANDISERS. SALVAGE FOR REINSTALLATION.
- REMOVE EXISTING SHELVING, DISPLAY RACKS, ETC., TYP.
- REMOVE EXISTING SUSPENDED ACOUSTICAL CEILING SYSTEM.
- EXISTING WALL BASE AND FLOOR TILE TO REMAIN. PATCH WALL BASE WERE DAMAGED TO MATCH EXISTING.
- REMOVE EXISTING BASE CABINETS AND COUNTERTOP.
- REMOVE EXISTING TABLES AND CHAIRS.
- REMOVE EXISTING SUSPENDED ACOUSTICAL CEILING SYSTEM.

GENERAL NOTES

- ALL DIMENSIONS ARE TO THE FACE OF FRAMING AT NEW CONSTRUCTION, AND TO THE FACE OF EXISTING CONSTRUCTION UNLESS NOTED OTHERWISE.
- PLUS/MINUS (+) NOTATIONS ARE USED IN DIMENSION STRINGS TO ACCOUNT FOR VARIATIONS IN DRAWINGS AND FIELD CONDITIONS. VERIFY ALL PLUS/MINUS (+) DIMENSIONS DURING WORK, AND NOTIFY THE DIRECTOR'S REPRESENTATIVE IN WRITING OF ANY DISCREPANCY OR NECESSARY MODIFICATIONS PRIOR TO PROCEEDING WITH CONSTRUCTION.
- WHERE NON-FIRE RATED WALL CONSTRUCTION RESULTS IN NON-ACCESSIBLE SPACE, OMIT WALL FINISH (GYPSUM WALL BOARD) ON NON-ACCESSIBLE SIDE.
- THE DRAWINGS INDICATE A COMPLETE SCOPE OF WORK. DETAILS SHOWN ARE TYPICAL. SIMILAR DETAILS APPLY TO SIMILAR CONDITIONS UNLESS OTHERWISE INDICATED.
- WHERE REMOVALS RESULT IN UNFINISHED OPENINGS, HOLES, OR SIMILAR IRREGULARITIES AT WALLS, FLOORS OR CEILING, PATCH AND REPAIR SURFACES TO MATCH ADJACENT FINISH SURFACES.
- PROVIDE SOLID WOOD BLOCKING IN NEW WALLS AS REQUIRED FOR PROPER INSTALLATION OF CASEWORK, FIXTURES, FINISH TRIM, SHELVING STANDARDS, SIGNAGE, MENU SYSTEMS, ETC.
- WHERE EXISTING CONSTRUCTION IS BEING INFILLED WITH NEW CONSTRUCTION, ALIGN SURFACES OF NEW CONSTRUCTION WITH EXISTING CONSTRUCTION AND FINISH TO MATCH THE ADJACENT CONSTRUCTION.
- ROOM NAMES AND NUMBERS AS SHOWN DO NOT NECESSARILY CORRESPOND TO EXISTING DESIGNATIONS AND ARE FOR REFERENCE PURPOSES ONLY.
- ALL DIMENSIONS LOCATING MILLWORK AND/OR CASEWORK AND OPENINGS IN THE MILLWORK ARE FROM FINISH SURFACE.
- REFER TO FOOD SERVICE EQUIPMENT DRAWINGS AND MECHANICAL, ELECTRICAL, AND PLUMBING DRAWINGS FOR EQUIPMENT TYPES, LOCATIONS AND UTILITY REQUIREMENTS.
- PATCH AND REPAIR ALL EXISTING WALL SURFACES SCHEDULED TO BE PAINTED PRIOR TO APPLYING FINISH.
- HINGE JAMBS OF DOORS SHALL BE 4" FROM WALL CORNER WHERE DOORS ENTER ROOMS AT CORNERS UNLESS NOTED OTHERWISE.
- ALL COUNTERTOP HEIGHTS SHALL BE 34" A.F.F. UNLESS NOTED OTHERWISE.
- ANY PENETRATION THROUGH FIRE RESISTANCE RATED CONSTRUCTION SHALL BE FIRESTOPPED USING APPROVED FIRESTOP SYSTEM MEETING ASSEMBLY RATING REQUIREMENTS.
- PROVIDE NSF APPROVED SEALANT AT COUNTERTOPS AND FOOD SERVICE AREAS.

KEYED DRAWING NOTES

- SLATWALL SOFFIT. SEE DETAIL L1/A102
- SLATWALL MOUNTED ON FURRING. SEE DETAIL G1/A102
- REINSTALL EXISTING REFRIGERATED MERCHANDISER
- NOT USED
- SOLID SURFACE COUNTERTOP WITH 4" HIGH BACK AND SIDE SPLASHES WHERE COUNTERTOP ABUTS WALL SURFACE. SEE DETAIL G3/A102 AND SPECIFICATION SECTION 064000.
- NEW VGT FLOOR TILE AND WALL BASE. PROVIDE WALL BASE AT ALL EXPOSED WALLS, PARTITIONS AND IN TOE KICKS OF BASE CABINETS. SEE SPECIFICATION SECTION 096519
- NEW TABLES AND CHAIRS
- PATCH AND PAINT EXISTING WALLS

EQUIPMENT SCHEDULE

Item No	Qty	Equipment Category	Manufacturer	Model Number	Equip. Remarks
01	1	Display Case, Refrigerated	True Food Service	GDM-47	
02	1	Sink, Drop-In	Eagle Group/Metal Masters	SR12-14-9.5-3	
03	1	Sink, Drop-In	Advance Tabco	DI-1-5	
04	1	Display Case, Frozen	True Food Service	GDM-26F	
05	1	Oven, Microwave	Panasonic	NE-1064	
06	1	Soup Merchandiser	APW Wyott	CWM-25P	
07	1	Display Case, Refrigerated	True Food Service	GDM-47RL	EXISTING
08	1	Display Case, Refrigerated	Imbera Prime	G319	EXISTING
09	1	Display Case, Refrigerated	True Food Service	GDM-26HL	EXISTING
10	1	Display Case, Refrigerated	True Food Service	GDM-26	EXISTING
11	1	Brewer, Coffee	Bunn		EXISTING
12	1	Beverage Dispenser, Cappuccino			EXISTING
13	1	Shelving Kit, Wire - (4) Shelves; (4) 74" Posts	InterMetro Industries	2448BR	
14	2	Shelving Kit, Wire - (4) Shelves; (4) 74" Posts	InterMetro Industries	1848BR	


FIXTURE LEGEND

Item No	Equipment Category	Equipment Remarks
1201	Custom Casework	Wall Hung Work Counter/Wall Cabinets/Base Cabinets/Etc
1701	Base Cabinets w/ Solid Surface Counter	
1801	Sales Counter Cabinetry	
1802	Shelving, Wire	
1803	Condiment Counter	
1804	Angled Shelf Merchandiser	
1805	Display Rack, Medicine	

FURNISHING


TABLE HEIGHT CHAIRS:
MANUFACTURER: KI
PRODUCT: STRIVE 4-LEG STACK CHAIR
FEATURE: UPH SEAT/POLY BACK - NO ARMS
FINISH: SUBMIT FULL RANGE SAMPLE TO BE SELECTED BY ARCHITECT
QUANTITY: 16

TABLES (BASE & TOP):
MANUFACTURER: KI
PRODUCT (BASE): ATHENS AHS BASE - 22" DIA. (PAINTED)
PRODUCT (TOP): 24"x24" (STANDARD) LAMINATE TABLE TOP
FINISH: SUBMIT FULL RANGE SAMPLE TO BE SELECTED BY ARCHITECT
QUANTITY: 8

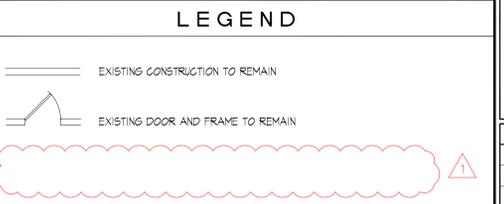


PAINT SCHEDULE

P-1	WALLS, DOOR FRAMES, TRIM & SLATWALL DISPLAY FINISH
P-2	DOORS
P-3	SLATWALL SOFFIT FINISH

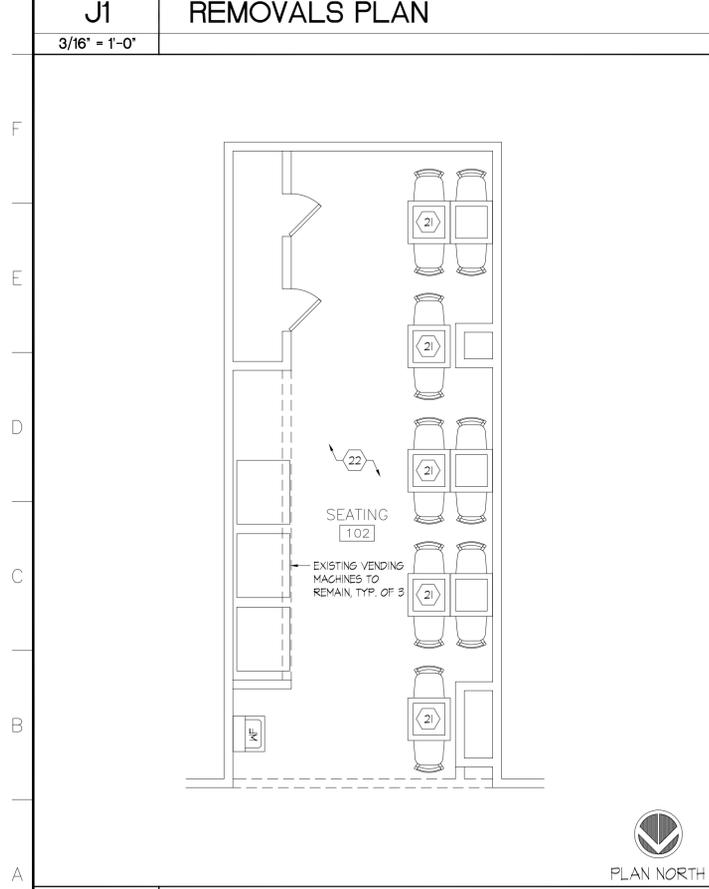

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ARCHITECTURE
INTERIORS
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PROJECT TITLE
**UPGRADE CONCESSION STAND
SUFFOLK COUNTY CRIMINAL COURTHOUSE
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CLIENT
**NYS OFF. OF CHILD AND FAMILY SERVICES
COMMISSION FOR THE BLIND
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Serving New York

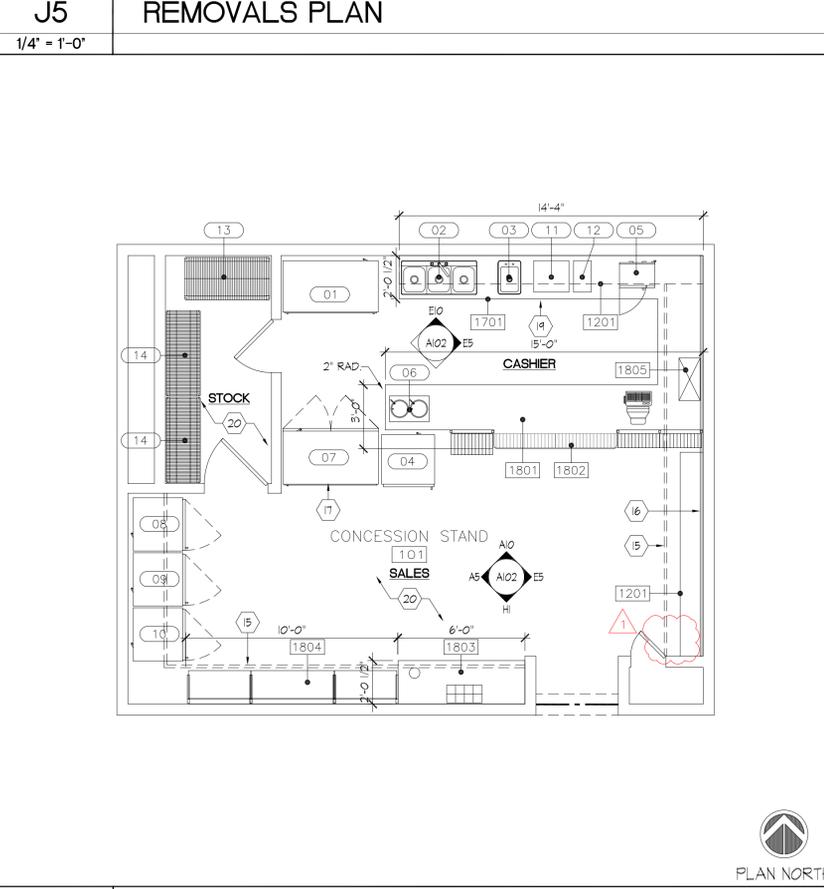ANDREW M. CUOMO
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Deputy Commissioner, Design and Construction

OGS PROJECT # 44343-C

DDA PROJECT # 11-007


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	ADDENDUM #1		05/15/12

Stamp


Drawn	Project Manager	P.I.C
MR	MR	DWD

SHEET TITLE
**FLOOR PLAN /
DEMOLITION PLAN**


SHEET NUMBER
A101

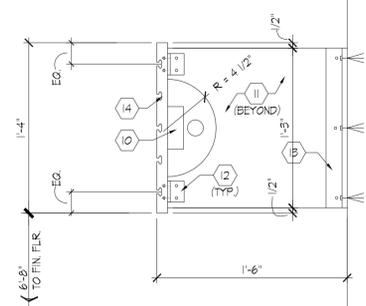

L1 INTERIOR DETAIL
1 1/2" = 1'-0"

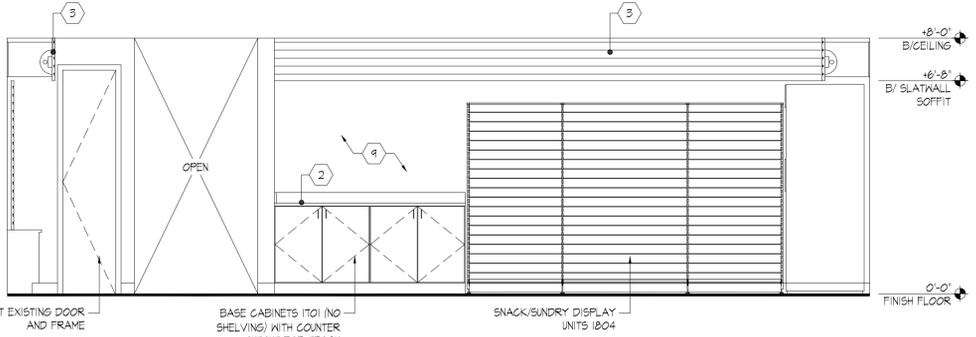


H1 INTERIOR ELEVATION
3/8" = 1'-0"

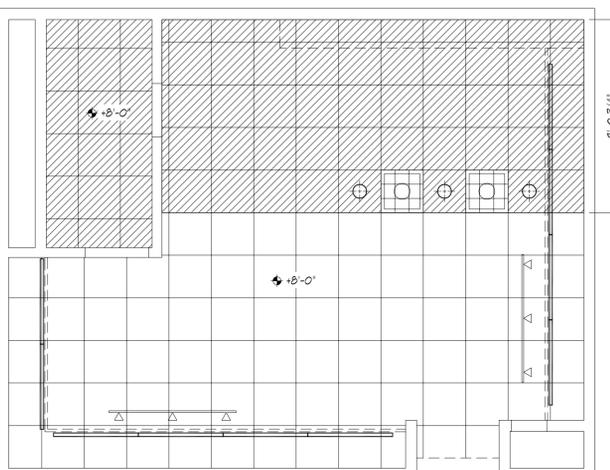

NOTE: SEE ELECTRICAL LIGHTING PLAN FOR GENERAL LIGHT FIXTURE NOT SHOWN

H7 REFLECTED CEILING PLAN
1/4" = 1'-0"

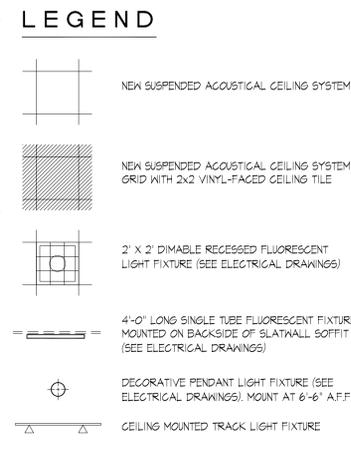

LEGEND

- GENERAL NOTES**
- 2x2 LIGHT FIXTURES OVER SALES COUNTER SHALL BE DIMABLE.
 - ALL LIGHT FIXTURES OVER SALES COUNTER AND IN STOCK/PREP AREAS SHALL HAVE COATED LAMPS, GLASS SHIELDS, OR WRAP-AROUND PRISMATIC LENSES.
 - PROVIDE TYPE 1 SEALANT AT PERIMETER OF DOOR FRAMES WHERE THEY ABUT ADJACENT WALL SURFACES.
 - PROVIDE TYPE 2 SEALANT AT PERIMETER OF DOOR FRAMES WHERE THEY ABUT ADJACENT WALL SURFACES.
 - PROVIDE TYPE 3 SEALANT AT ALL PENETRATIONS OF FIRE RATED CONSTRUCTION AS PART OF A UL-APPROVED FIRESTOP SYSTEM.
- KEYED DRAWING NOTES**
- 4" HIGH COVED RESILIENT BASE. SEE SPECIFICATION SECTION 090519.
 - SOLID SURFACE COUNTERTOP WITH 4" HIGH BACKSPLASH AND SIDE SPLASHES WHERE COUNTERTOP ABUTS WALL SURFACE. SEE DETAIL C3/A102 AND SPECIFICATION SECTION 064000.
 - 1'-4" HIGH SLATWALL SOFFIT WITH CONTINUOUS STRIP DOWNLIGHT. SEE DETAIL L1 THIS SHEET AND ELECTRICAL DRAWINGS.
 - SLATWALL MOUNTED ON FURRING. SEE DETAIL C1 THIS SHEET.
 - NOT USED.
 - SECURITY PANEL BY SALES COUNTER MANUFACTURER.
 - NOT USED.
 - NOT USED.
 - EXISTING WALL FINISH TO REMAIN. PATCH PER GENERAL NOTES (SHEET A101) AND PAINT PER SPECIFICATION SECTION 099101.
 - CONT. STRIP FLUORESCENT LIGHT FIXTURE. SEE REFLECTED CEILING PLAN, THIS SHEET AND ELECTRICAL DRAWINGS.
 - 3/4" THICK MEDIUM DENSITY FIBERBOARD 'STRUT' AT 24" O.C. PAINT TO MATCH SLATWALL.
 - ANGLE BRACKET 2" X 2" X 1/8" X 2" LONG, 2 BRACKETS EACH SIDE OF 'STRUT'. SCREW BRACKET INTO SLATWALL AND BOLT THROUGH STRUT WITH 2-1/4" DIA. BOLTS PER BRACKET.
 - CONT. DOUBLE 2" X 2" X 1/8" ANGLE BRACKETS. THROUGH-BOLT BRACKETS TO 'STRUT' WITH 3-1/4" DIA. BOLTS PER 'STRUT'. ATTACH BRACKET TO WALL WITH MIN. 5-3/8" DIA. HOLLOW WALL OR EXPANSION ANCHORS (PER SIDE OF 'STRUT') DEPENDING ON WALL SUBSTRATE.
 - WOOD SLATWALL PANEL. SEE SPECIFICATION SECTION 064000 AND 099101.
 - DECORATIVE PENDANT LIGHT FIXTURES, TYP. OF 3.
 - 5/4 PAINTED POPLAR CAP/EDGE TRIM, RIPPED AND SHAPED TO PROFILE INDICATED. PROVIDE GAP EDGE TRIM AT TOP AND BASE OF SLAT WALL PANELS AND WHERE PANELS ABUT END WALLS, BASE AND TOP CABINETS AND COUNTER TOP, SIDE AND BACK SPLASHES. SEE SPECIFICATION SECTIONS 064000 AND 099101.
 - CONTINUOUS 26" GA., 1 1/2" WIDE TOP AND BOTTOM RUNNER CHANNEL. SEE SPECIFICATION SECTION 09216.
 - 3/4" THICK PAINTED COMPOSITE WOOD SLATWALL PANELS WITH SLOTS AT 3" O.C. ATTACH TO STUD FURRING PER SLATWALL MANUFACTURER'S INSTALLATION INSTRUCTIONS. SEE SPECIFICATION SECTION 064000 AND 099101.
 - 26 GA., 1 1/2" METAL STUD FURRING AT 16" O.C. SEE SPECIFICATION SECTION 092216.
 - HOLLOW WALL FASTENER AT 12" O.C. MAX.
 - FINISH WALL SURFACE.



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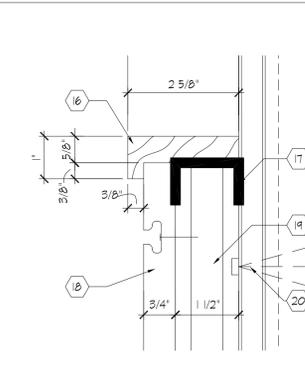
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	ADDENDUM #1		05/15/12

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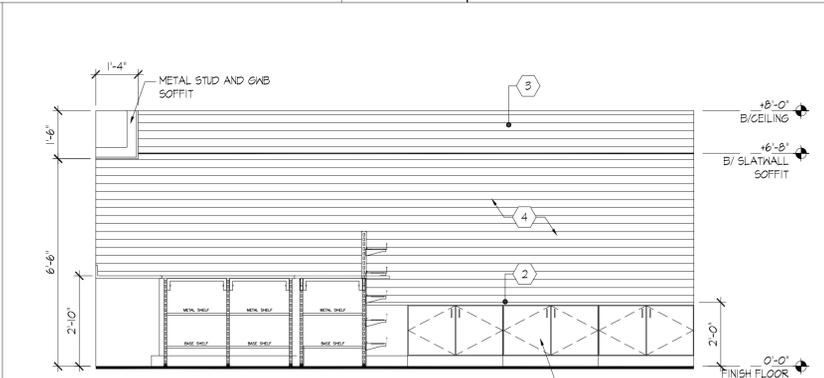
Drawn	Project Manager	P.I.C.
RMR	RMR	DWD

SHEET TITLE
REFLECTED CEILING PLAN / INTERIOR ELEVATIONS / DETAILS


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A102




E3 INT. DETAIL
6" = 1'-0"




E5 INTERIOR ELEVATION
3/8" = 1'-0"

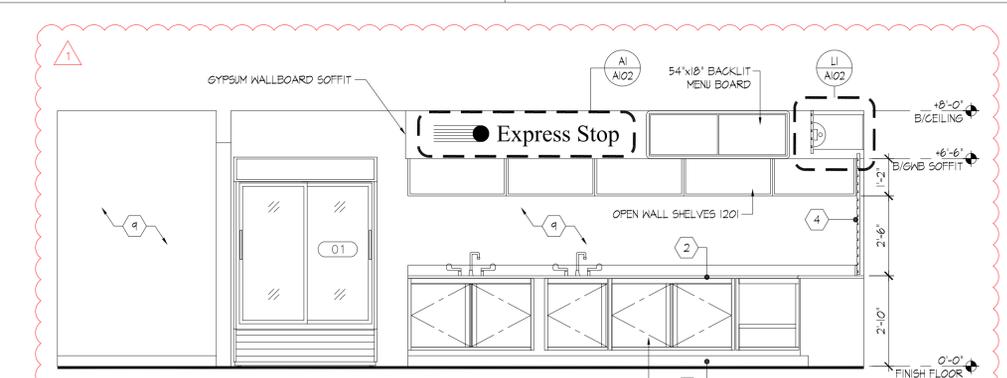


E10 INTERIOR ELEVATION
3/8" = 1'-0"

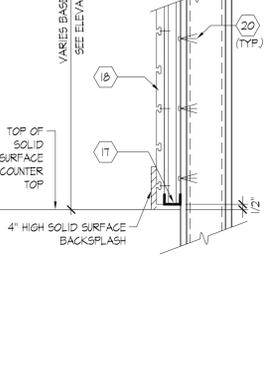


C1 INT. DETAIL
1 1/2" = 1'-0"

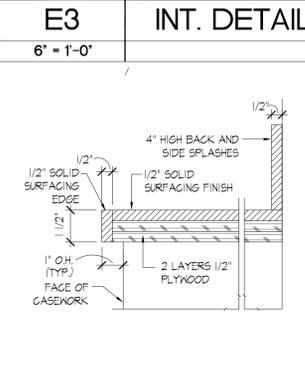

C3 INT. DETAIL
3" = 1'-0"

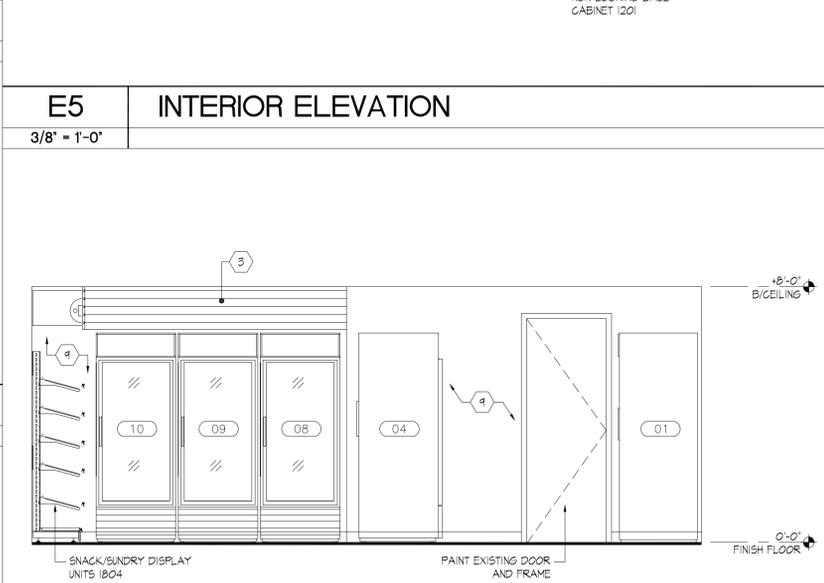

A5 INTERIOR ELEVATION
3/8" = 1'-0"

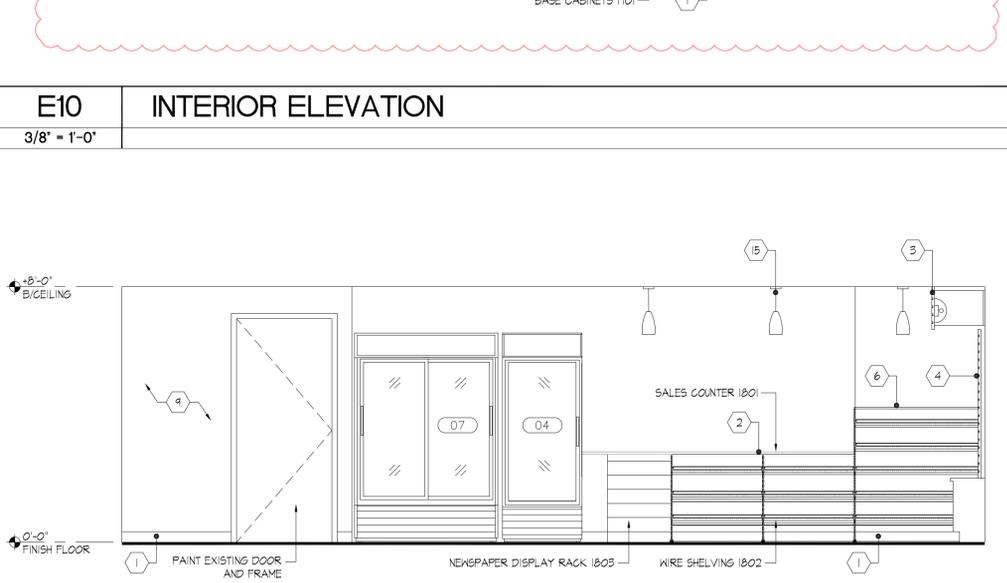


A10 INTERIOR ELEVATION
3/8" = 1'-0"




A1 SIGN LETTERING AND LOGO
3/8" = 1'-0"



A5 INTERIOR ELEVATION
3/8" = 1'-0"

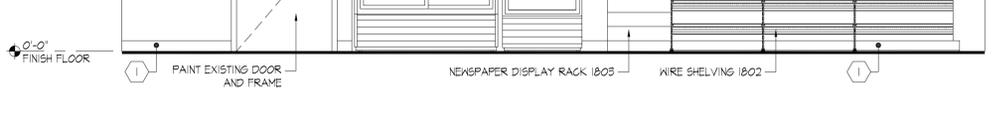


A10 INTERIOR ELEVATION
3/8" = 1'-0"

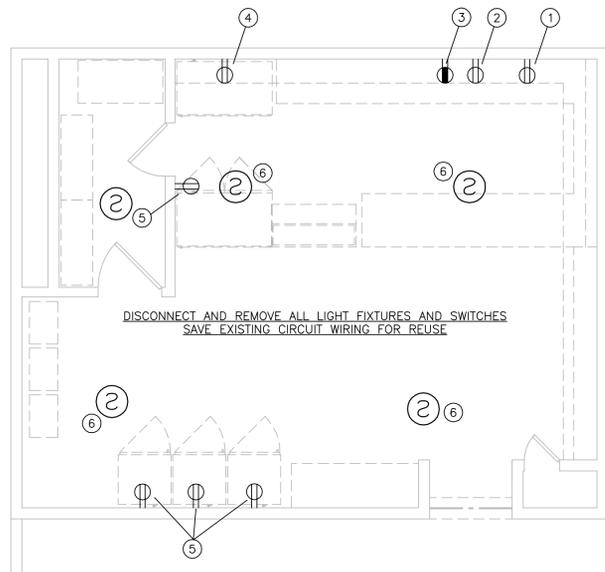

- DEMOLITION KEY NOTES**
- DISCONNECT EXISTING CIRCUIT FROM RECEPTACLE AND REPLACE WITH NEW CIRCUIT FROM NEW PANELBOARD.
 - DISCONNECT EXISTING CIRCUIT FROM RECEPTACLE AND REPLACE WITH NEW CIRCUIT FROM NEW PANELBOARD.
 - DISCONNECT EXISTING CIRCUIT FOR THE 30 AMP, 208 VOLT RECEPTACLE AND REPLACE WITH NEW 30 AMP CIRCUIT FROM NEW PANELBOARD.
 - DISCONNECT EXISTING CIRCUIT FROM RECEPTACLE AND REPLACE WITH NEW CIRCUIT FROM NEW PANELBOARD.
 - DISCONNECT AND REMOVE EXISTING RECEPTACLES AND WIRING. PROVIDE BLANK COVER ON BOX.
 - DISCONNECT AND REMOVE EXISTING SMOKE DETECTORS. SAVE FOR REUSE.
- GENERAL DEMOLITION NOTE**
- REMOVE THE WIRING TO THE FIRST JUNCTION BOX ON CEILING. REMOVE THE CIRCUIT FROM THE BREAKER IN THE PANELBOARD AND LABEL THE WIRES IN THE PANEL AND IN THE JUNCTION BOX AS SPARE. INDICATE ON THE PANELBOARD DIRECTORY WHICH CIRCUITS ARE SPARE IN ROOM NUMBER.




- LEGEND**
- ⊕ DUPLEX GROUNDING RECEPTACLE, NEMA 5-20R, 125VAC, 20A, 2P, 3W, 18" AFF UNLESS NOTED OTHERWISE
AC - ABOVE COUNTERTOP
BC - BELOW COUNTERTOP
 - ⊕ 30A, 208VAC, 2P, 3W RECEPTACLE
AC - ABOVE COUNTERTOP
BC - BELOW COUNTERTOP
 - ⊕ DISCONNECT SWITCH, NON-FUSED, 30A, 2P, NEMA 3R
 - ⊕ ELECTRICAL DEVICE POWER CONNECTION
 - ⬇ 208Y/120VAC, 3 PHASE, 4-WIRE, 125 AMP, 42 CIRCUIT PANELBOARD WITH 125 AMP MOLDED CASE SWITCH FOR MAIN BREAKER
 - ⬇ TELEPHONE CABLE DROP
 - A 2'x2' FLUORESCENT BASKET TYPE FIXTURE, w/EXTRUDED 3-PIECE SMOOTH FROSTED ACRYLIC DIFFUSERS, AND FROSTED LINEAR PRISM CENTER DIFFUSER, (2) 17 WATT, T8 LAMPS, UNIVERSAL VOLTAGE, (2) FIXTURES WITH DIMMING BALLAST
BASIS OF DESIGN: NULITE LIGHTING, L2D SERIES CAT #L2D217T8UNVISN & (2) #L2D217T8UNVDIM
 - B 2'x4' FLUORESCENT BASKET TYPE FIXTURE, w/EXTRUDED 3-PIECE SMOOTH FROSTED ACRYLIC DIFFUSERS, AND FROSTED LINEAR PRISM CENTER DIFFUSER, (2) 32 WATT, T8 LAMPS, UNIVERSAL VOLTAGE, (1) 2-LAMP ELECTRONIC BALLAST
BASIS OF DESIGN: NULITE LIGHTING, L2D SERIES CAT #L2D232T8UNVISN
 - C FLUORESCENT STRIP FIXTURE, 4' LONG, (1) 32 WATT, T8 LAMP, ELECTRONIC BALLAST. MOUNT IN COVE AREA. SEE ARCHITECTURAL DRAWINGS FOR EXACT LOCATIONS.
BASIS OF DESIGN: METALUX SNF SERIES CAT #SNF132UNVEB8
 - D PENDANT MOUNTED DOWN LIGHT, 277VAC, COMPACT FLUORESCENT 7'-0" AFF, MONO-POINT MOUNT w/INTEGRAL 12V TRANSFORMER,
BASIS OF DESIGN: WAC LIGHTING CAT #QP524-AM/BN
 - E PENDANT MOUNTED TRACK LIGHT, 120V, 7'-0" AFF
BASIS OF DESIGN: BRUCK TYPE V/A LOW VOLTAGE TRACK SYSTEM, 78" LG, CAT #160032MCGY w/CALO SWING SPOT LTS, MR-16 LAMPS, CAT #60740MCGY, FURNISH AND INSTALL TRACK, CORD, XFMR AND ASSOCIATED HARDWARE
 - \$a SINGLE POLE WALL SWITCH - 120/277V, 20A, 48" AFF TO CENTER UOI LOWER CASE LETTER INDICATES SWITCHING ARRANGEMENT
 - \$Dc DIMMER WALL SWITCH - 120/277V, 20A, 48" AFF TO CENTER UOI LOWER CASE LETTER INDICATES SWITCHING ARRANGEMENT

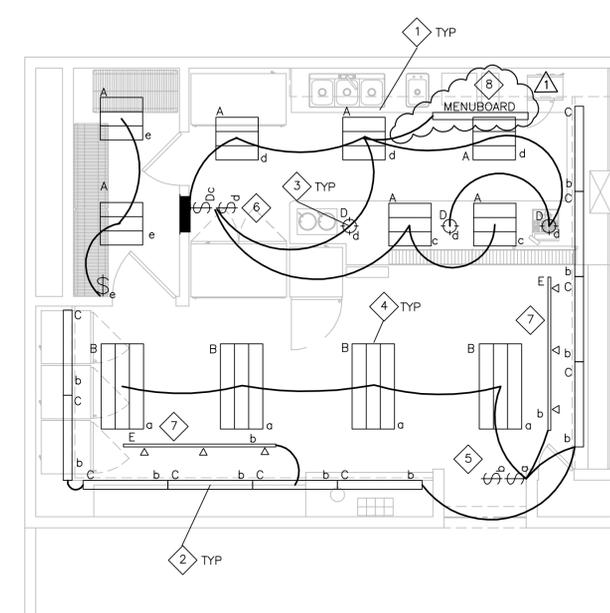

- CONSTRUCTION LIGHTING KEY NOTES**
- FURNISH AND INSTALL (7) NEW 2'x2" BASKET TYPE LIGHT FIXTURES. MOUNT TO EXISTING CEILING GRID SYSTEM.
 - FURNISH AND INSTALL NEW 4' LG COVE LIGHTS. REFER TO ARCHITECTURAL DRAWINGS FOR EXACT LOCATIONS.
 - FURNISH AND INSTALL NEW PENDANT DOWN LIGHTS. REFER TO ARCHITECTURAL DRAWINGS FOR EXACT LOCATIONS.
 - FURNISH AND INSTALL (4) NEW 2'x4' BASKET TYPE LIGHT FIXTURES. MOUNT TO EXISTING CEILING GRID SYSTEM.
 - FURNISH AND INSTALL (2) NEW WALL SWITCHES WHERE SHOWN, ONE TO CONTROL COVE LIGHTS AND ONE TO CONTROL THE ROOM LIGHTS.
 - FURNISH AND INSTALL (1) NEW WALL SWITCH TO CONTROL NEW PENDANT DOWN LIGHTS, AND (1) NEW DIMMER WALL SWITCH TO CONTROL THE 2'x2' FIXTURES WHERE SHOWN.
 - FURNISH AND INSTALL NEW PENDANT MOUNTED LOW VOLTAGE TRACK LIGHT SYSTEM.
 - CONNECT THE NEW MENUBOARD TO THE EXISTING LIGHTING CIRCUIT IN ROOM. MENUBOARD TO BE SWITCHED WITH ROOM LIGHTS.



E1 CONCESSION ELECTRICAL DEMOLITION PLAN
1/4" = 1'-0"

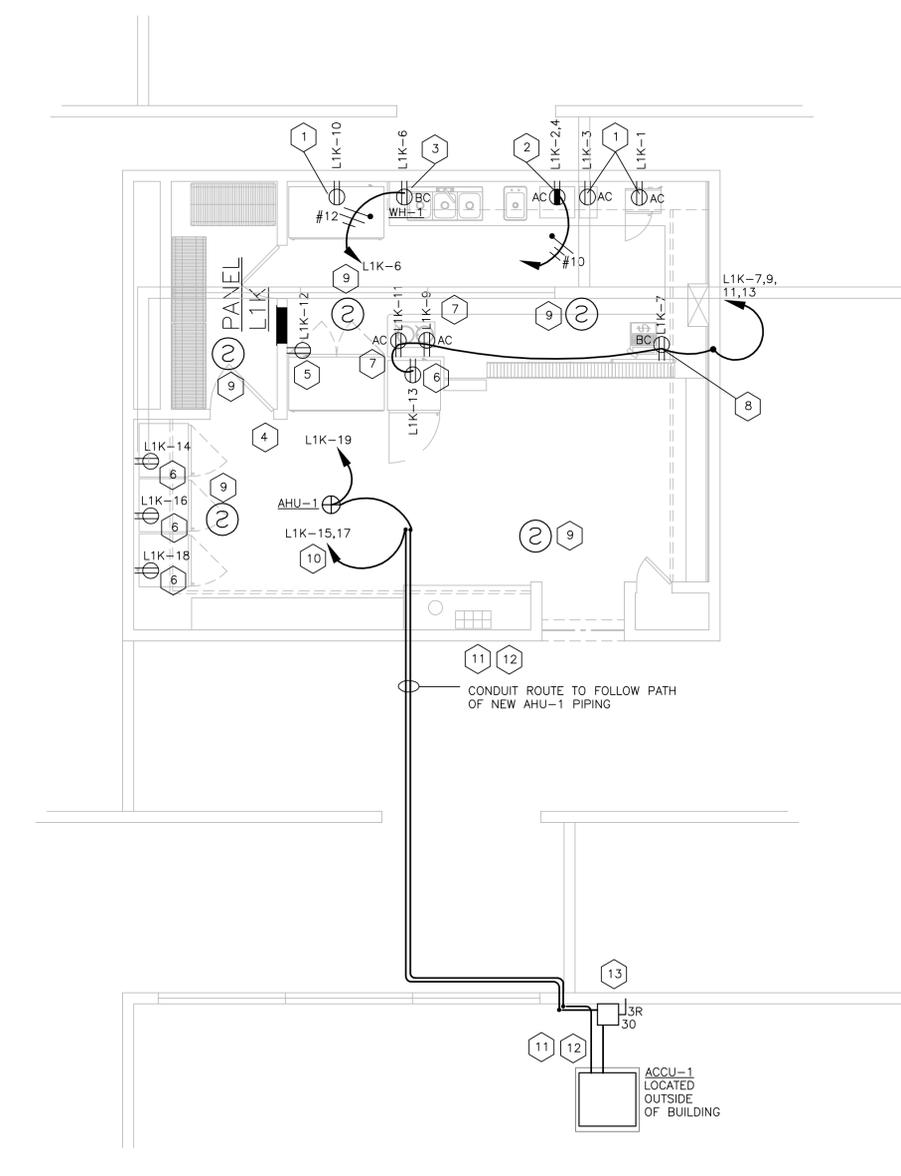

- CONSTRUCTION POWER KEY NOTES**
- FURNISH AND INSTALL NEW RECEPTACLE IN EXISTING BOX AND RECONNECT TO NEW CIRCUIT FROM PANEL L1K.
 - FURNISH AND INSTALL NEW 30 AMP, 208 VOLT, 2P, 3W RECEPTACLE IN EXISTING BOX AND RECONNECT TO NEW CIRCUIT FROM PANEL L1K.
 - FURNISH AND INSTALL 1P, 3W, 20 AMP, 120 VOLT CIRCUIT FOR HOT WATER HEATER UNDER COUNTERTOP.
 - FURNISH AND INSTALL 2 #12 AWG AND 1 #12 AWG GROUND IN 3/4" CONDUIT FOR A 120V, 20A, 1 PHASE CIRCUIT FROM PANELBOARD L1K TO AHU-1.
 - FURNISH AND INSTALL NEW DUPLEX RECEPTACLE 12" AFF. CIRCUIT TO NEW PANEL L1K.
 - FURNISH AND INSTALL NEW DUPLEX RECEPTACLE 18" AFF. CIRCUIT TO NEW PANEL L1K.
 - FURNISH AND INSTALL NEW DUPLEX RECEPTACLE ABOVE COUNTERTOP. CIRCUIT TO NEW PANEL L1K.
 - FURNISH AND INSTALL NEW DUPLEX RECEPTACLE UNDER COUNTERTOP FOR CASH REGISTER, TO NEW PANEL L1K.
 - REINSTALL AND RECONNECT SMOKE DETECTORS SAVED FROM DEMOLITION PHASE.
 - FURNISH AND INSTALL A 208V, 1 PHASE, 15 AMP CIRCUIT FROM PANELBOARD L1K TO ACCU-1.
 - FURNISH AND INSTALL 2 #12 AWG AND 1 #12 AWG GROUND IN 3/4" CONDUIT FROM PANELBOARD L1K TO HEAT PUMP ACCU-1 NEMA 3R DISCONNECT SWITCH LOCATED OUTSIDE OF BUILDING.
 - FURNISH AND INSTALL 3 #14 AWG FROM ACCU-1 TO AHU-1. MAKE ALL CONNECTIONS TO AHU-1.
 - FURNISH AND INSTALL A NEMA 3R, 30A DISCONNECT SWITCH FOR ACCU-1. MOUNT ON EXTERIOR WALL.



E2 CONCESSION ELECTRICAL POWER PLAN
1/4" = 1'-0"

E3 CONCESSION ELECTRICAL LIGHTING PLAN
1/4" = 1'-0"

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CLIENT
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COMMISSIONER FOR THE BLIND AND VISUALLY HANDICAPPED

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OGS PROJECT # 44343-C

DDA PROJECT # 11-007

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SYMB	ISSUED FOR	BY	DATE
	BID DOCUMENTS	JR	03/28/12
	ADDENDUM #1	JR	05/15/12

Stamp

Drawn EA/JMR	Project Manager JRY	P.I.C.
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SHEET TITLE
ELECTRICAL PLANS

SHEET NUMBER
E-101