

STATE OF NEW YORK OFFICE OF GENERAL SERVICES DESIGN AND CONSTRUCTION GROUP THE GOVERNOR NELSON A. ROCKEFELLER EMPIRE STATE PLAZA ALBANY, NY 12242



ADDENDUM NO. 5 TO PROJECT NO. 44671

CONSTRUCTION WORK, PLUMBING WORK, ELECTRICAL WORK REPLACE PLUMBING, C-BLOCK BUILDING 20 ELMIRA CORRECTIONAL FACILITY 1879 DAVIS STREET ELMIRA, NY

May 14, 2015

NOTE: This Addendum forms a part of the Contract Documents. Insert it in the Project Manual. Acknowledge receipt of this Addendum in the space provided on the Bid Form.

CONSTRUCTION WORK: DRAWINGS

- 1. Delete Drawing Number A-001 in its entirety and replace with Revised Drawing A-001 dated May 13, 2015.
- 2. Delete Drawing Number A-103 in its entirety and replace with Revised Drawing A-103 dated May 13, 2015.
- 3. Delete Drawing Number A-104 in its entirety and replace with Revised Drawing A-104 dated May 13, 2015.
- 4. Delete Drawing Number A-106 in its entirety and replace with Revised Drawing A-106 dated May 13, 2015.
- 5. Contractor Staging Area is located outside the building in the area identified in attached Sketch SK-01.

PLUMBING WORK: SPECIFICATIONS

1. Page 224200-9: Delete ARTICLES 2.09 and 2.10 in their entirety and replace with the following:

"2.09 STAINLESS STEEL WATER CLOSETS PENAL FIXTURES

- A. Contractor shall field verify the dimensional installation requirements for each unit for each cell prior to Submittal. Contractor shall indicate in the Submittal that all field measurements for installation have been verified.
- B. Acorn Engineering Company Model #1675-W-1-ULF-EFV1.6-FVT-CO1-3/PC- FTA-PH-MT, as shown on drawings. Security Type Water Closet with the following features:

- 1. Toilet:
 - a. Water consumption 1.6 gallons of water or less per flush.
 - b. Blowout type, concealed wall supply, off floor mounting, wall outlet.
 - c. Seamless welded Type 304 stainless steel construction, with satin finish exterior except integral contoured seat shall have sanitary high polished finish.
 - d. Anti-flood automatic reset.
 - e. Provide float controlled operated flush valve.
 - f. Recessed paper holder which accommodates standard sized rolls.
 - g. Trap: Minimum 3-1/2 inch seal, capable of passing a 2-1/8 inch ball. Waste outlet 2-3/8 inch diameter stainless steel, plain end.
 - h. Cleanout: Cleanout with o-ring connection to nu-hub with pinned cleanout plug. Modify sanitary piping as required to make connections.
- 2. Fixture shall withstand loadings up to 3,000 lbs with no measurable deflection, and loadings up to 3,000 lbs with no permanent damage.
- 3. Four point anchoring system required fasteners, all as furnished by fixture manufacturer.
 - a. Use vandal resistant fasteners if and where exposed.

2.10 STAINLESS STEEL LAVATORY PENAL FIXTURES

- A. Contractor shall field verify the dimensional installation requirements for each unit for each cell prior to Submittal. Contractor shall indicate in the Submittal that all field measurements for installation have been verified.
- B. Acorn Engineering Company Model #1652-1-BP-EVS1-LW1-MT, as shown on drawings. Security Type Lavatory with the following features:
 - 1. Oval bowl.
 - 2. Penal type bubble / filler.
 - 3. Electronically operated cold water push-button valve, requiring less than 5 lbs. force to activate.
 - 4. Lavatory waste with thru-walls extension, "P" –trap and cleanout.

2.11 TEMPLATES

A. Provide for wall-mounted stainless steel penal type fixtures."

2. Page 221100-7 – ARTICLE 3.07, PARAGRAPH B: Revise ITEM 2 as follows:

"2. 4 inch and Over: <u>Galvanized Steel Schedule 40 pipe with flanged</u> <u>fittings</u>. Threaded fittings allowed <u>except</u> for grooved piping."

PLUMBING WORK: DRAWINGS

- 1. Delete Drawing Number P-001 in its entirety and replace with Revised Drawing P-001 dated May 13, 2015.
- 2. Delete Drawing Number P-102 in its entirety and replace with Revised Drawing P-102 dated May 13, 2015.

- 3. Delete Drawing Number P-103 in its entirety and replace with Revised Drawing P-103 dated May 13, 2015.
- 4. Delete Drawing Number P-104 in its entirety and replace with Revised Drawing P-104 dated May 13, 2015.
- 5. Delete Drawing Number P-105 in its entirety and replace with Revised Drawing P-105 dated May 13, 2015.
- 6. Delete Drawing Number P-401 in its entirety and replace with Revised Drawing P-401 dated May 13, 2015.
- 7. Delete Drawing Number P-402 in its entirety and replace with Revised Drawing P-402 dated May 13, 2015.
- 8. Delete Drawing Number P-403 in its entirety and replace with Revised Drawing P-403 dated May 13, 2015.
- 9. Delete Drawing Number P-404 in its entirety and replace with Revised Drawing P-404 dated May 13, 2015.
- 10. Delete Drawing Number P-405 in its entirety and replace with Revised Drawing P-405 dated May 13, 2015.

ELECTRICAL WORK: DRAWINGS

- 1. Delete Drawing Number E-001 in its entirety and replace with Revised Drawing E-001 dated May 13, 2015.
- 2. Delete Drawing Number E-101 in its entirety and replace with Revised Drawing E-101 dated May 13, 2015.
- 3. Delete Drawing Number E-102 in its entirety and replace with Revised Drawing E-102 dated May 13, 2015.

END OF ADDENDUM

Margaret F. Larkin Executive Director

PLUMBING NOTES:

- 1. PLUMBING CONTRACTOR SHALL CONSULT WITH, COOPERATE AND COORDINATE WITH THE CONSTRUCTION CONTRACTOR, ELECTRICAL CONTRACTOR, AND ETC. IN ORDER TO MINIMIZE INTERFERENCES BETWEEN TRADES DURING PERFORMANCE OF THIS WORK.
- 2. THE PLUMBING CONTRACTOR SHALL PERFORM ALL TESTS AND ARRANGE FOR ALL INSPECTIONS FOR WORK UNDER THE P-CONTRACT AS REQUIRED.
- 3. THE PLUMBING CONTRACTOR SHALL MAKE ALL FINAL CONNECTIONS TO ALL PLUMBING EQUIPMENT REGARDLESS WHETHER ILLUSTRATED HEREIN, WITHOUT ANY ADDITIONAL COSTS.
- 4. PLUMBING CONTRACTOR SHALL PERFORM ALL CUTTING, EXCAVATION, BACK FILLING, ROUGH AND FINISH PATCHING AS PER THE SPECIFICATIONS AS REQUIRED FOR THE INSTALLATION OF THE WORK, UNLESS NOTED OTHERWISE.
- 5. ALL CONNECTIONS TO EQUIPMENT SHALL BE SIZED AND INSTALLED IN ACCORDANCE WITH THE MANUFACTURER'S INSTRUCTIONS.
- 6. WATERPROOF PIPE SLEEVES SHALL BE INSTALLED AT ALL PENETRATIONS THROUGH EXTERIOR WALLS. PIPE SLEEVES SHALL BE INSTALLED AT ALL WALL PENETRATIONS THROUGH INTERIOR WALLS AND FLOORS. ALL PIPING PENETRATIONS TO BE SEALED AROUND WITH FIRE SEALANT.
- 7. REFER TO THE ARCHITECTURAL PLANS FOR ALL STRUCTURAL DIMENSIONS.
- 8. THE INTENT OF THE SPECIFICATION AND THE DRAWINGS IS TO PROVIDE A COMPLETE AND FULLY OPERATIONAL PLUMBING SYSTEM. ALL LABOR, MATERIALS, TOOLS, EQUIPMENT, TRANSPORTATION, HOISTING AND RIGGING, ETC., NECESSARY TO COMPLETE THE PLUMBING WORK SHALL BE INCLUDED IN PLUMBING CONTRACTORS BID.
- 9. PLUMBING WORK IS INDICATED DIAGRAMMATICALLY. EXACT LOCATION OF ALL COMPONENTS ARE TO BE DETERMINED IN THE FIELD AND BY THE ACTUAL BUILDING CONDITIONS. COORDINATION WITH OTHER CONTRACTS WILL BE REQUIRED FOR FIXTURE LAYOUT.
- 10. CONTRACTOR SHALL PROVIDE ALL WORK NECESSARY TO OBTAIN ALL PERMITS FOR THE COMPLETE INSTALLATION OF THE PLUMBING WORK.

PHASING:

THE SCOPE OF WORK AT ELMIRA CORRECTIONAL FACILITY, BUILDING 20 INCLUDES THE FOLLOWING WHILE MAINTAINING FULL PLUMBING SERVICE IN THE FULLY OCCUPIED FACILITY: REPLACE EXISTING PLUMBING FIXTURES, PLUMBING SOIL, WASTE AND VENT STACKS. REPLACE EXISTING DOMESTIC COLD, HOT AND RECIRCULATION RISERS AND MAINS.

THE SCOPE OF WORK WILL BE ACCOMPLISHED BY PROVIDING PARALLEL RISERS AND STACKS WITH TEMPORARY PLUGGED SOIL WASTE; VENT, VALVED, AND CAPPED WATER CONNECTIONS; MAIN DOMESTIC COLD, HOT AND RECIRCULATION MAINS; AND MAIN SOIL PIPING IN THE BASEMENT UTILITY CORRIDOR EXTENDING OUTSIDE THE BUILDING FOR FINAL CONNECTION.

PROVIDE HORIZONTAL WASTE, DOMESTIC WATER MAINS IN THE BASEMENT THAT CONNECT OUTSIDE OF THE BUILDING, WITH THE WASTE AND DOMESTIC COLD WATER CONNECTING TO EXISTING SANITARY SEWER AND COLD WATER MAINS OUTSIDE THE BUILDING. DUE TO INADEQUATE BASEMENT DRAINAGE, REDUCED PRESSURE ZONE BACKFLOW PREVENTERS CANNOT BE INSTALLED. THEREFORE, DOUBLE CHECK VALVES BE PROVIDED FOR BOTH THE FIRE AND COLD WATER SERVICE ENTRANCES.

PHASE 2: PROVIDE WASTE AND VENT STACKS AND DOMESTIC COLD WATER RISERS ADJACENT TO THE EXISTING 1939 RISERS IN THE CELL BLOCK AREAS. THESE STACKS AND RISERS ARE IDENTIFIED AS WET COLUMNS A-1 AND A-2, B-1 AND B-2 C-1 AND C-2 AND D-1 AND D-2. ELECTRIC CONTRACTOR TO BEGIN INSTALLATION OF ELECTRONIC FIXTURE CONTROL SYSTEM.

<u>PHASE 3:</u> BEGINNING AT THE BOTTOM OF WET COLUMNS A-1 AND C-1:

- CONSTRUCTION CONTRACT: REPAIRS, REMOVALS AND ABATEMENT OF LEAD CONTAINING MATERIALS, WET COLUMN A-1, CELLS 1-55 TO 1-62, 2-55 TO 2-62. B. CONSTRUCTION CONTRACT WORK AS ABOVE: FOR WET COLUMN C-1, CELLS 1-1 TO 1-8.
- PLUMBING CONTRACT: AT WET COLUMN A-1, CELLS 1-55 TO 1-62 REMOVE EXISTING WATER CLOSET, LAVATORY, AND RELATED PIPING; REMOVE AND STORE EXISTING PIN TRAPS, INSTALL FIXTURES TO BRANCH SOIL AND WATER PIPING CONNECTING TO VALVED AND PLUGGED OUTLETS LEFT IN PHASE 1. REINSTALL PIN TRAPS, ELECTRIC CONTRACT TO CONTINUE INSTALLATION OF ELECTRONIC FIXTURE CONTROL SYSTEM.
- CONSTRUCTION CONTRACT WORK AS ABOVE: WET COLUMN A-1, CELLS 2-55 TO 2-62 PLUMBING AND ELECTRIC CONTRACT WORK AS ABOVE: WET COLUMN C-1, CELLS 1-1 TO 21.
- CONSTRUCTION CONTRACT WORK AS ABOVE: WET COLUMN C-1, CELLS 2-1 TO 2-8. PLUMBING AND ELECTRIC CONTRACT WORK AS ABOVE: WET COLUMN A-1, CELLS 2-55 TO 2-62. D. CONTINUE CONSTRUCTION AND PLUMBING CONTRACT WORK: WET COLUMNS A-1 AND C-1 TO THE TIER 3 AND 4 LEVELS E. CELLS.

<u>PHASE 4:</u> CONTINUE CONSTRUCTION ELECTRIC AND PLUMBING CONTRACT WORK AT WET COLUMNS A-2 AND C-2.

<u>PHASE 5:</u> CONTINUE CONSTRUCTION ELECTRIC AND PLUMBING CONTRACT WORK AT WET COLUMNS B-1 AND D-1.

PHASE 6: A. CONTINUE CONSTRUCTION ELECTRIC AND PLUMBING CONTRACT WORK FOR WET COLUMNS B-2 AND D-2. B. PLUMBING CONTRACT: ADJACENT TO WET COLUMN D-2.

<u>PHASE 7:</u> AT WET COLUMNS G AND H:

- A. CONSTRUCTION CONTRACT: REMOVALS, REPAIRS AND ABATEMENT OF LEAD CONTAINING MATERIALS IN CELLS 1-63 TO 1-67, JANITOR'S ROOM 1-82 AND SECOND AND FOURTH TIER CORRECTIONAL OFFICERS TOILET ROOMS 2-72 AND 4 - 72
- B. PLUMBING CONTRACT: REMOVE EXISTING WATER CLOSETS LAVATORIES AND EXISTING LOCAL PIPING IN CELLS 1-63 TO 1-67. REMOVE EXISTING SERVICE SINK IN JANITOR'S ROOM 1-82. REMOVE WATER CLOSETS AND LAVATORY IN SECOND AND FOURTH TIER CORRECTIONAL OFFICERS' TOILET ROOMS 2-72 AND 2-74. PROVIDE SOIL AND VENT STACKS AND DOMESTIC COLD, HOT AND RECIRCULATION RISERS UTILIZING EXISTING FLOOR PENETRATIONS. PROVIDE WATER CLOSETS AND LAVATORIES IN SECOND AND FOURTH TIER CORRECTIONAL OFFICERS' TOILET ROOMS 2-72 AND 4-74. PROVIDE DOMESTIC WATER COOLERS ADJACENT TO CORRECTIONAL OFFICERS' TOILET ROOMS ON THE SECOND AND FOURTH TIERS. CONNECT SOIL STACK AND WATER RISERS TO NEW MAINS IN THE BASEMENT UTILITY CORRIDOR.

PHASE 8: AT WET COLUMNS G AND H:

- CONSTRUCTION CONTRACT: REMOVALS, REPAIRS AND ABATEMENT OF LEAD CONTAINING MATERIALS IN CELLS1-68 TO 1-72 AND CORRECTIONAL OFFICERS TOILET ROOM 1-86. Α.
- B. PLUMBING CONTRACT: REMOVE EXISTING WATER CLOSETS AND LAVATORIES. PROVIDE STAINLESS STEEL WATER CLOSETS AND LAVATORIES IN CELLS, AND WATER CLOSET AND LAVATORY IN CORRECTIONAL OFFICERS' TOILET ROOM.

<u>PHASE 9:</u> AT WET COLUMN E:

CONSTRUCTION CONTRACT: REMOVALS, REPAIR AND ABATEMENT OF LEAD CONTAINING MATERIALS. TIERS 1 TO 4. Α. B. PLUMBING CONTRACT: PROVIDE WASTE STACK, VENT STACK & DOMESTIC HOT, COLD & RECIRCULATING RISERS TIERS 1 TO 4 INCLUDING IN ROOMS 1-81, 2-70, 3-63 & 4-70. PROVIDE MOP SERVICE SINK , SHOWER & FLOOR DRAIN IN ROOMS 1-81, 2-70, 3-63 & 4-70. REMOVE EXISTING RISERS & STACKS AS PER PHASE 11. C. CONSTRUCTION CONTRACT: ENCLOSE WET COLUMN IN PIPE SPACE FLOORS 1 THROUGH 4.

<u>PHASE 10:</u> AT WET COLUMN F:

- CONSTRUCTION CONTRACT: AS PER PHASE 9 ABOVE. PLUMBING CONTRACT: AS PER PHASE 9 ABOVE.
- PLUMBING CONTRACT: ADJACENT TO WET COLUMN F.

PHASE 11: PLUMBING CONTRACT: REMOVAL OF ALL NON-ESSENTIAL WATER, WASTE, SOIL AND VENT PIPING. ABANDON EXISTING BELOW GRADE SOIL & FAI PIPING WHERE INDICATED ON DRAWINGS.

SYMBOLS:

	ABOV SANII UNDE SANII DOME WATE DOME SUPP DOME CIRCL
	VENT
o	PIPE
`	PIPE
	TEE 1
3>	HAND ACCE
ס	FLOO
 >o	TRAP
þ	CLEA
↓	FLUSI STOP

DVE GROUND NITARY PIPING DER SLAB NITARY LINE	•
MESTIC COLD TER SUPPLY LINE	ÞO
MESTIC HOT WATER PPLY LINE	÷
MESTIC HOT WATER CULATING LINE	
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JF VALVE	• 🖸 •
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•	DOMESTIC WATER DROP TO FIXTURE PIPE CAP	П Т	WATER
ÞO	MIXING VALVE/ SHOWER HEAD ASSEMBLY	- _{CO}	CLEAN
•	COMBINATION BALANCING AND SHUT-OFF VALVE (DHW CIRCULATING)	_≯ ■	STRAI
δ	BALL VALVE	Ķ	SHOW
Z	CHECK VALVE		24x24 SERVI
⊠ T	GATE VALVE		WALL
ы	STOP VALVE REDUCER	മ	FLOOF CLOSE
ų	UNION	Ø	TYPE
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с	PIPE ELBOW DOWN	$\langle \rangle$	-FVT-
•⊙• <u>* * * * * * * * *</u> 	MIXING VALVE REMOVE PIPING		LAVA ⁻ ACORI MODE
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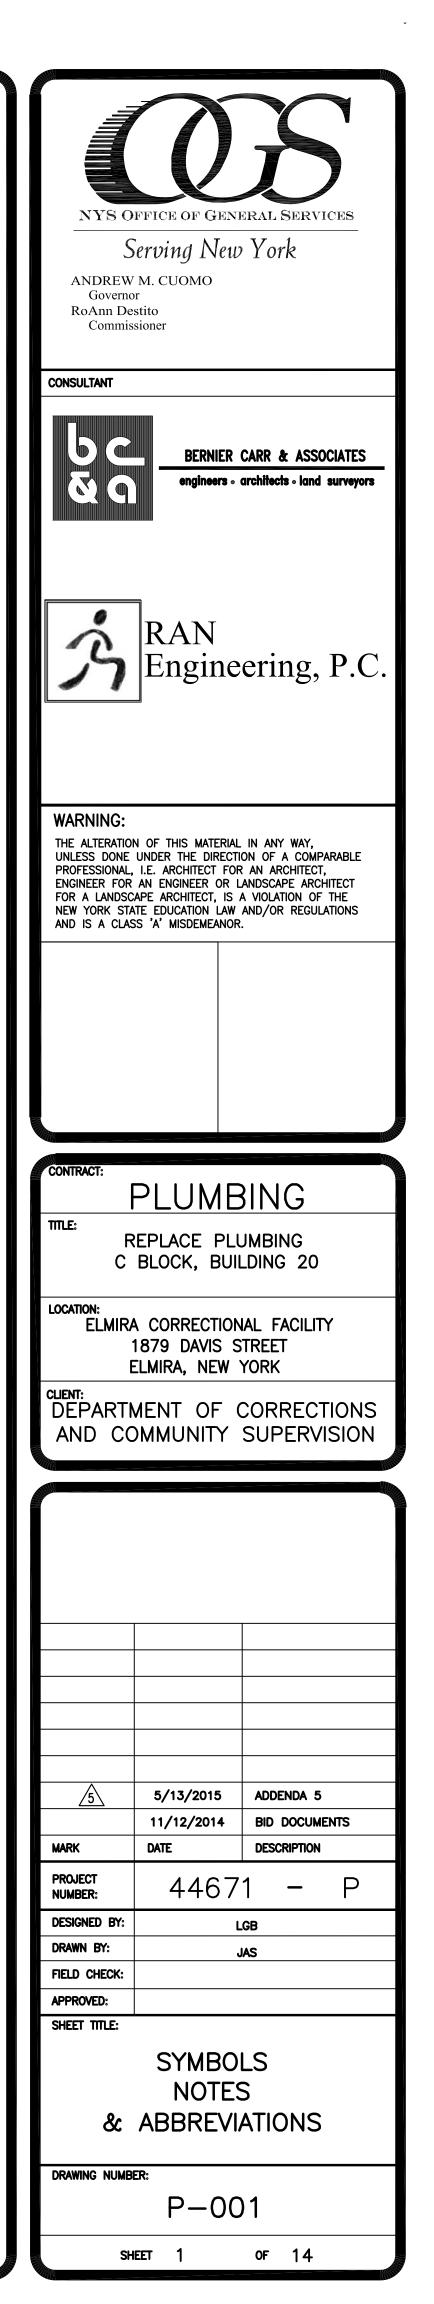
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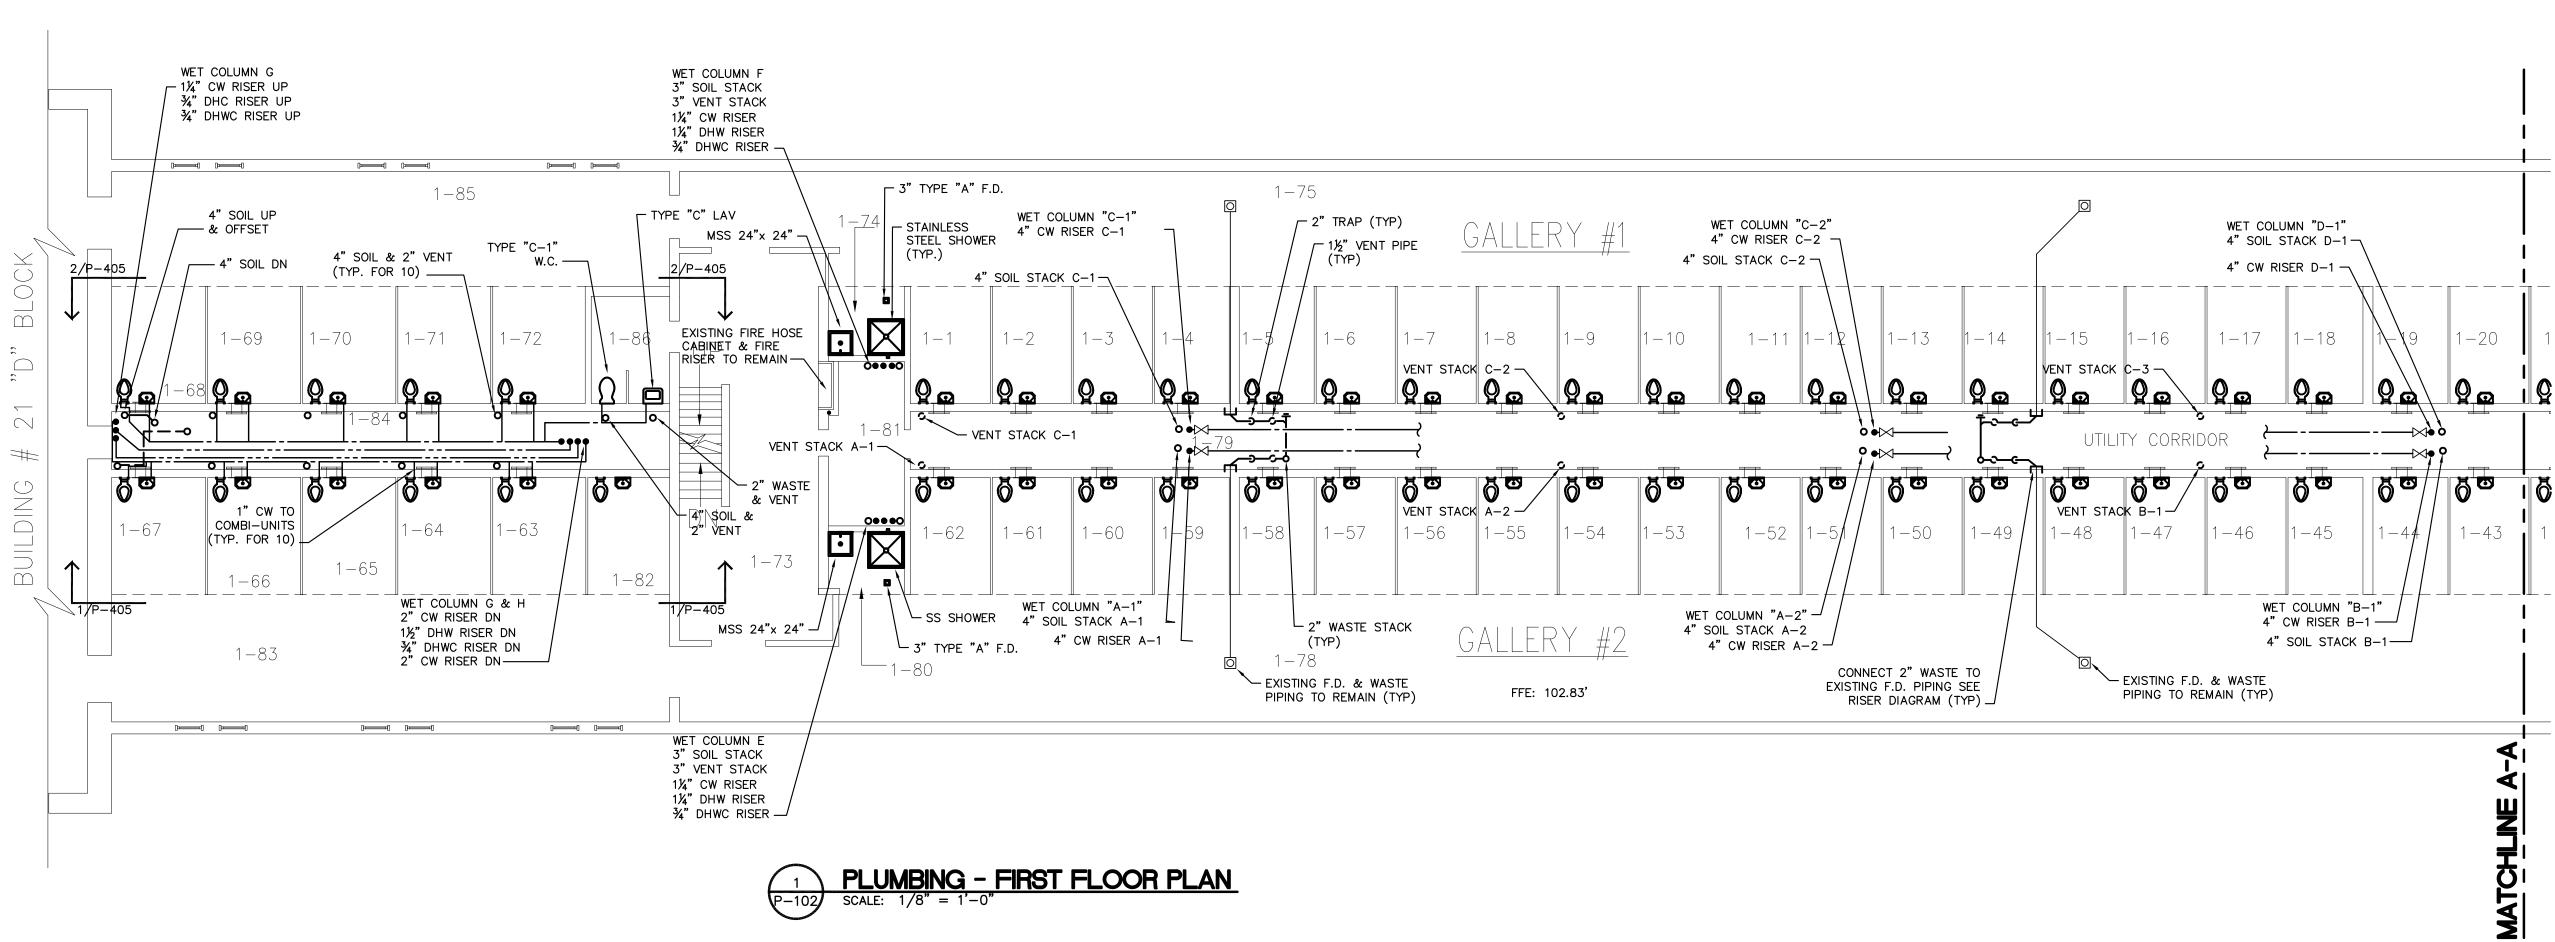
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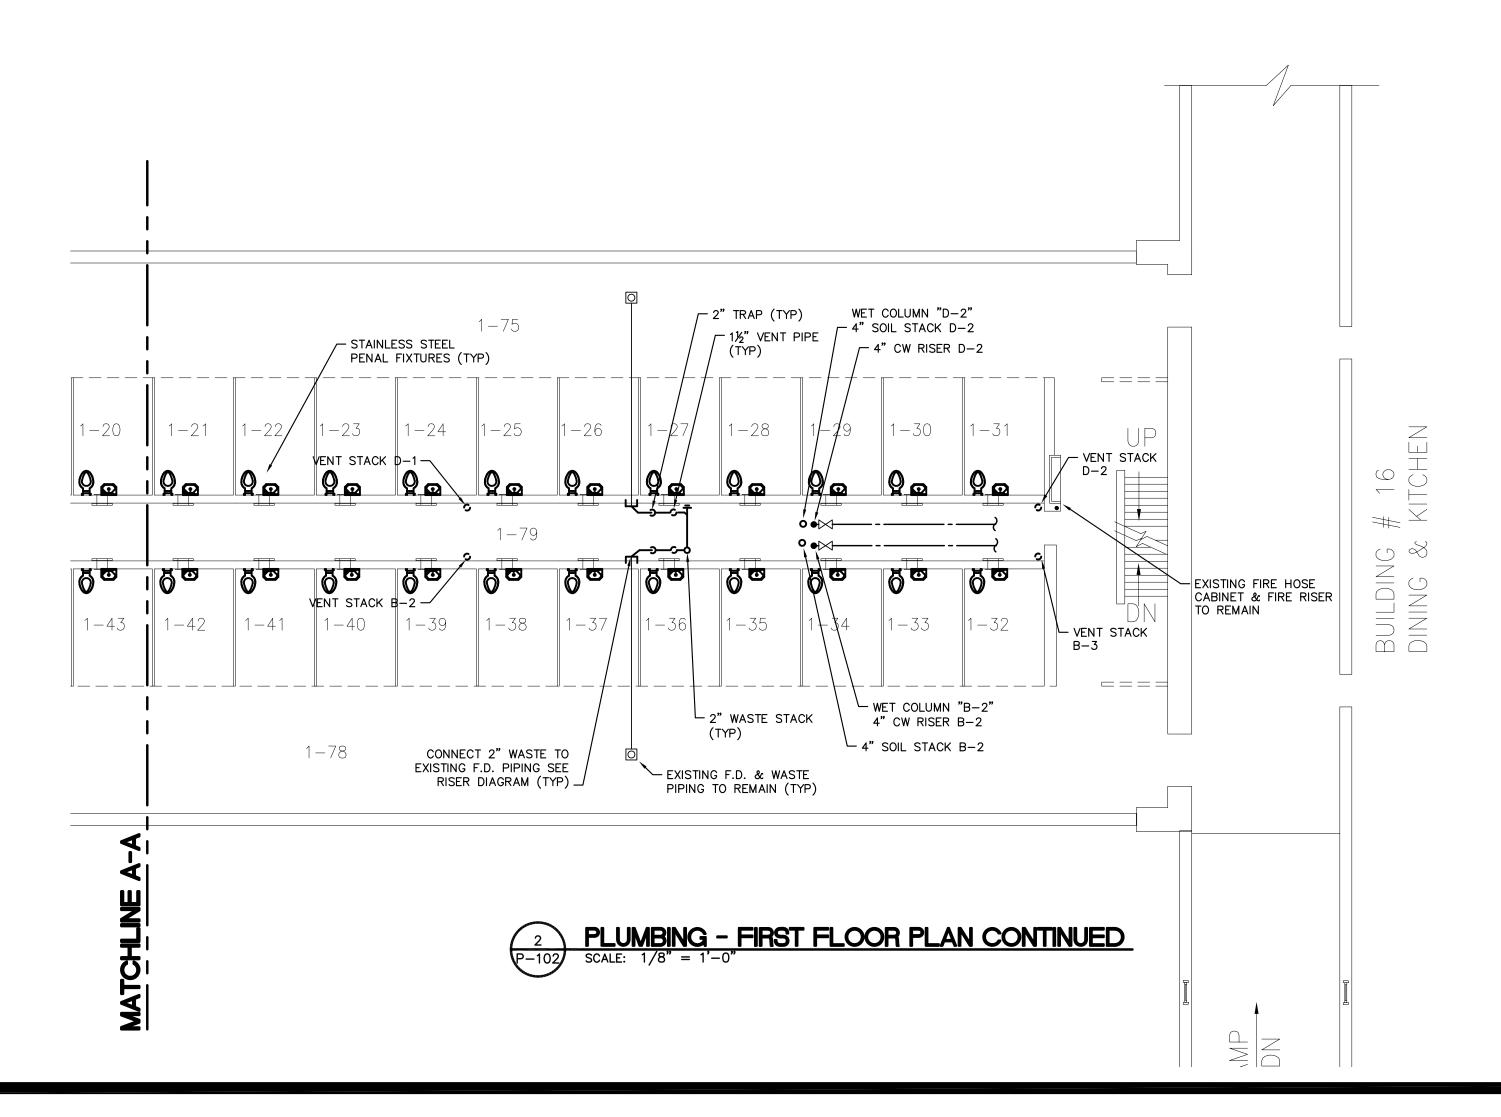
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LEAN OUT	
STRAINER	
SHOWER	
	B
24x24 MOP SERVICE SINK	(
WALL HUNG LAVATORY	~
ELOOR MOUNTED WATER CLOSET WITH FLUSH TANK	c c
TYPE "C-1" WATER CLOSET	С
WATER CLOSET (ELEV.) ACORN ENGINEERING COMPANY MODEL# 1675-W-1-ULF-EFV1.6 -FVT-C01-3/PC-FTA-PH-MT	
LAVATORY (ELEV.) ACORN ENGINEERING COMPANY MODEL# 1652-1-BP-EVS1-LW1-MT	C D
	[
	E

ABV	ABOVE	LAV
AD	ACCESS DOOR	MAX
4FF	ABOVE FINISHED FLOOR	МС
\FG	ABOVE FINISHED GRADE	MFR
AP	ACCESS PANEL	MIN
BF	BELOW FLOOR	MSS
SMT	BASEMENT	MV
CI	CAST IRON	NIC
CLG	CEILING	NTS
со	CLEAN OUT	PC
ODP	CLEANOUT DECK PLATE	PO
OND	CONDUIT	PSI
OWP	CLEANOUT WALL PLATE	SAN
CTE	CONNECT TO EXISTING	SHR
CW	COLD WATER	SS
DF	DRINKING FOUNTAIN	TYP
нм	DOMESTIC HOT WATER	URN
нwс	DOMESTIC HOT WATER CIRCULATING	V
AIC	DIAMETER	VTR
DN	DOWN	W
₩V	DRAINAGE, WASTE &	W&V
	VENT DRAINAGE PIPING	WC
KIST.	EXISTING	WHA
FAI	FRESH AIR INLET	DWG
FD	FLOOR DRAIN	ETR
FE	FINISHED FLOOR ELEVATION	
FT	FEET	
SPM	GALLONS PER MINUTE	
IN	INCHES	
/. EL.	INVERT ELEVATION	
SIG	POUNDS PER SQUARE INCH GAUGE	

LAVATORY
MAXIMUM
MECHANICAL CONTRACTOR
MANUFACTURER
MINIMUM
MOP SERVICE SINK
MIXING VALVE
NOT IN CONTRACT
NOT TO SCALE
PLUMBING CONTRACTOR
PLUGGED OUTLET
POUNDS PER SQUARE INCH
SANITARY
SHOWER
STAINLESS STEEL
TYPICAL
URINAL
VENT
VENT THROUGH THE ROOF
WASTE
WASTE AND VENT
WATER CLOSET
WATER HAMMER ARRESTOR
DRAWING
EXISTING TO REMAIN










CONSULTANT							
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RAN Engineering, P.C.							
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CONTRACT:							
REPLACE PLUMBING C BLOCK, BUILDING 20							
LOCATION: ELMIRA CORRECTIONAL FACILITY 1879 DAVIS STREET							
ELMIRA, NEW YORK							
DEPARTMENT OF CORRECTIONS AND COMMUNITY SUPERVISION							
5 5/13/2015 ADDENDA 5 11/12/2014 BID DOCUMENTS							
MARK DATE DESCRIPTION							
PROJECT 44671 - P							
DESIGNED BY: LGB DRAWN BY: JAS							
FIELD CHECK: APPROVED:							
SHEET TITLE: PLUMBING— FIRST FLOOR PLAN							
drawing number: P-102							
SHEET 3 OF 14							



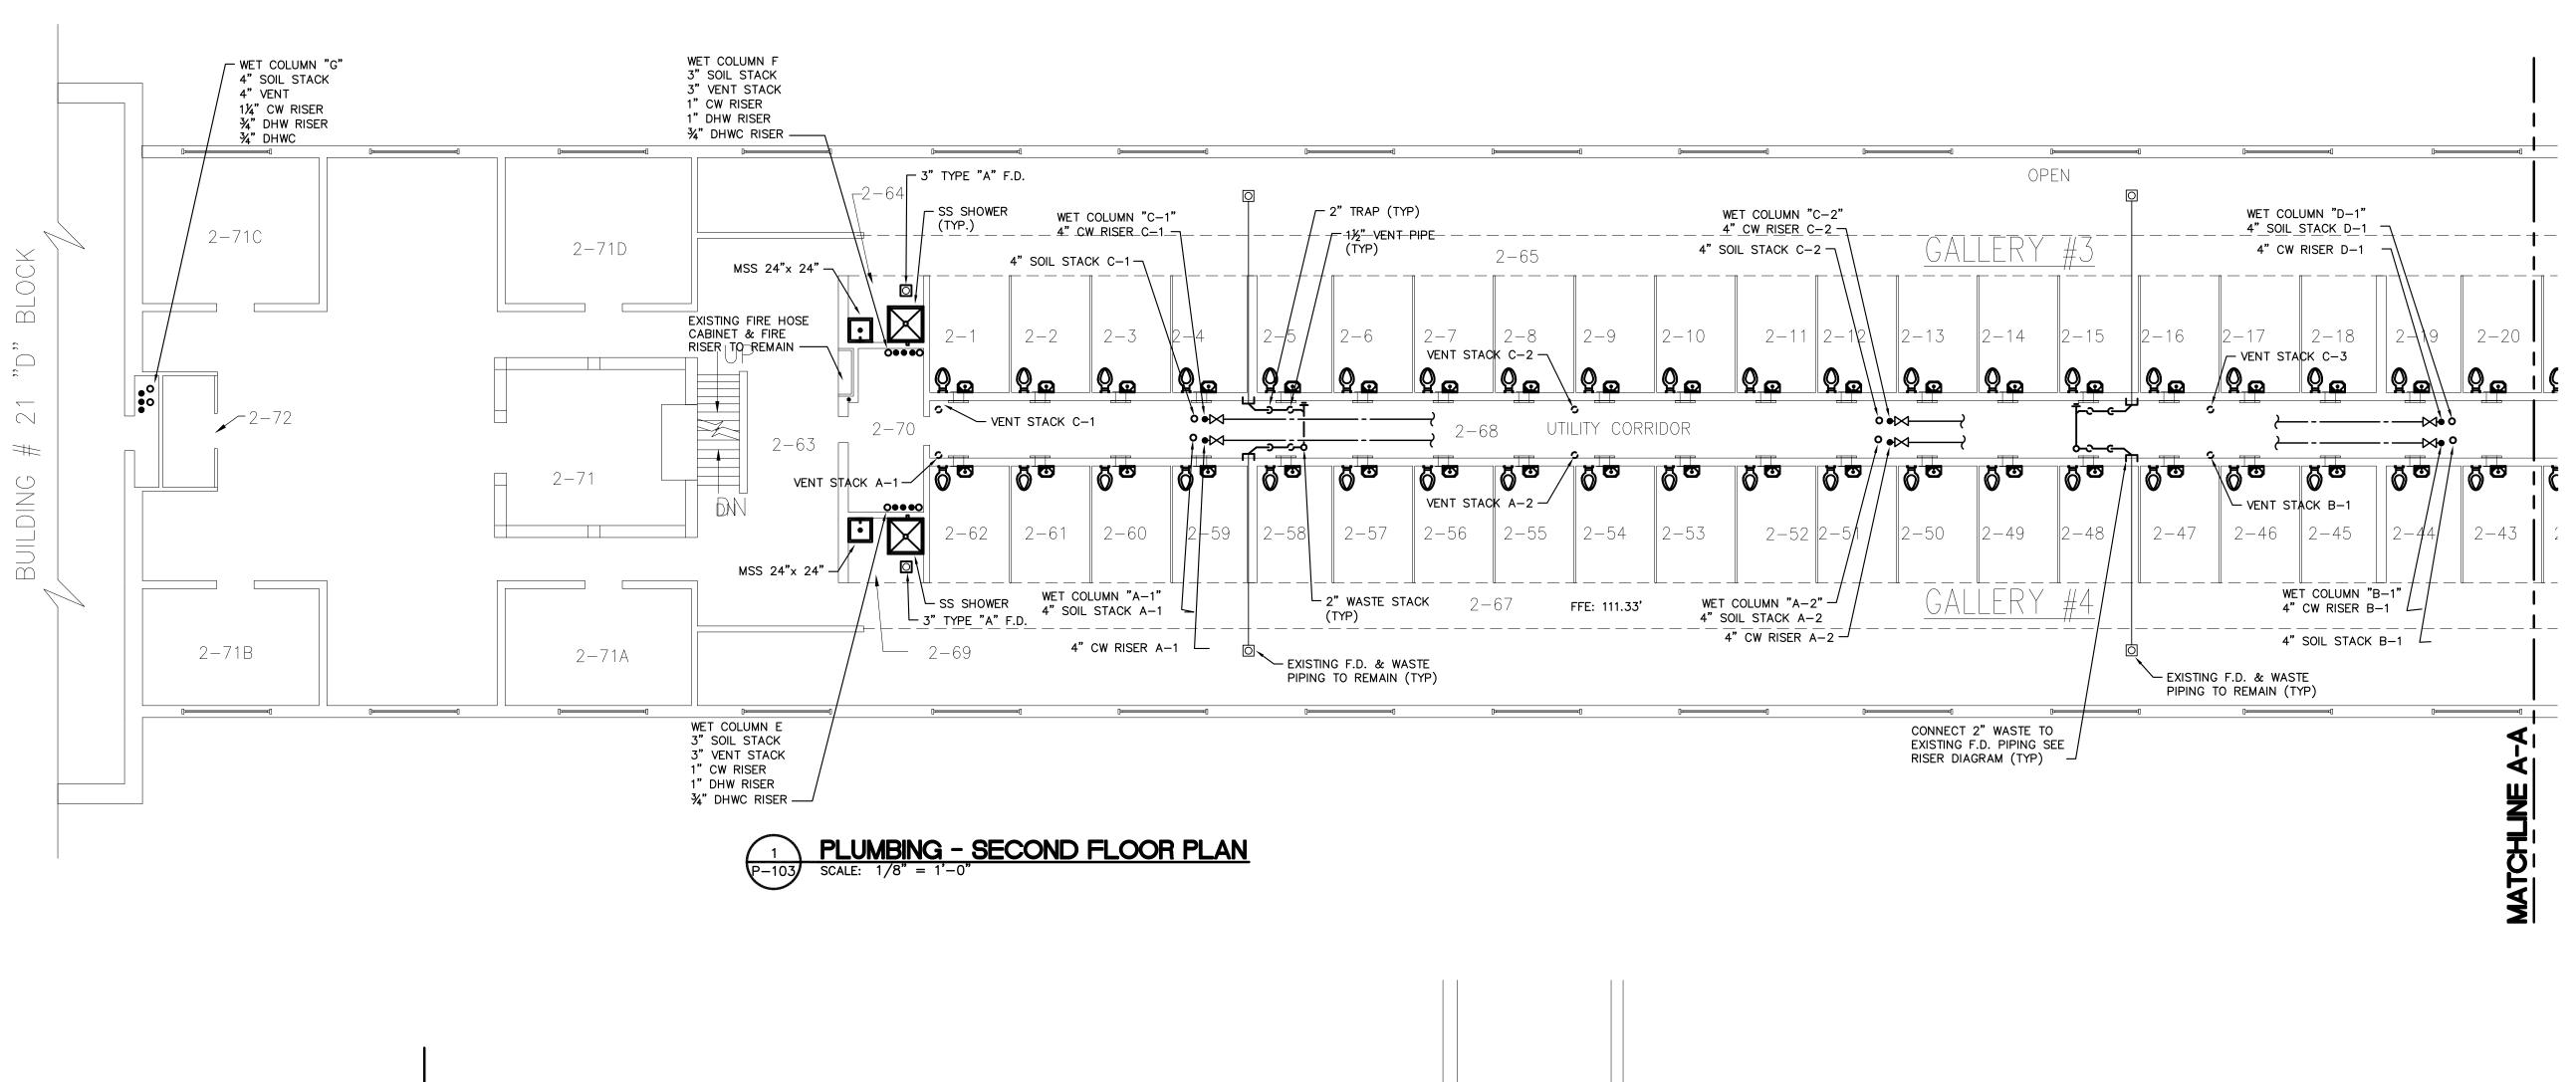


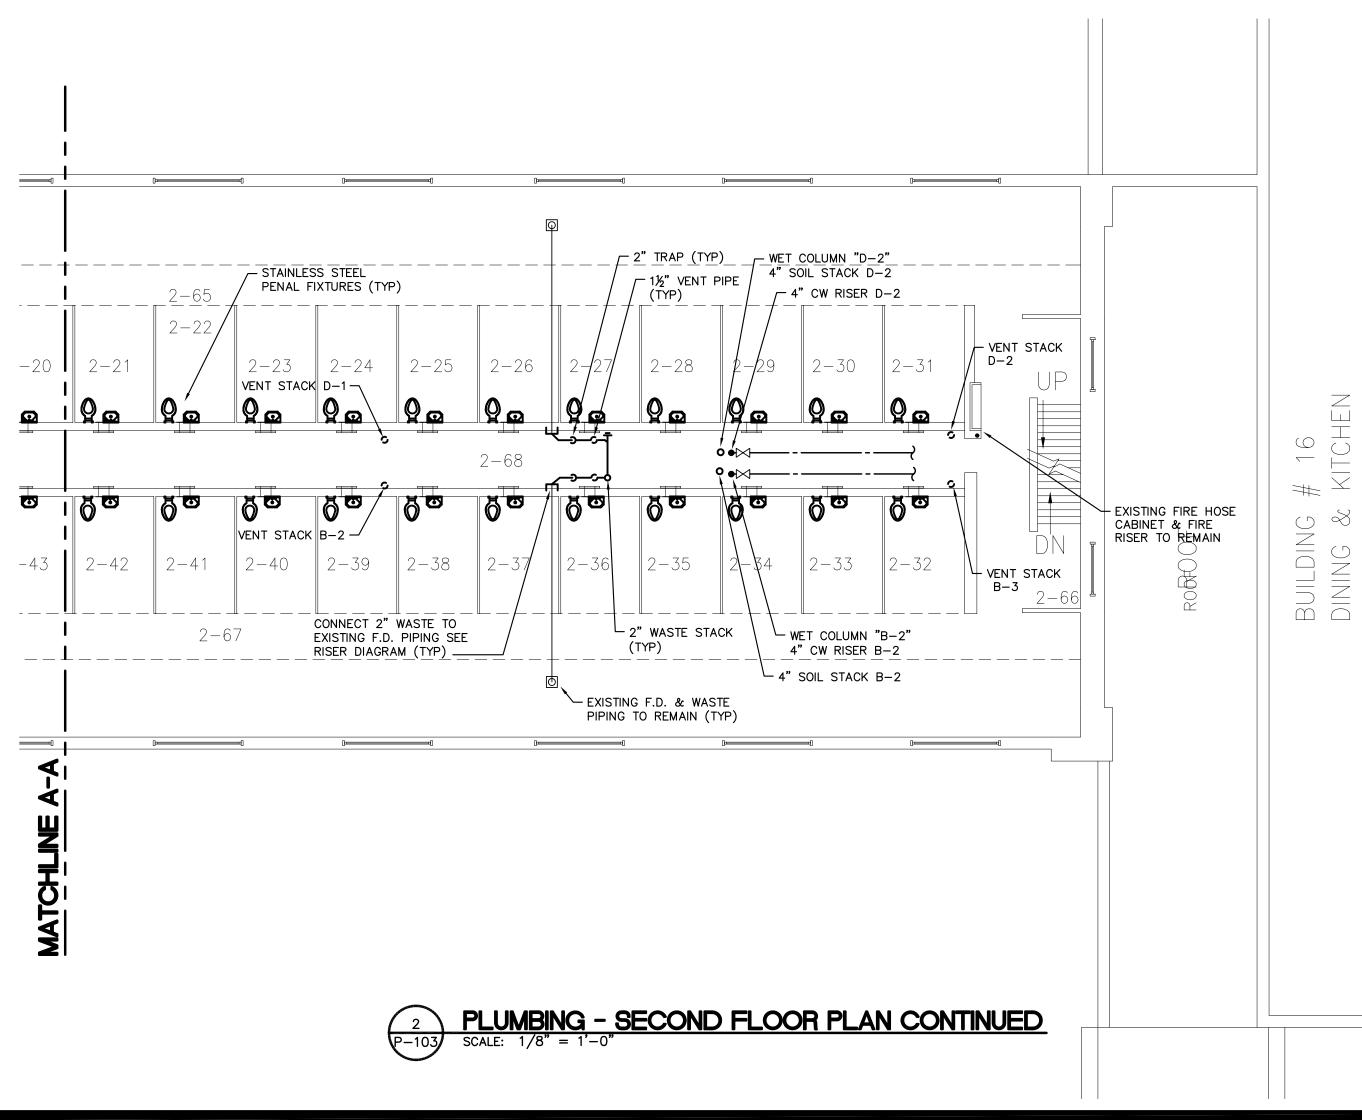


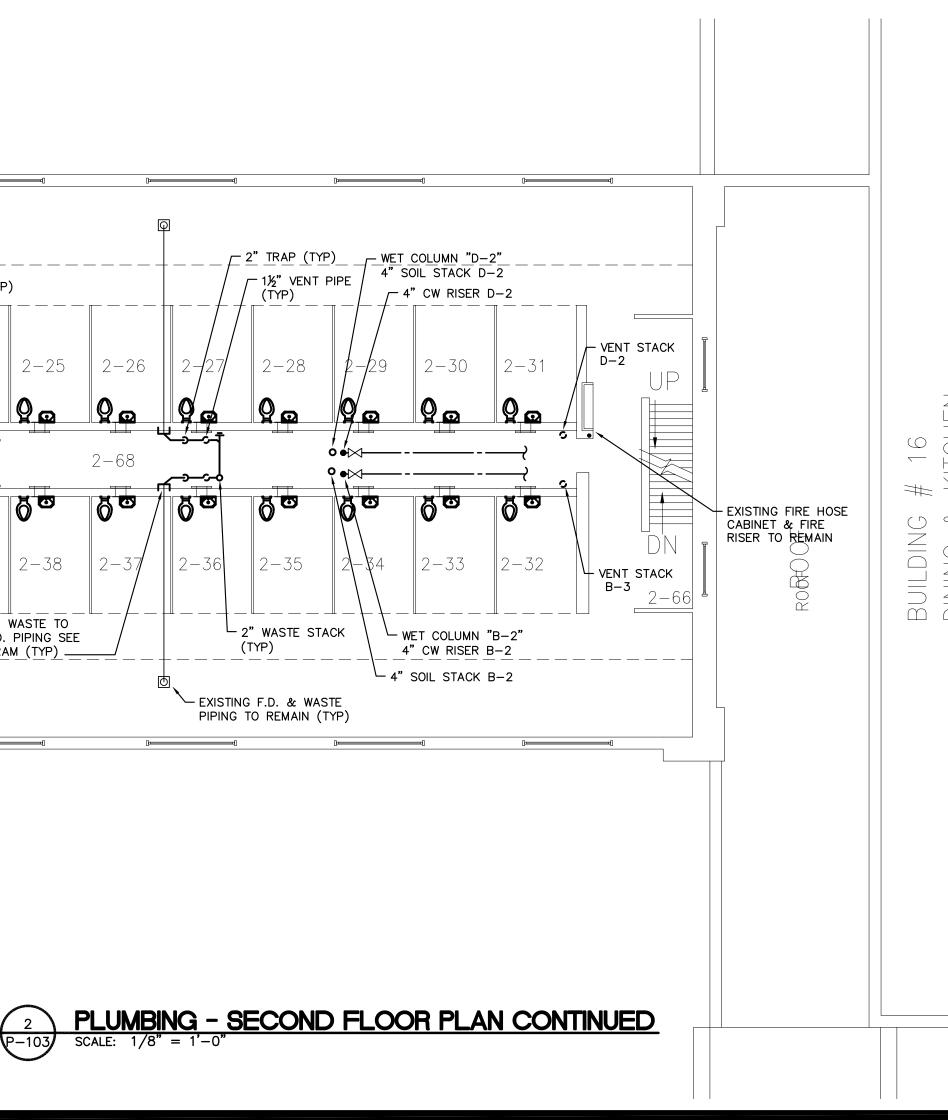



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DESIGNED BY: DRAWN BY:	LGB JAS					
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PLUMBING- SECOND FLOOR PLAN						
drawing number: P-103						
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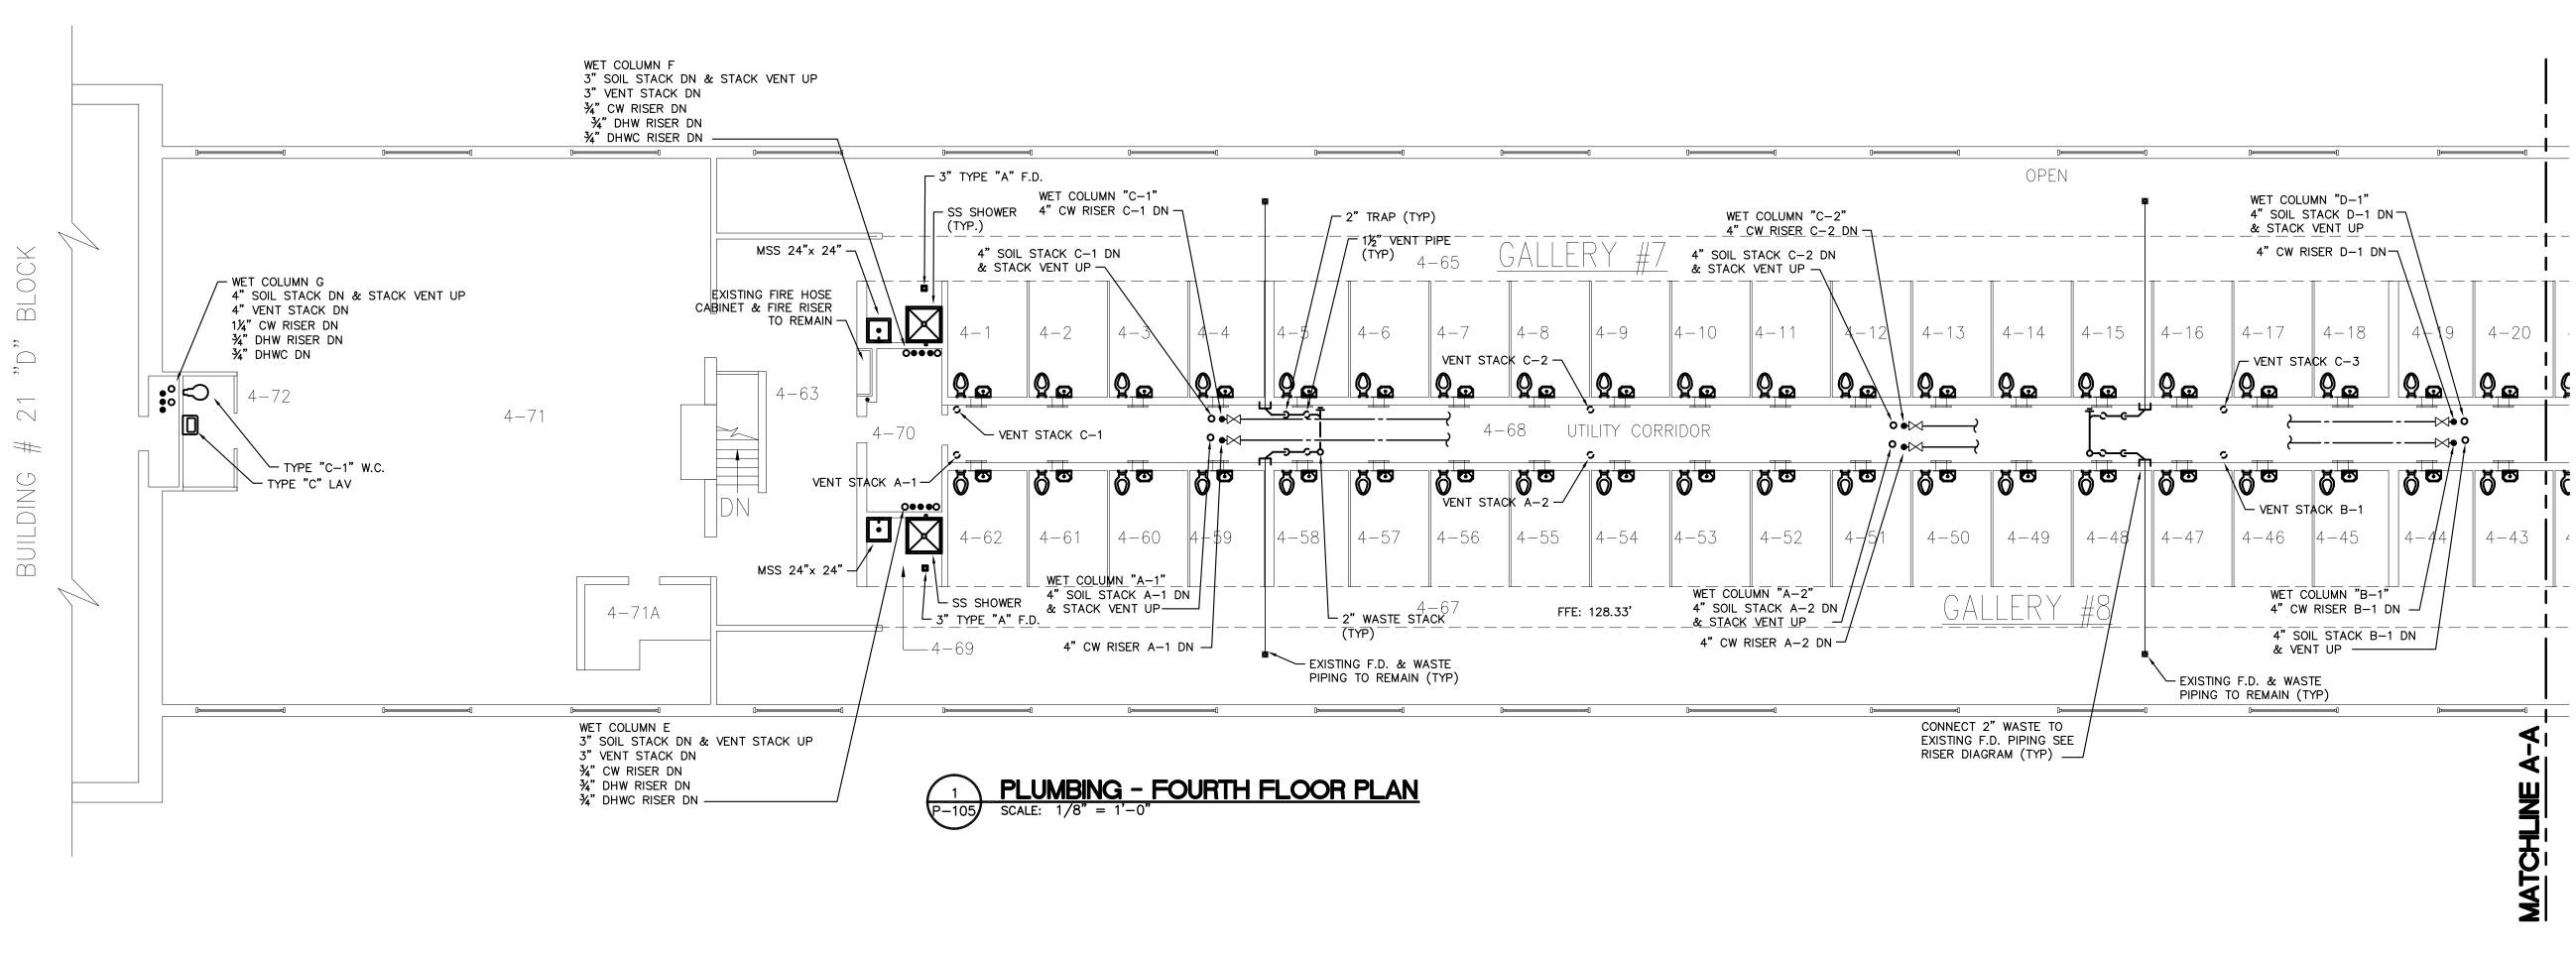
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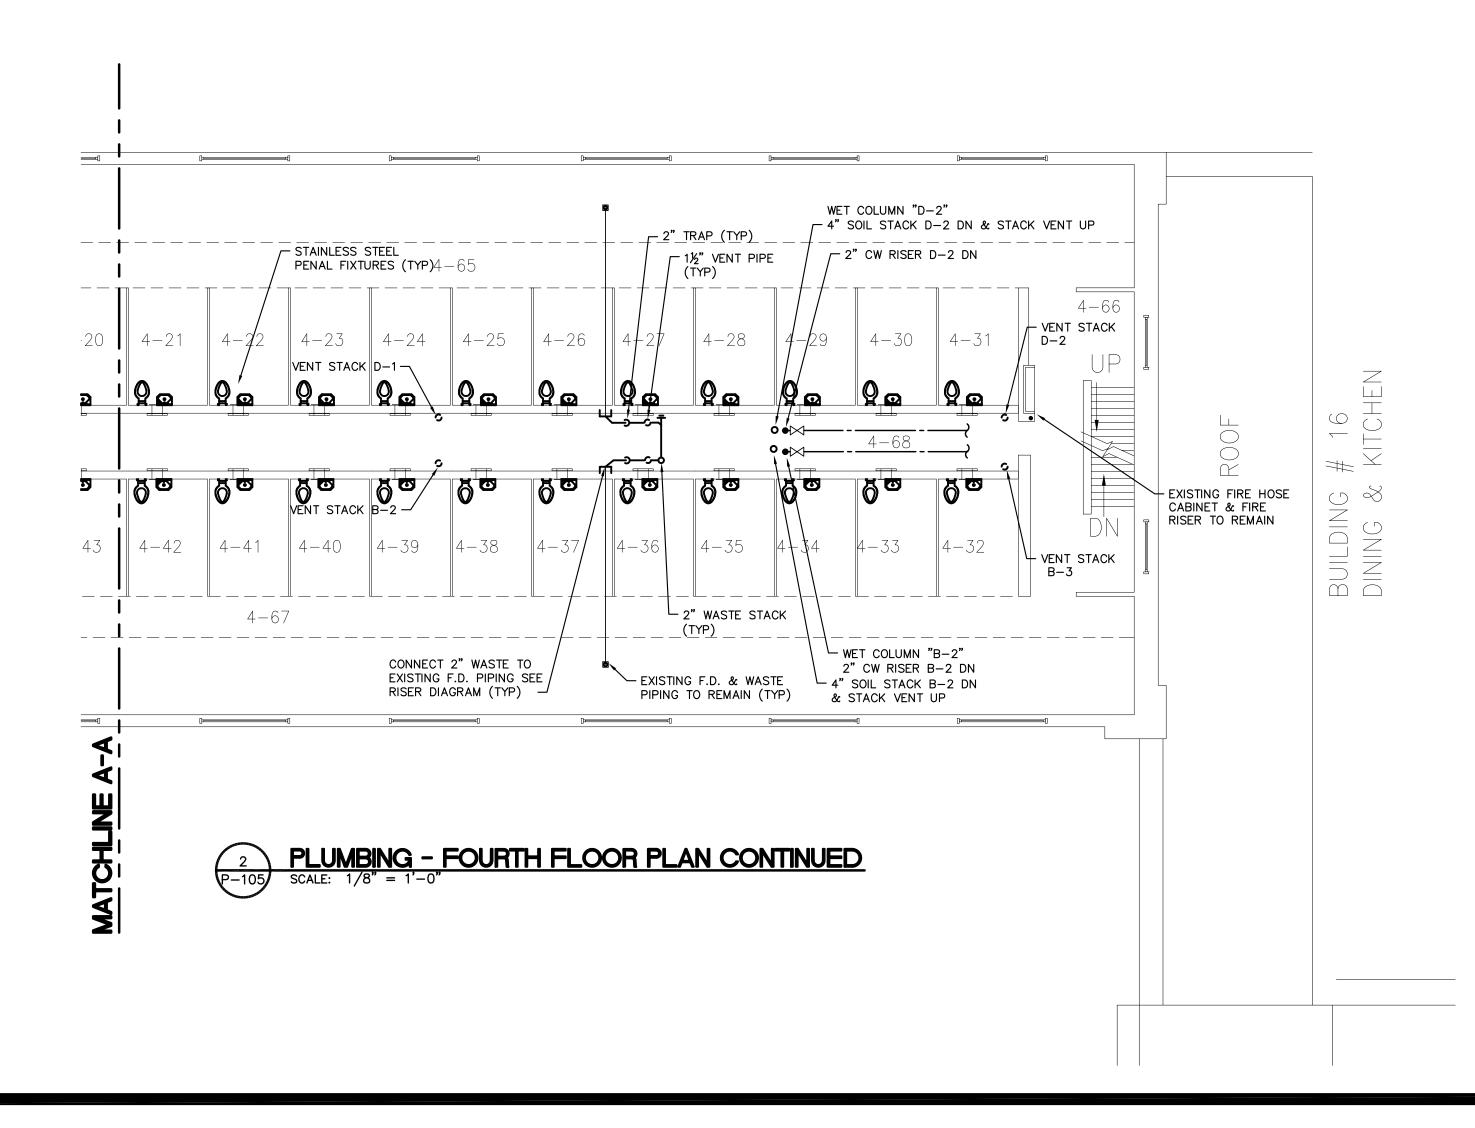




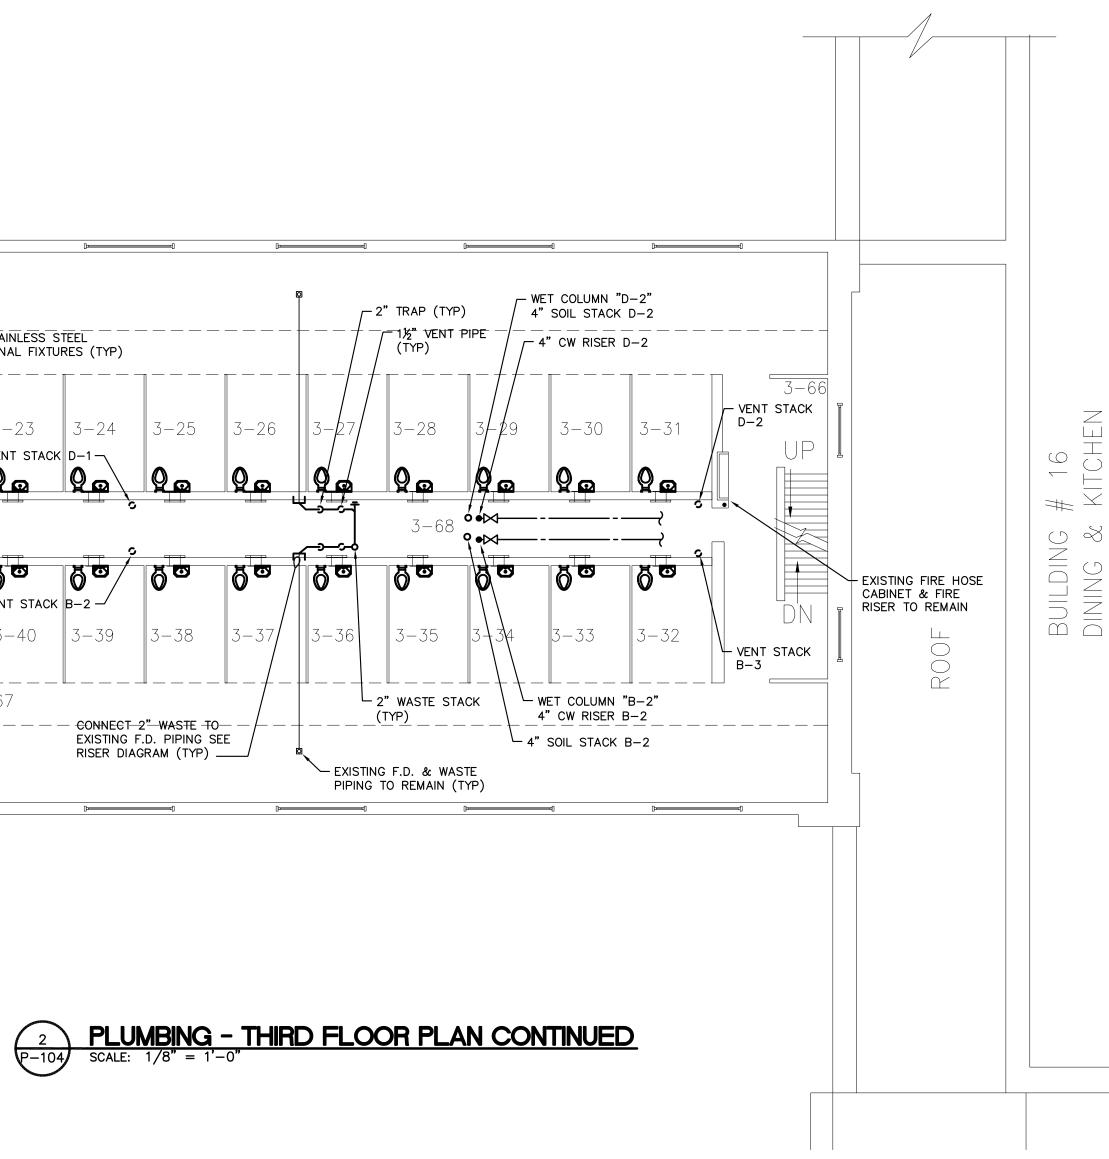

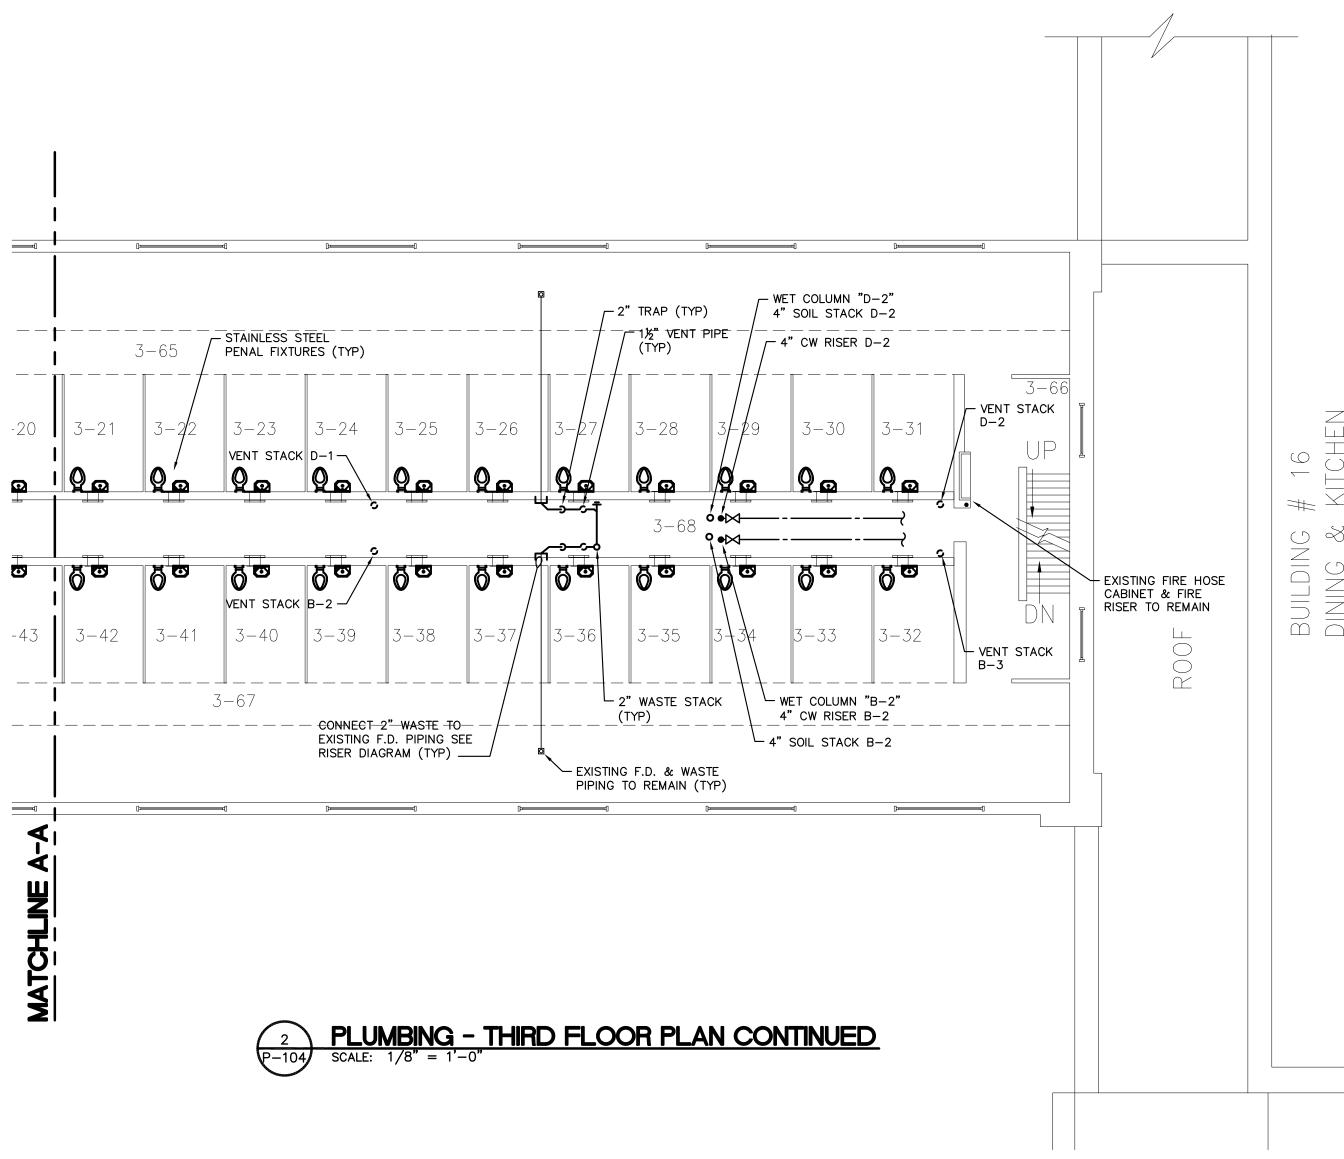

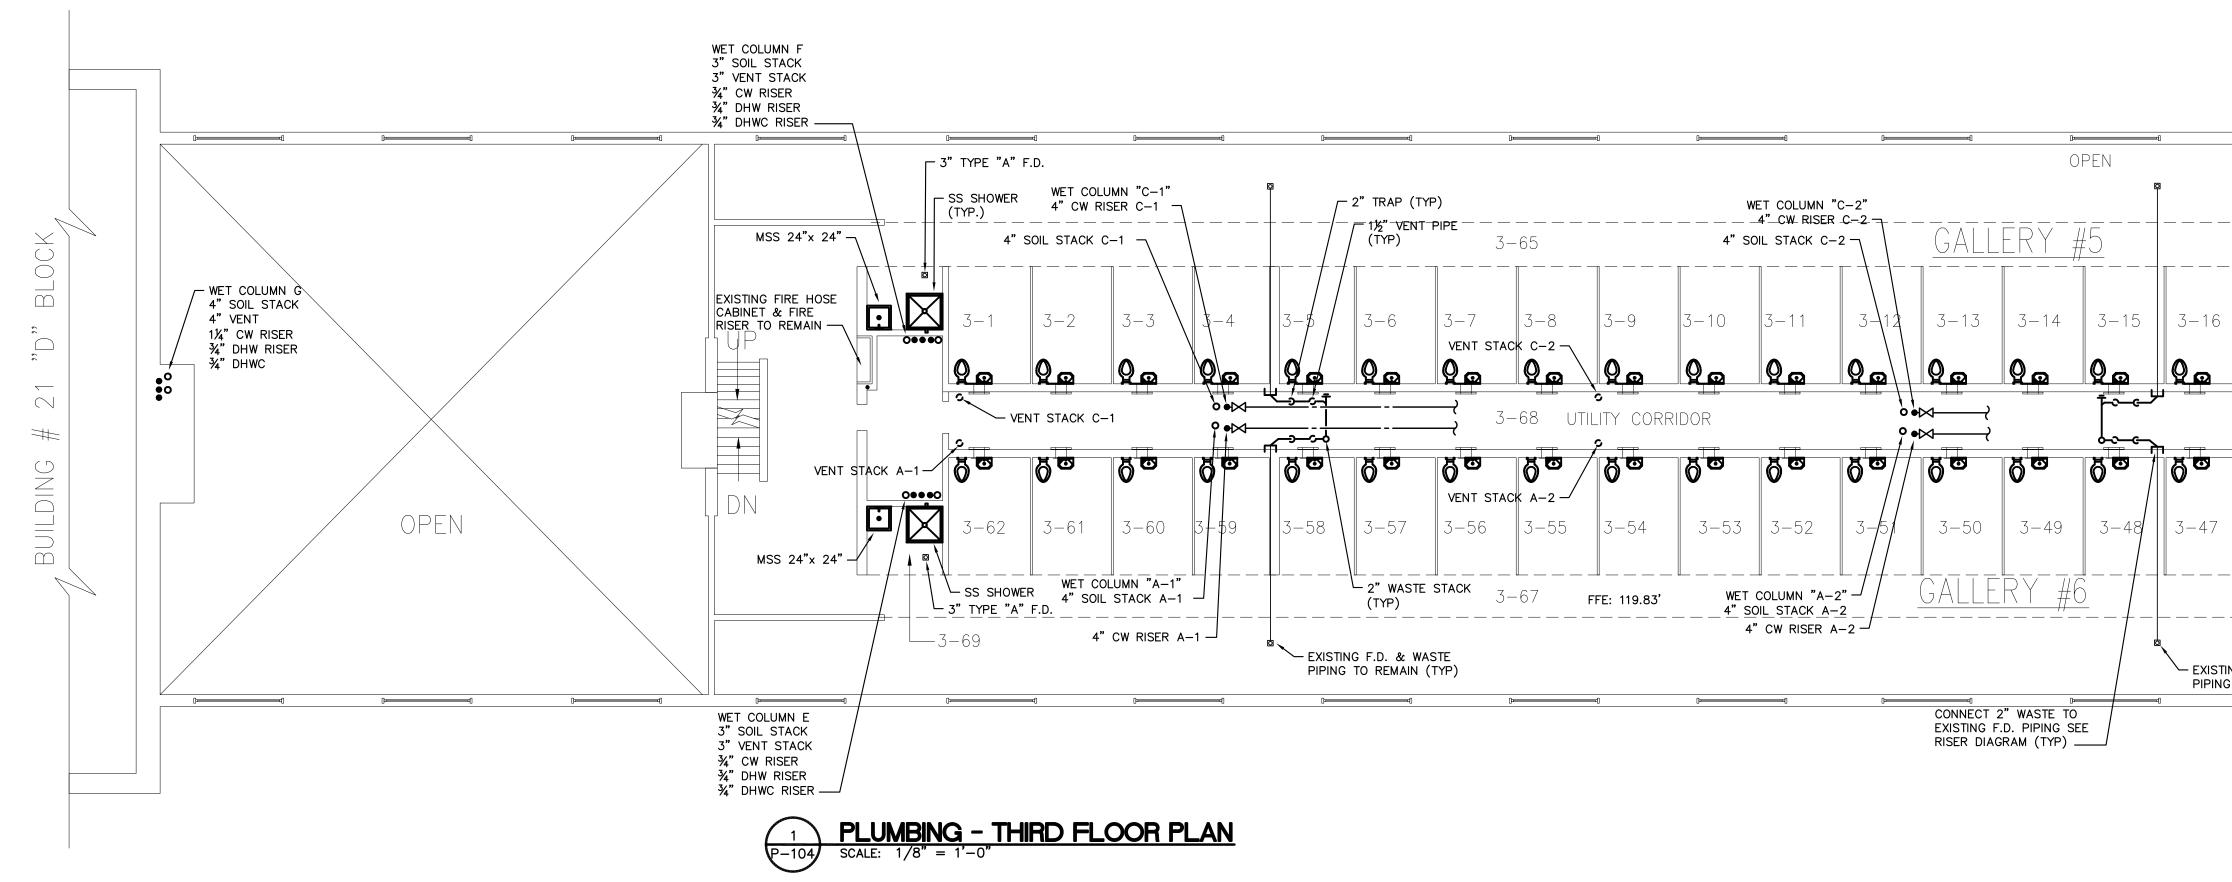


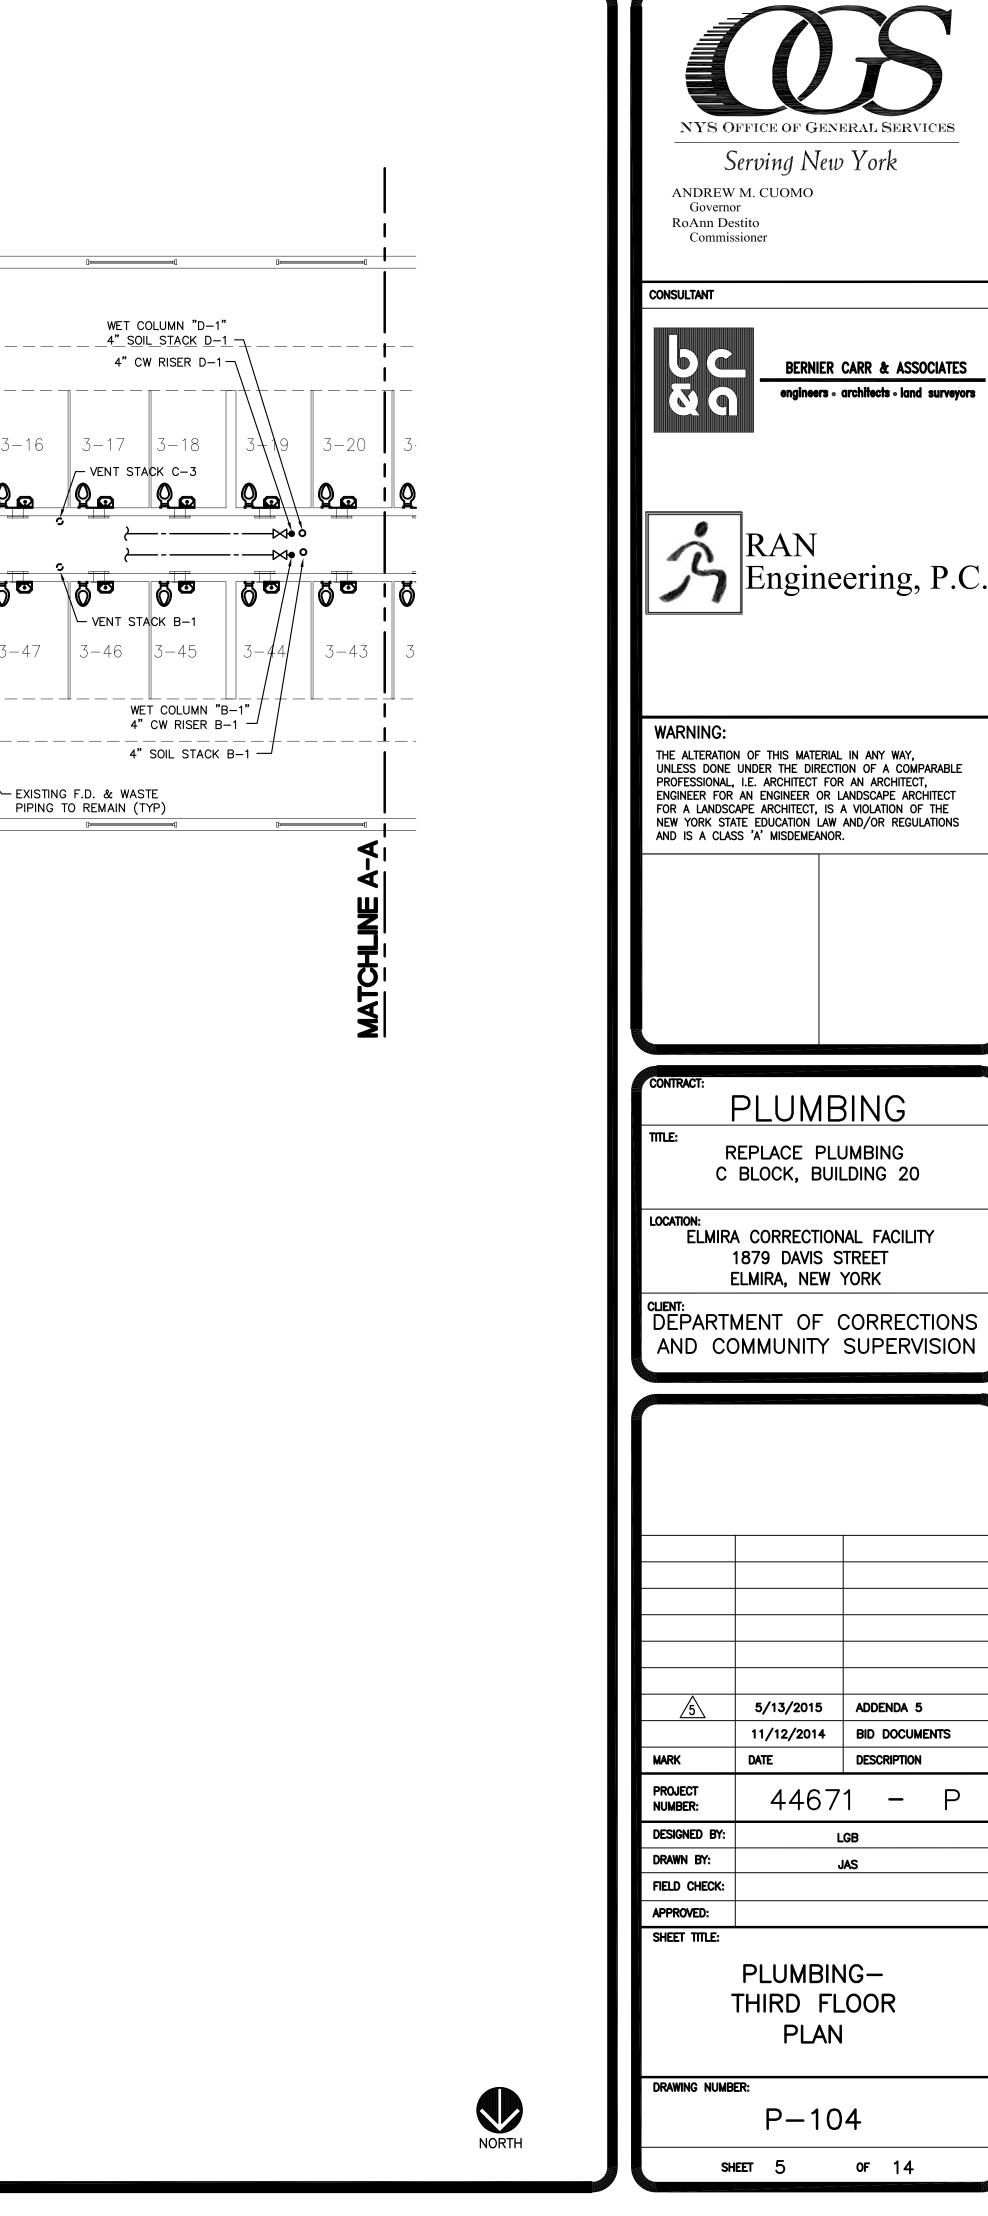




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CONTRACT: PLUMBING TITLE: PEDLACE, PLUMPING					
REPLACE PLUMBING C BLOCK, BUILDING 20					
5 5/13/2015 ADDENDA 5 11/12/2014 BID DOCUMENTS MARK DATE DESCRIPTION					
PROJECT 44671 - P					
DESIGNED BY: LGB					
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PLUMBING- FOURTH FLOOR PLAN					
drawing number: P-105					
SHEET 6 OF 14					



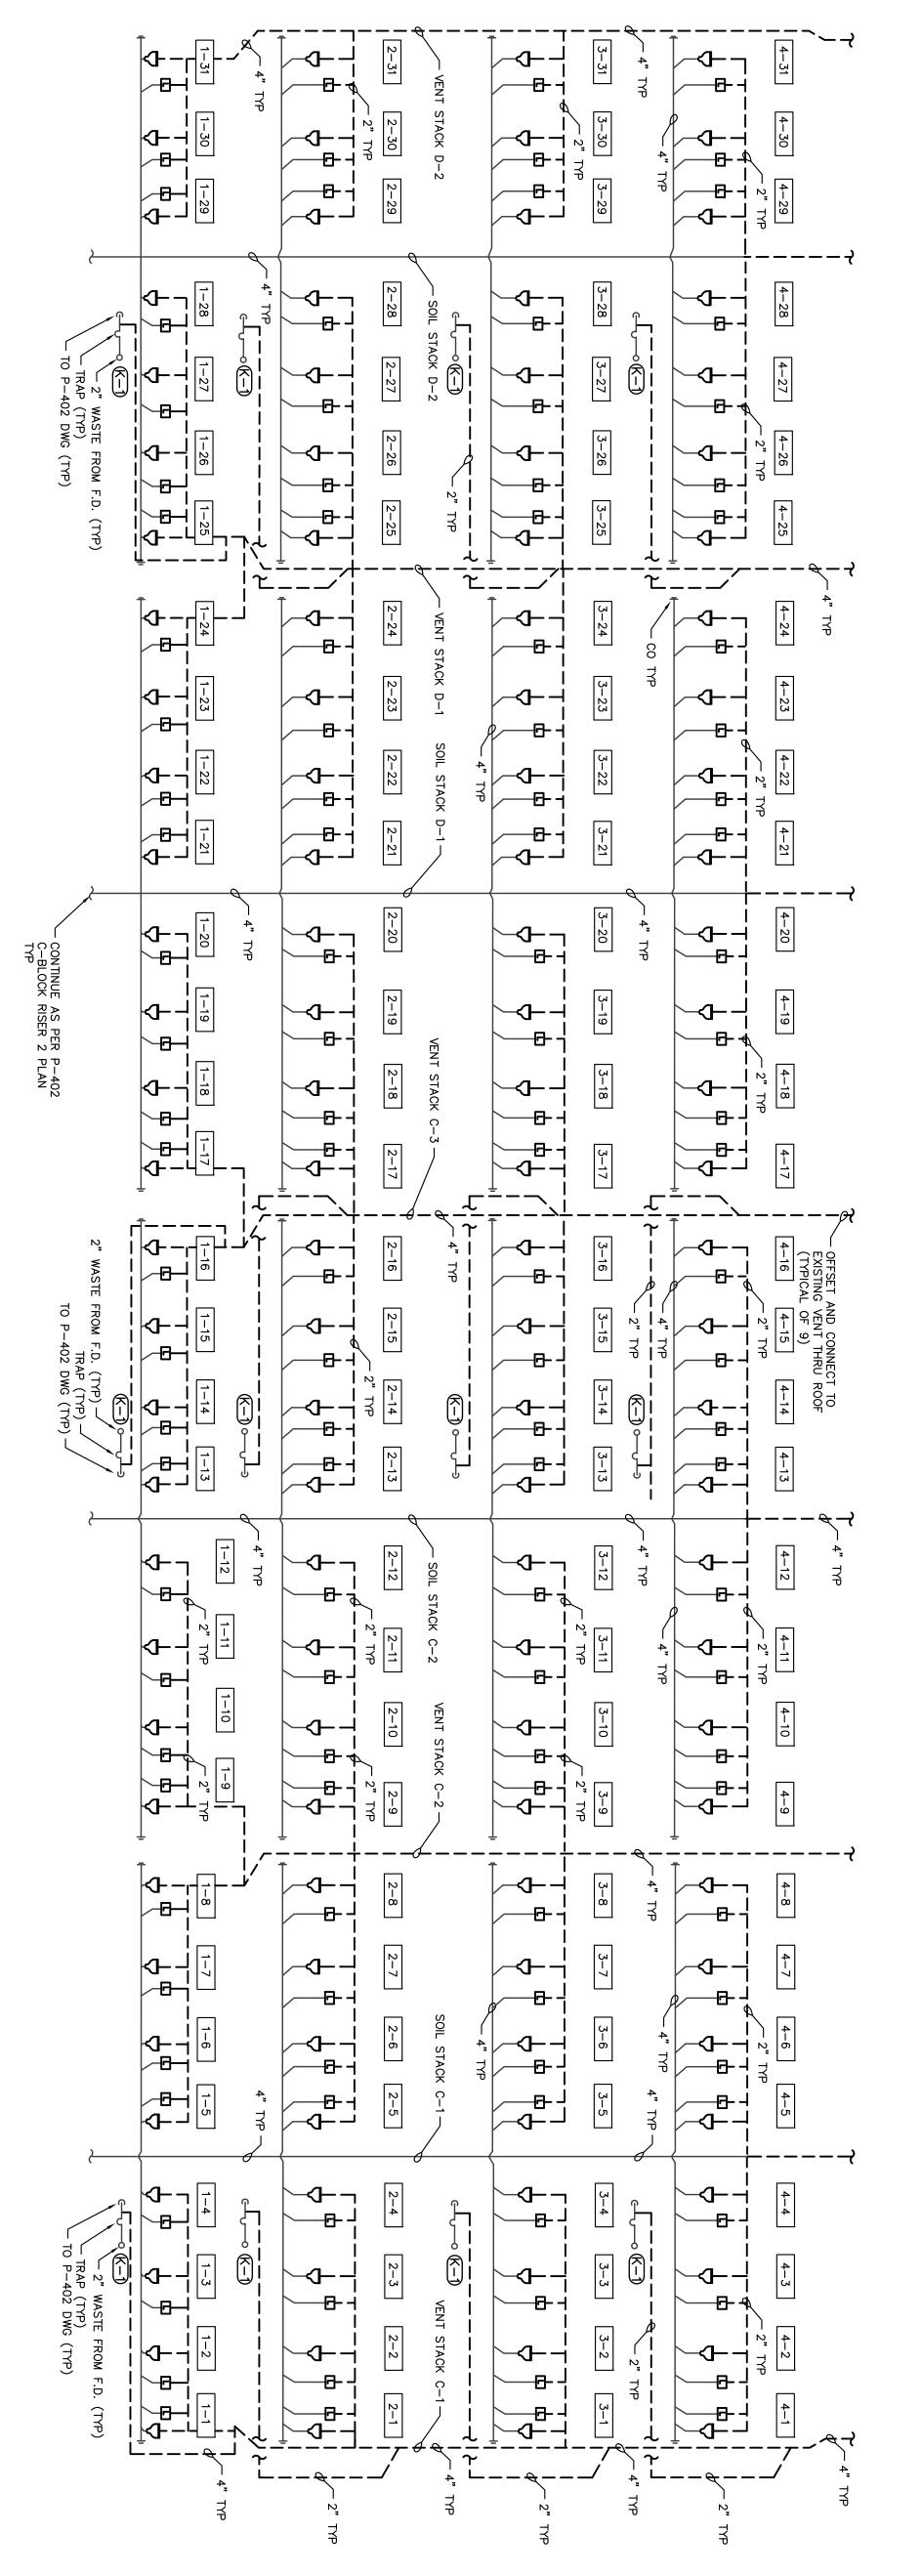

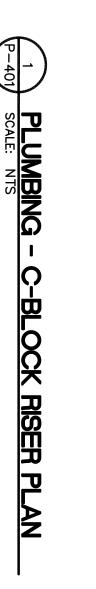

SHEET 8

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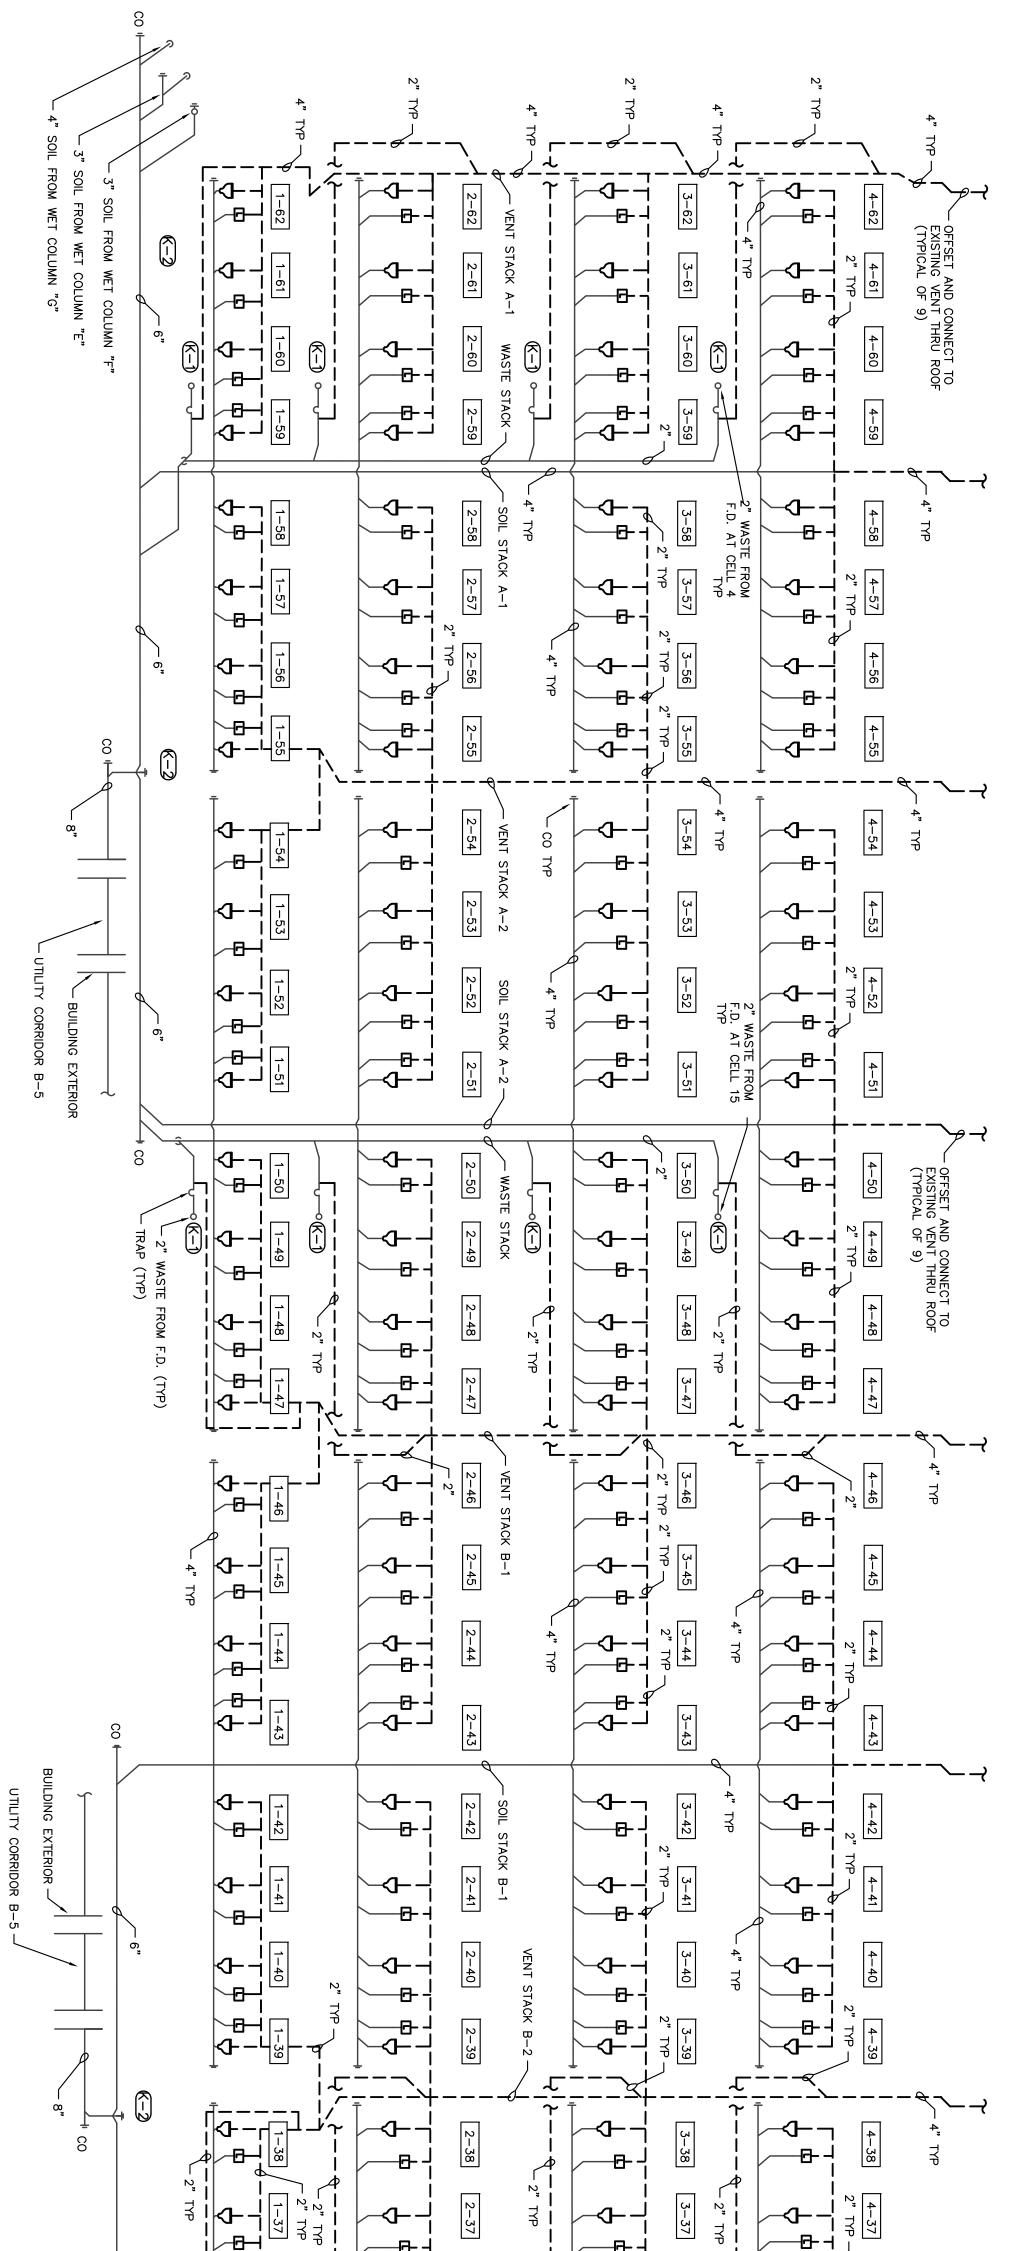
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AT EACH INMATE WATER CLOSET FIXTURE INSTALL A "PIN TRAP". A PIN TRAP CONSISTS OF A STEEL ROD WELDED ACROSS THE INSIDE DIAMETER OF THE WASTE PIPE AT EACH WATER CLOSET FIXTURE. A PIN TRAP CAPTURES FOREIGN OBJECTS AND CAUSES A LOCAL STOPPAGE THAT IS MORE EASILY ADDRESSED BY THE MAINTENANCE STAFF. SALVAGE EXISTING PIN TRAPS AND REINSTALL AT EACH INMATE WATER CLOSET INSTALLATION.

REFER TO PLAN VIEW DRAWINGS FOR ADDITIONAL INSTALLATION REQUIREMENTS.

KEYED NOTES CONNECT 2" WASTE TO EXISTING FD PIPING TO REMAIN. TRAP, CLEANOUT & VENT PIPING PRO' RUNNING



SCALE: NTS C-BLOCK RISER PLAN

drawn by: Field Check: Approved: Sheet Title:

PLUMBING-WASTE C-BLOCK RISER 2 PLAN

Q

NUMBER:

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402

SHEET 9

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1 4

PROJECT NUMBER:

44671

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Designed by:

SAL LCB MARK

DATE

DESCRIPTION

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5/13/2015 11/12/2014

ADDENDA 5 BID DOCUME

DOCUMENTS

KEYED ≪-2 REFER TO BASEMENT FLOOR CONNECT 2" WASTE TO EXISTING FD PIPING TRAP, CLEANOUT & VENT PIPING NOTES

	K- wASTE STACK 2-36 2-35 1-36 1-35 1-36 1-35		AT EACH INMAT CONSISTS OF A WASTE PIPE AT OBJECTS AND O BY THE MAINTE EACH INMATE W REFER TO PLAN	SENERAL NO
CO 4" TYP	VENT STACK B-3 SOIL STACK B-2 2 - 34 $2 - 33$ $2 - 322 - 34$ $2 - 33$ $2 - 322 - 32 4^{"} TYP4^{"} TYP4^{"} TYP4^{"} TYP4^{"} TYP4^{"} TYP4^{"} TYP4^{"} TYP$	$\begin{array}{c} 4-34 \\ 2^{"} \text{ TVP} \\ 2^{"} \text{ WASTE FROM} \\ F.D. \text{ AT CELL 26} \\ 1^{"} \text{ TVP} \\ 2^{"} \text{ TVP} \\ 2^{"} \text{ TVP} \\ 3-34 \\ 2^{"} \text{ TVP} \\ 3-33 \\ 3-32 \\ 2^{"} \text{ TVP} \\ 3-33 \\ 3-32 \\ 3$	THE CLOSET FIXTURE INSTALL A "PIN TRAP". WATER CLOSET FIXTURE. A PIN TRAP CAPTL STAFF. SALVAGE EXISTING PIN TRAPS AND CLOSET INSTALLATION. DRAWINGS FOR ADDITIONAL INSTALLATION RE DRAWINGS FOR ADDITIONAL INSTALLATION RE OFFSET AND CONNECT TO EXISTING VENT THRU ROOF	OTE

TO REMAIN. PROVIDE RUNNING

PLAN FOR SOIL AND WASTE PIPING P-101.

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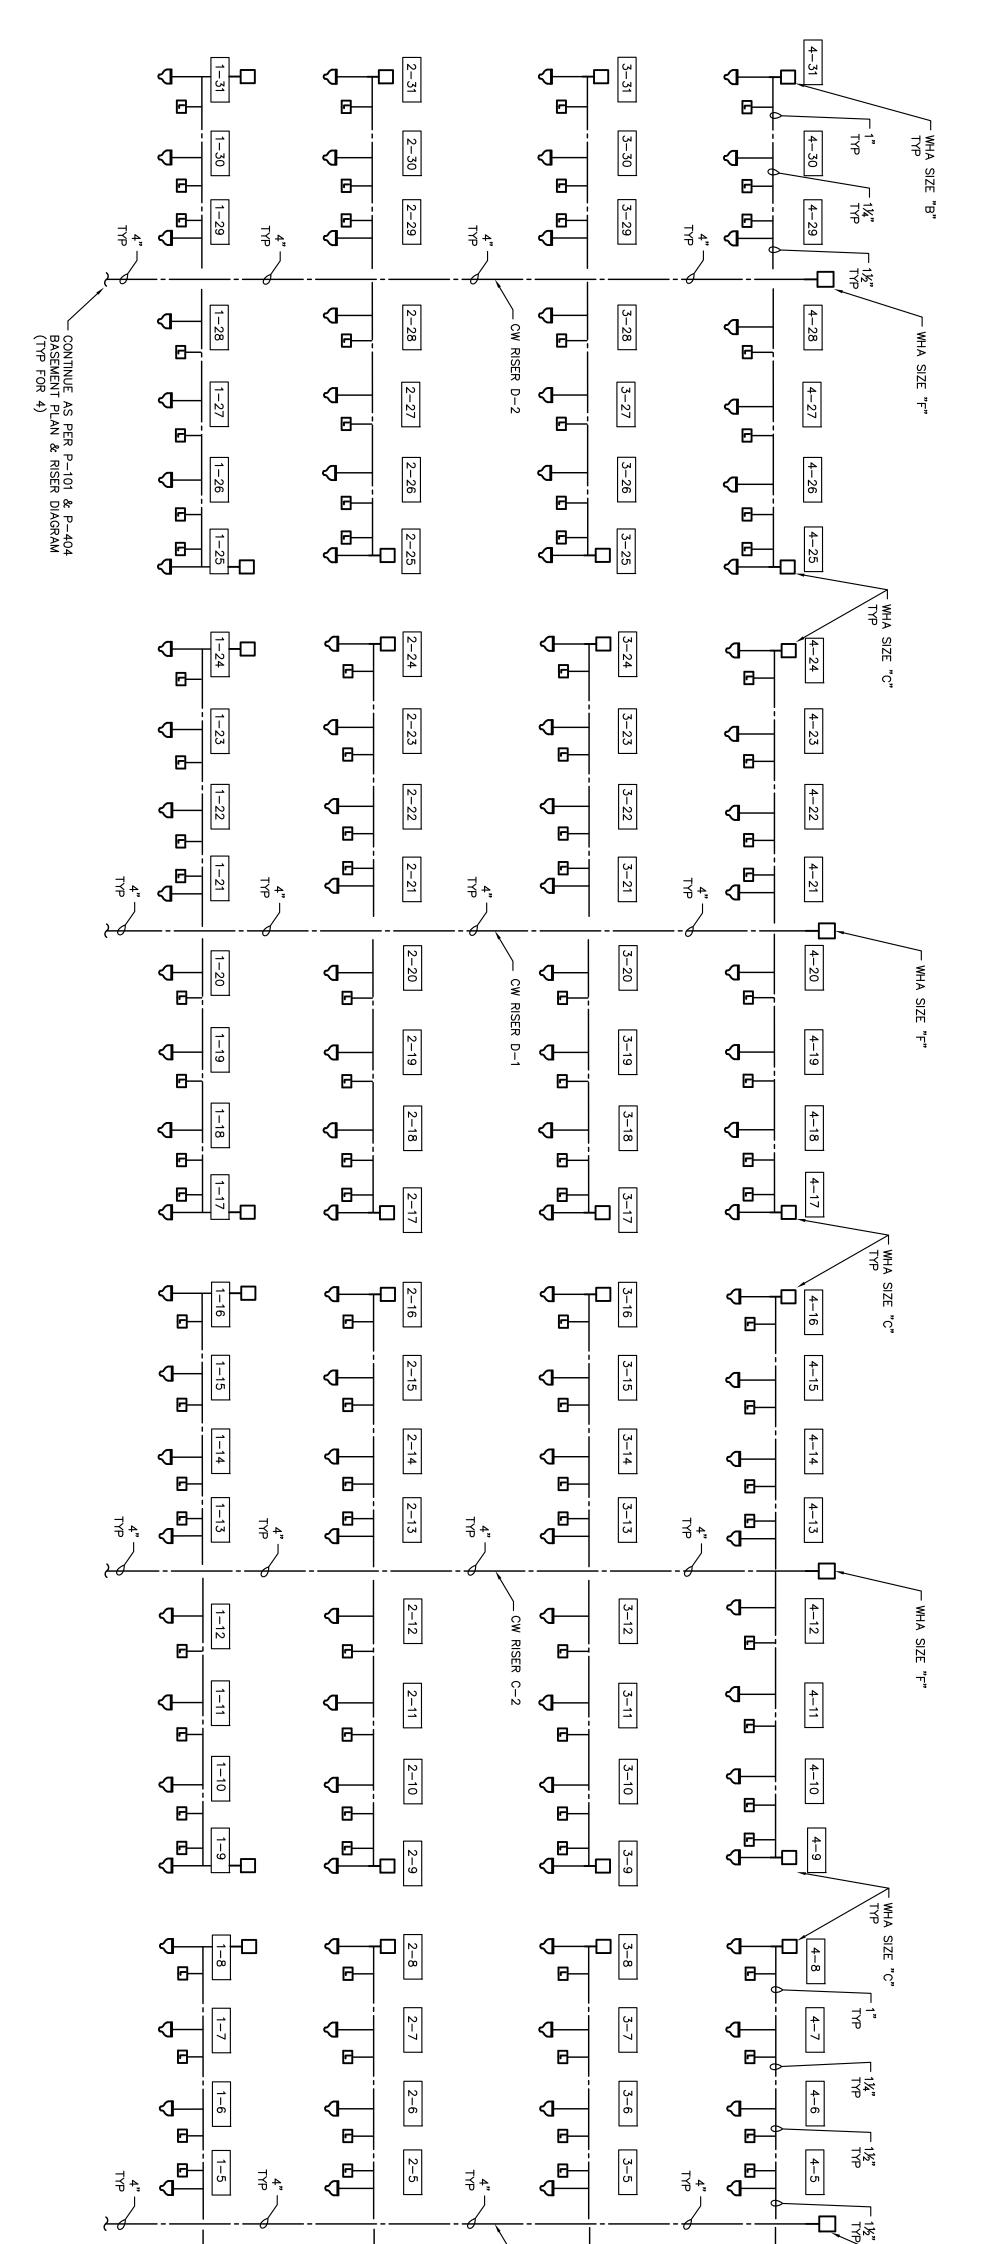
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AND COMMUNITY SUPERVISION

LOCATION: ELMIRA CORRECTIONAL FACILITY 1879 DAVIS STREET ELMIRA, NEW YORK

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REPLACE PLUMBING C BLOCK, BUILDING 20



PLUMBING -C-BLOCK RISER PLAN

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DEPARTMENT OF CORRECTIONS AND COMMUNITY SUPERVISION

LOCATION: ELMIRA CORRECTIONAL FACILITY 1879 DAVIS STREET ELMIRA, NEW YORK

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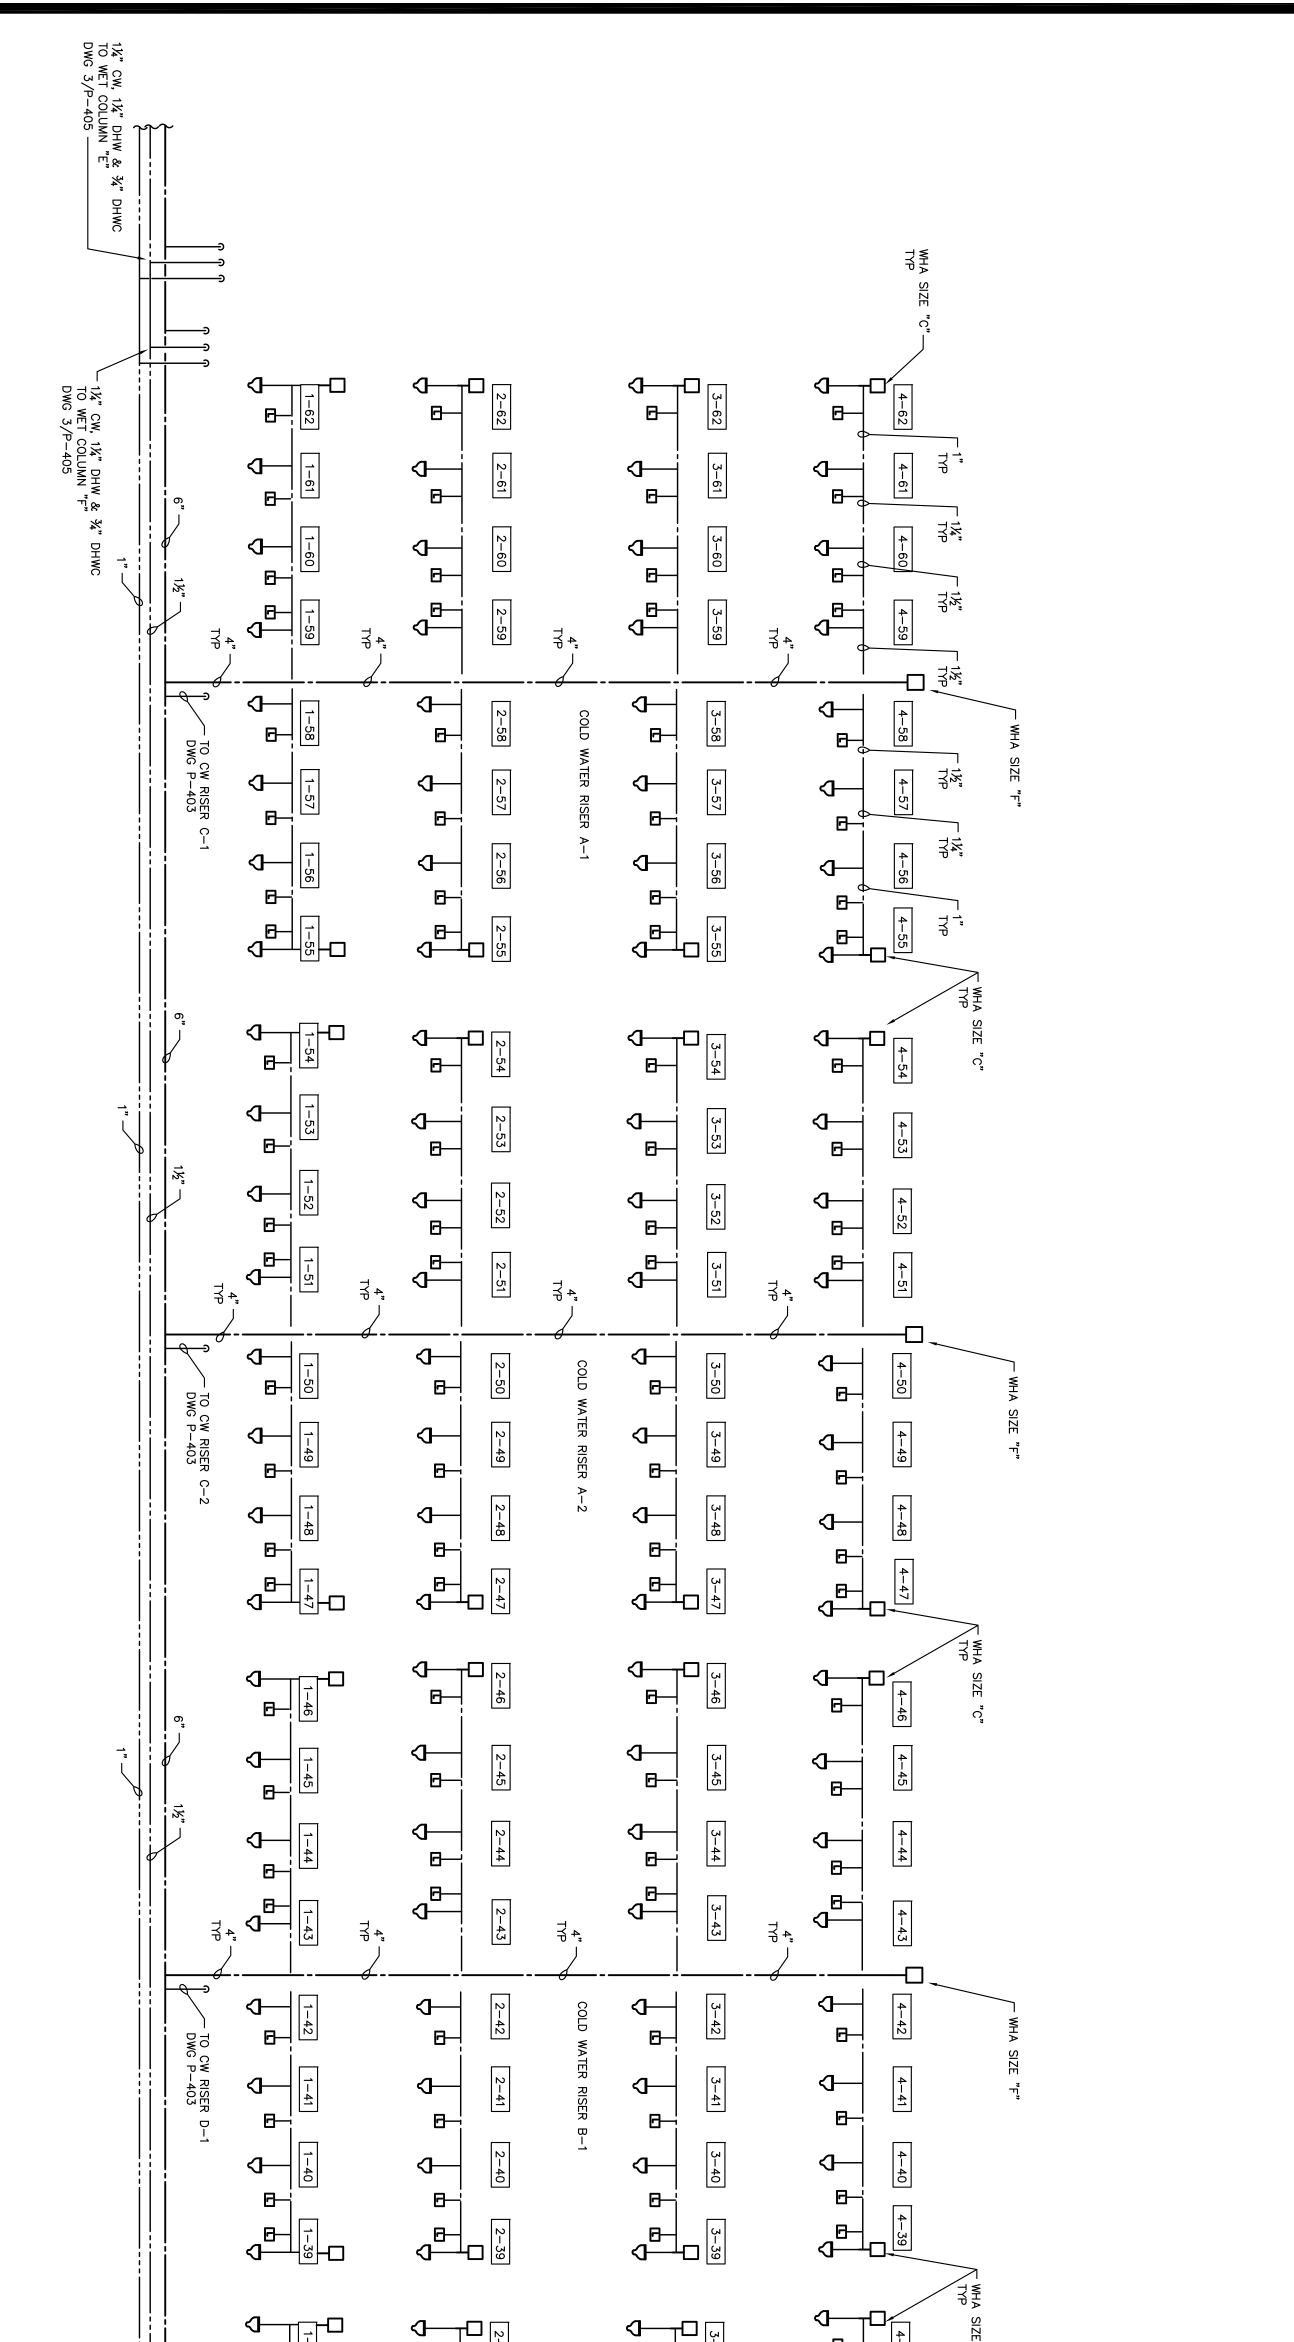
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LOCATION: ELMIRA CORRECTIONAL FACILITY 1879 DAVIS STREET ELMIRA, NEW YORK

REPLACE PLUMBING C BLOCK, BUILDING 20

PLUMBING

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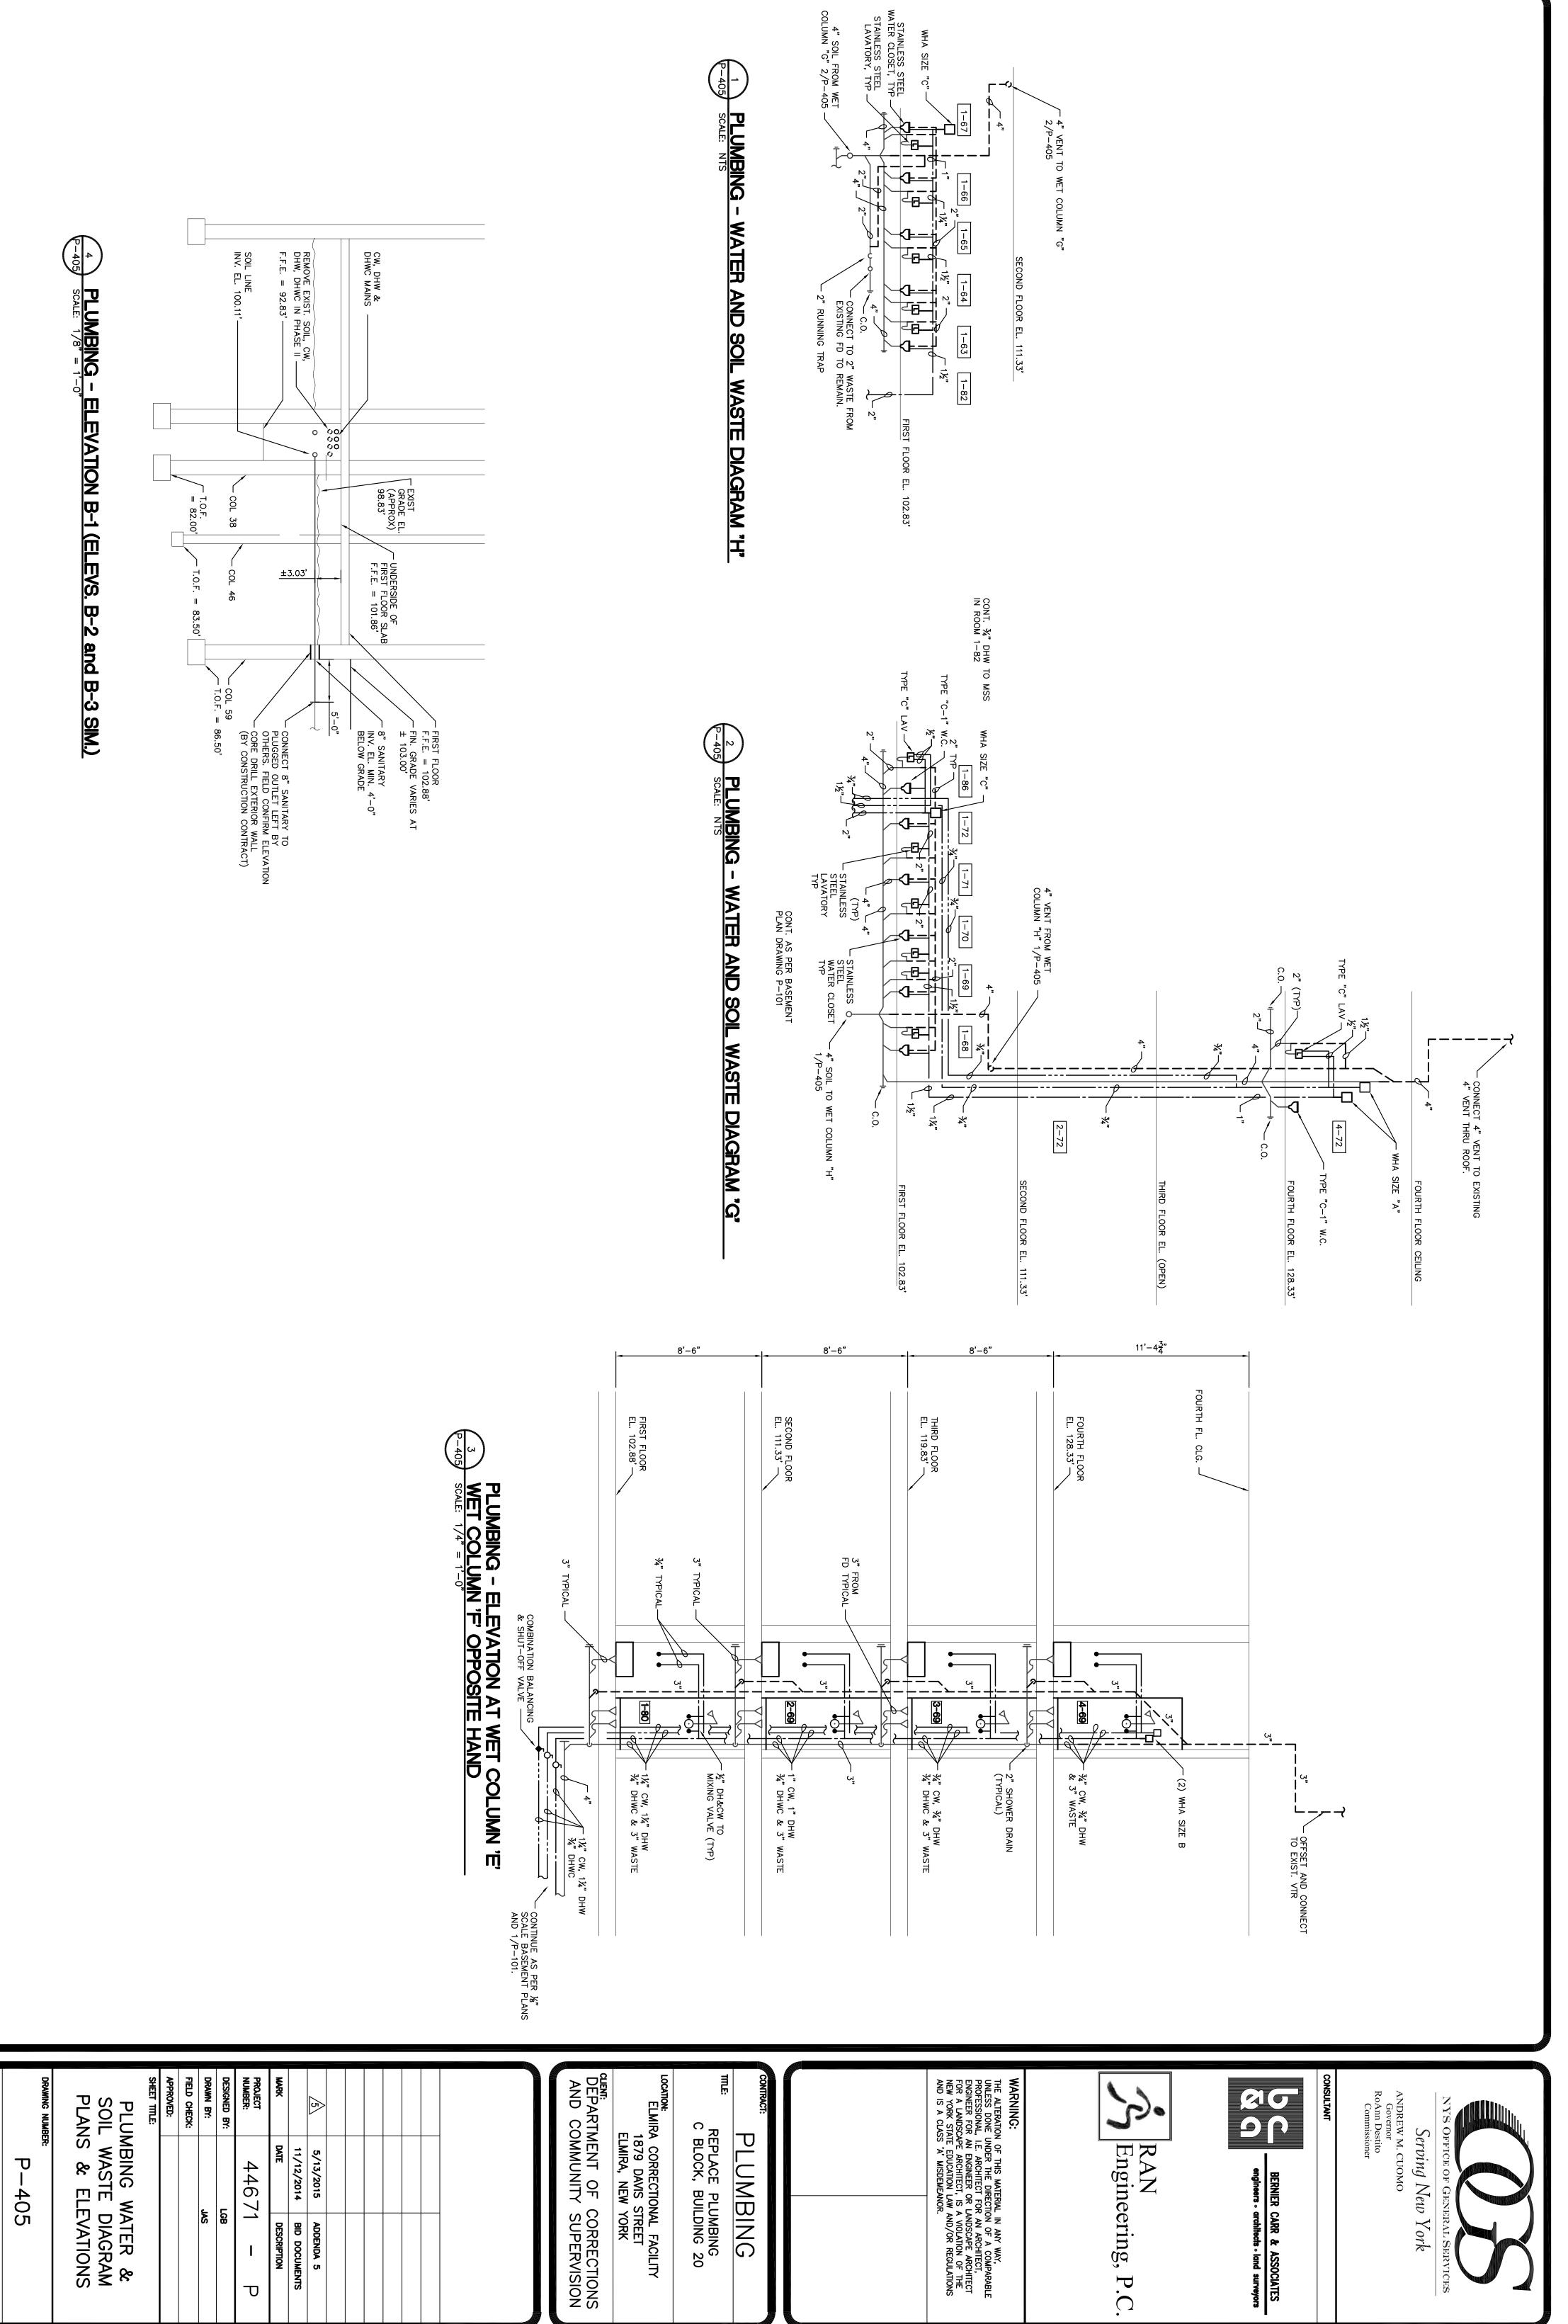
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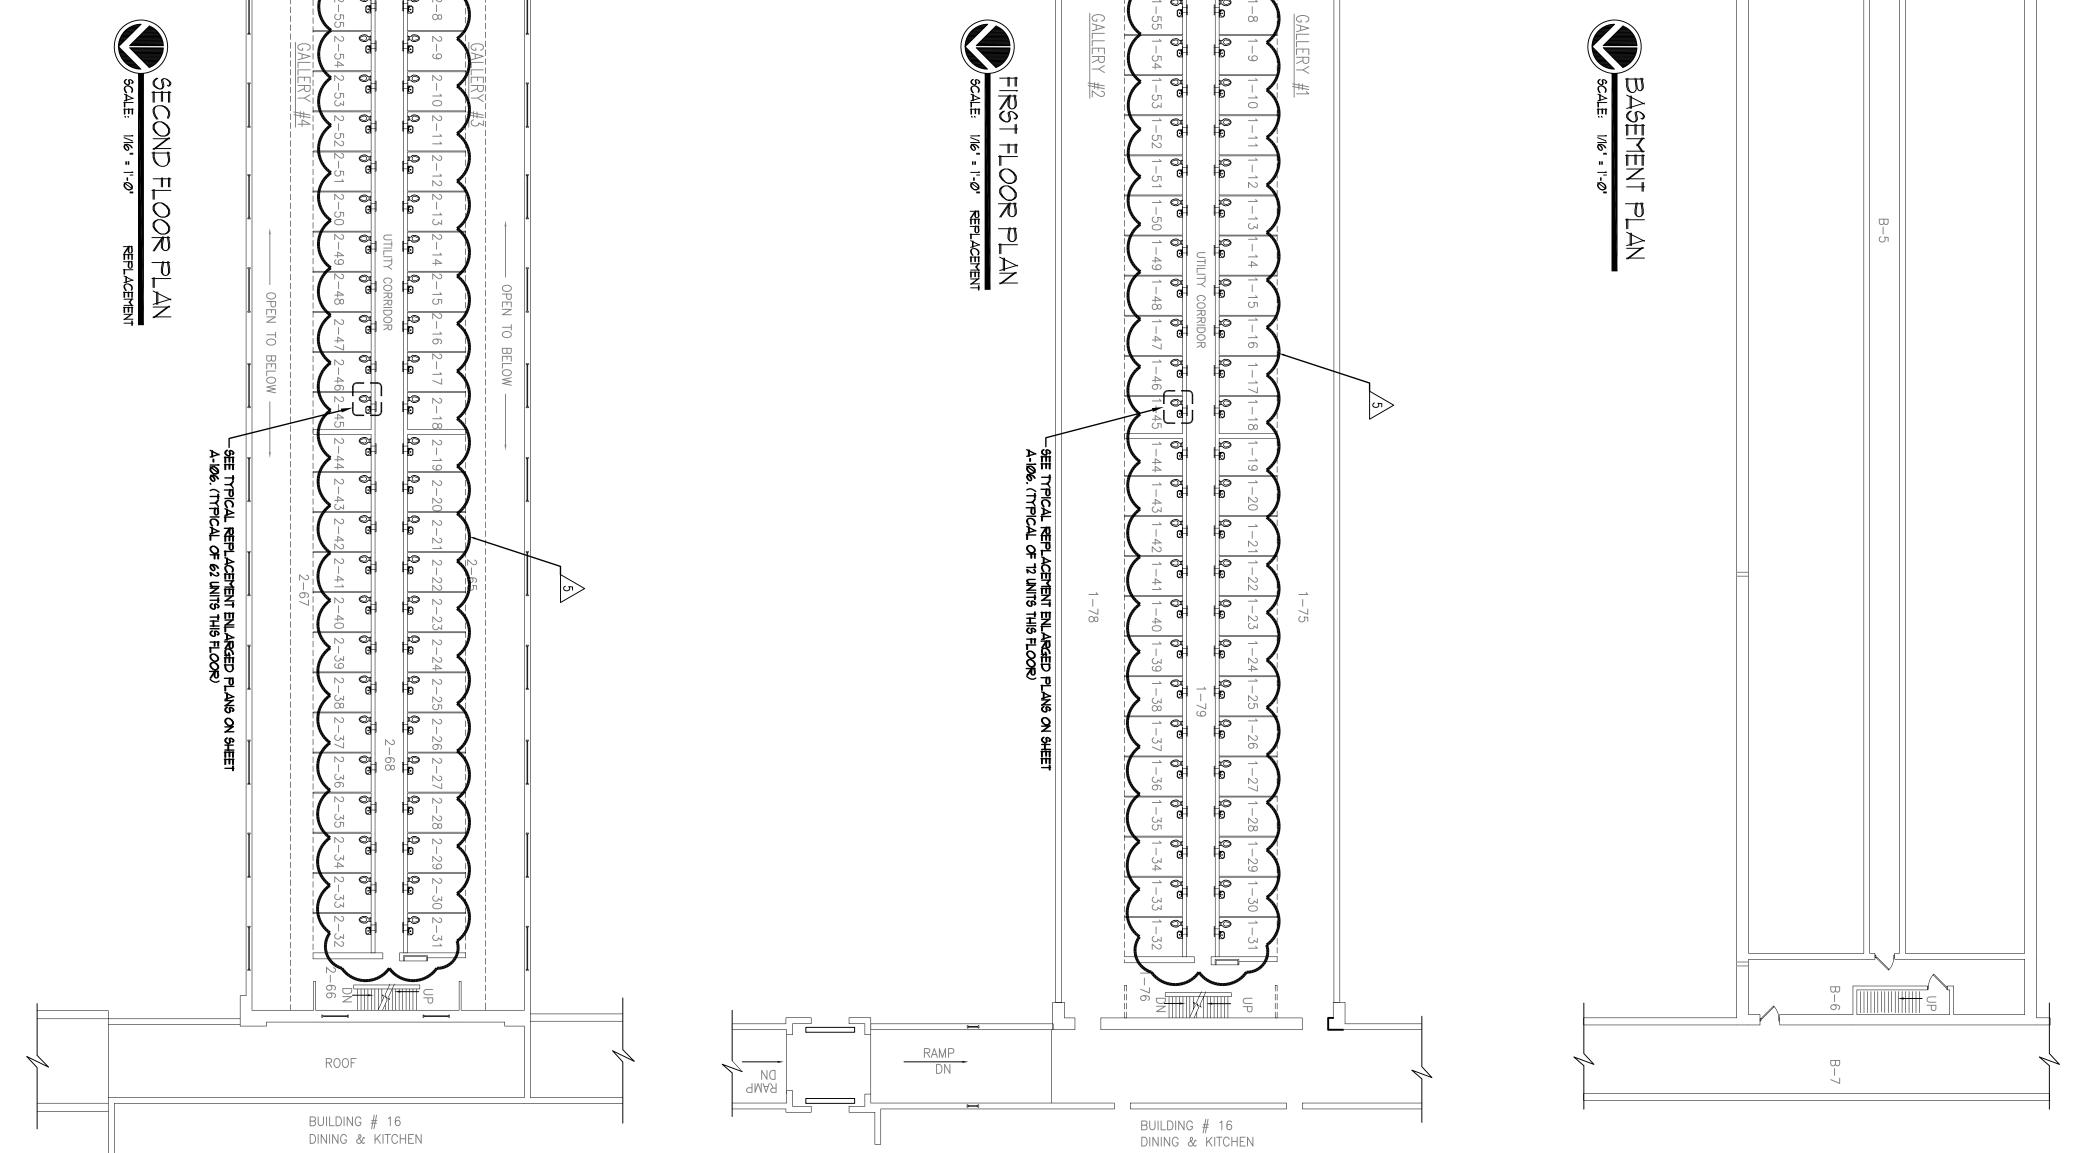
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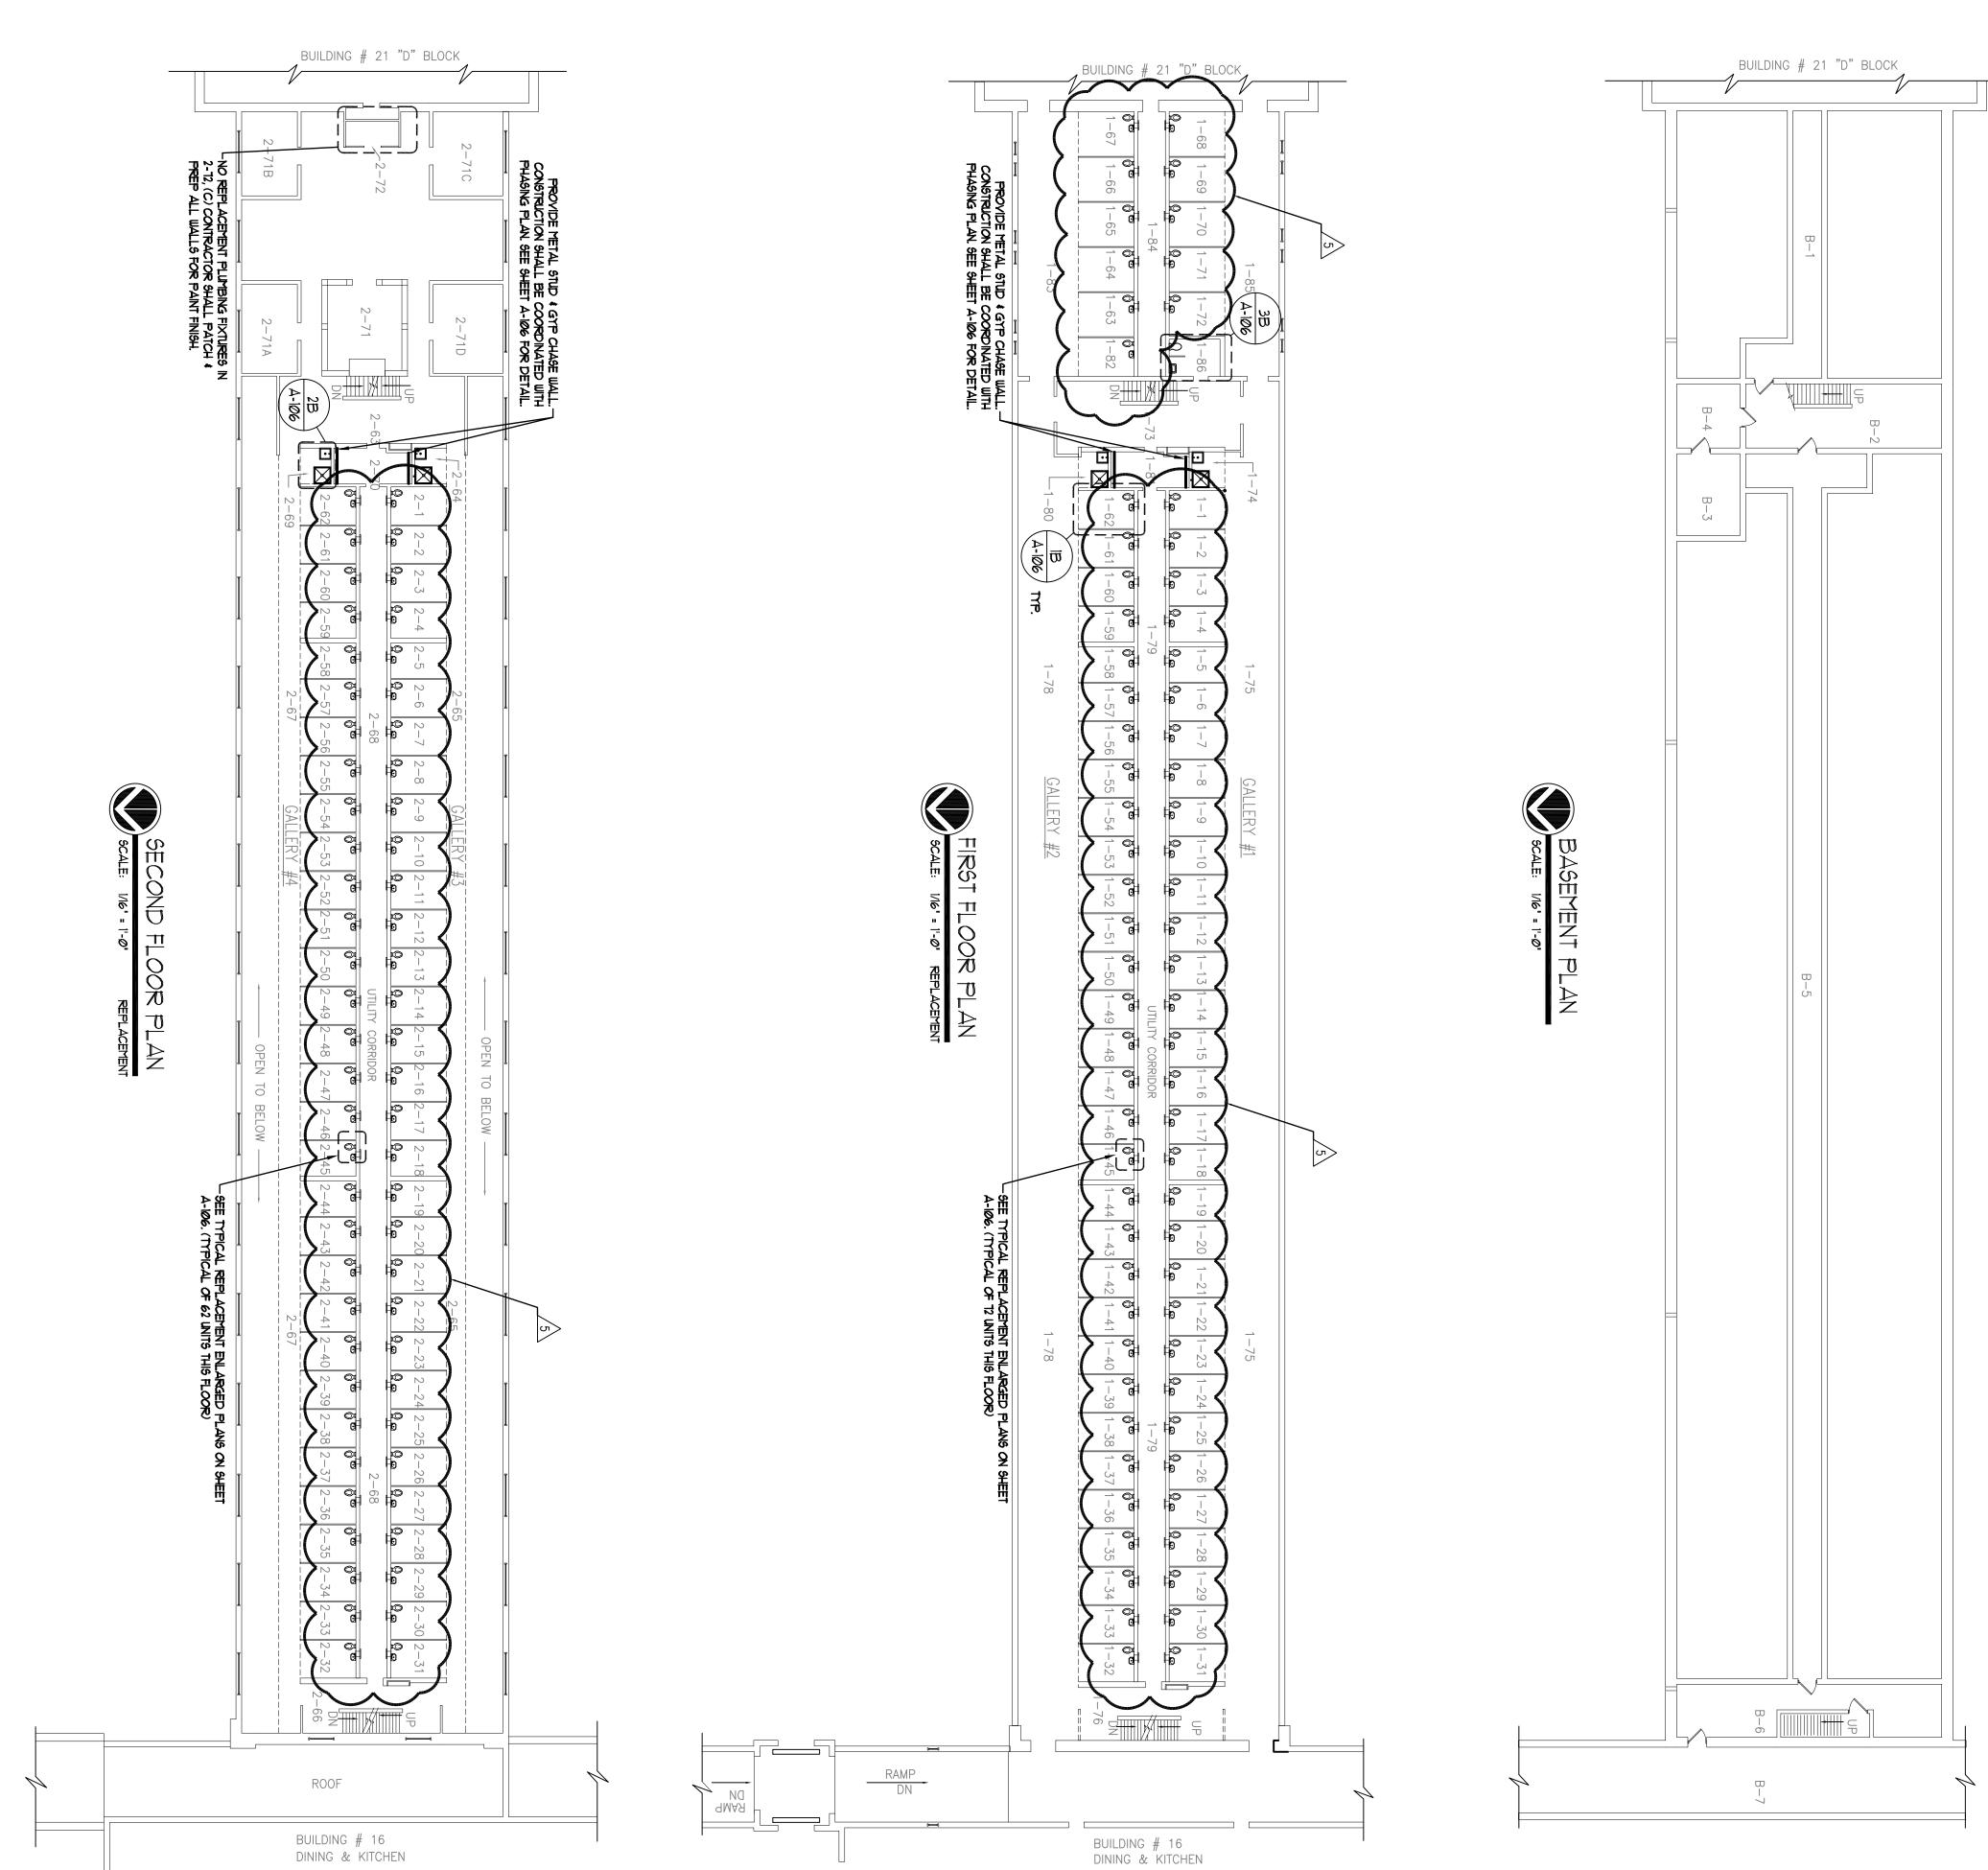
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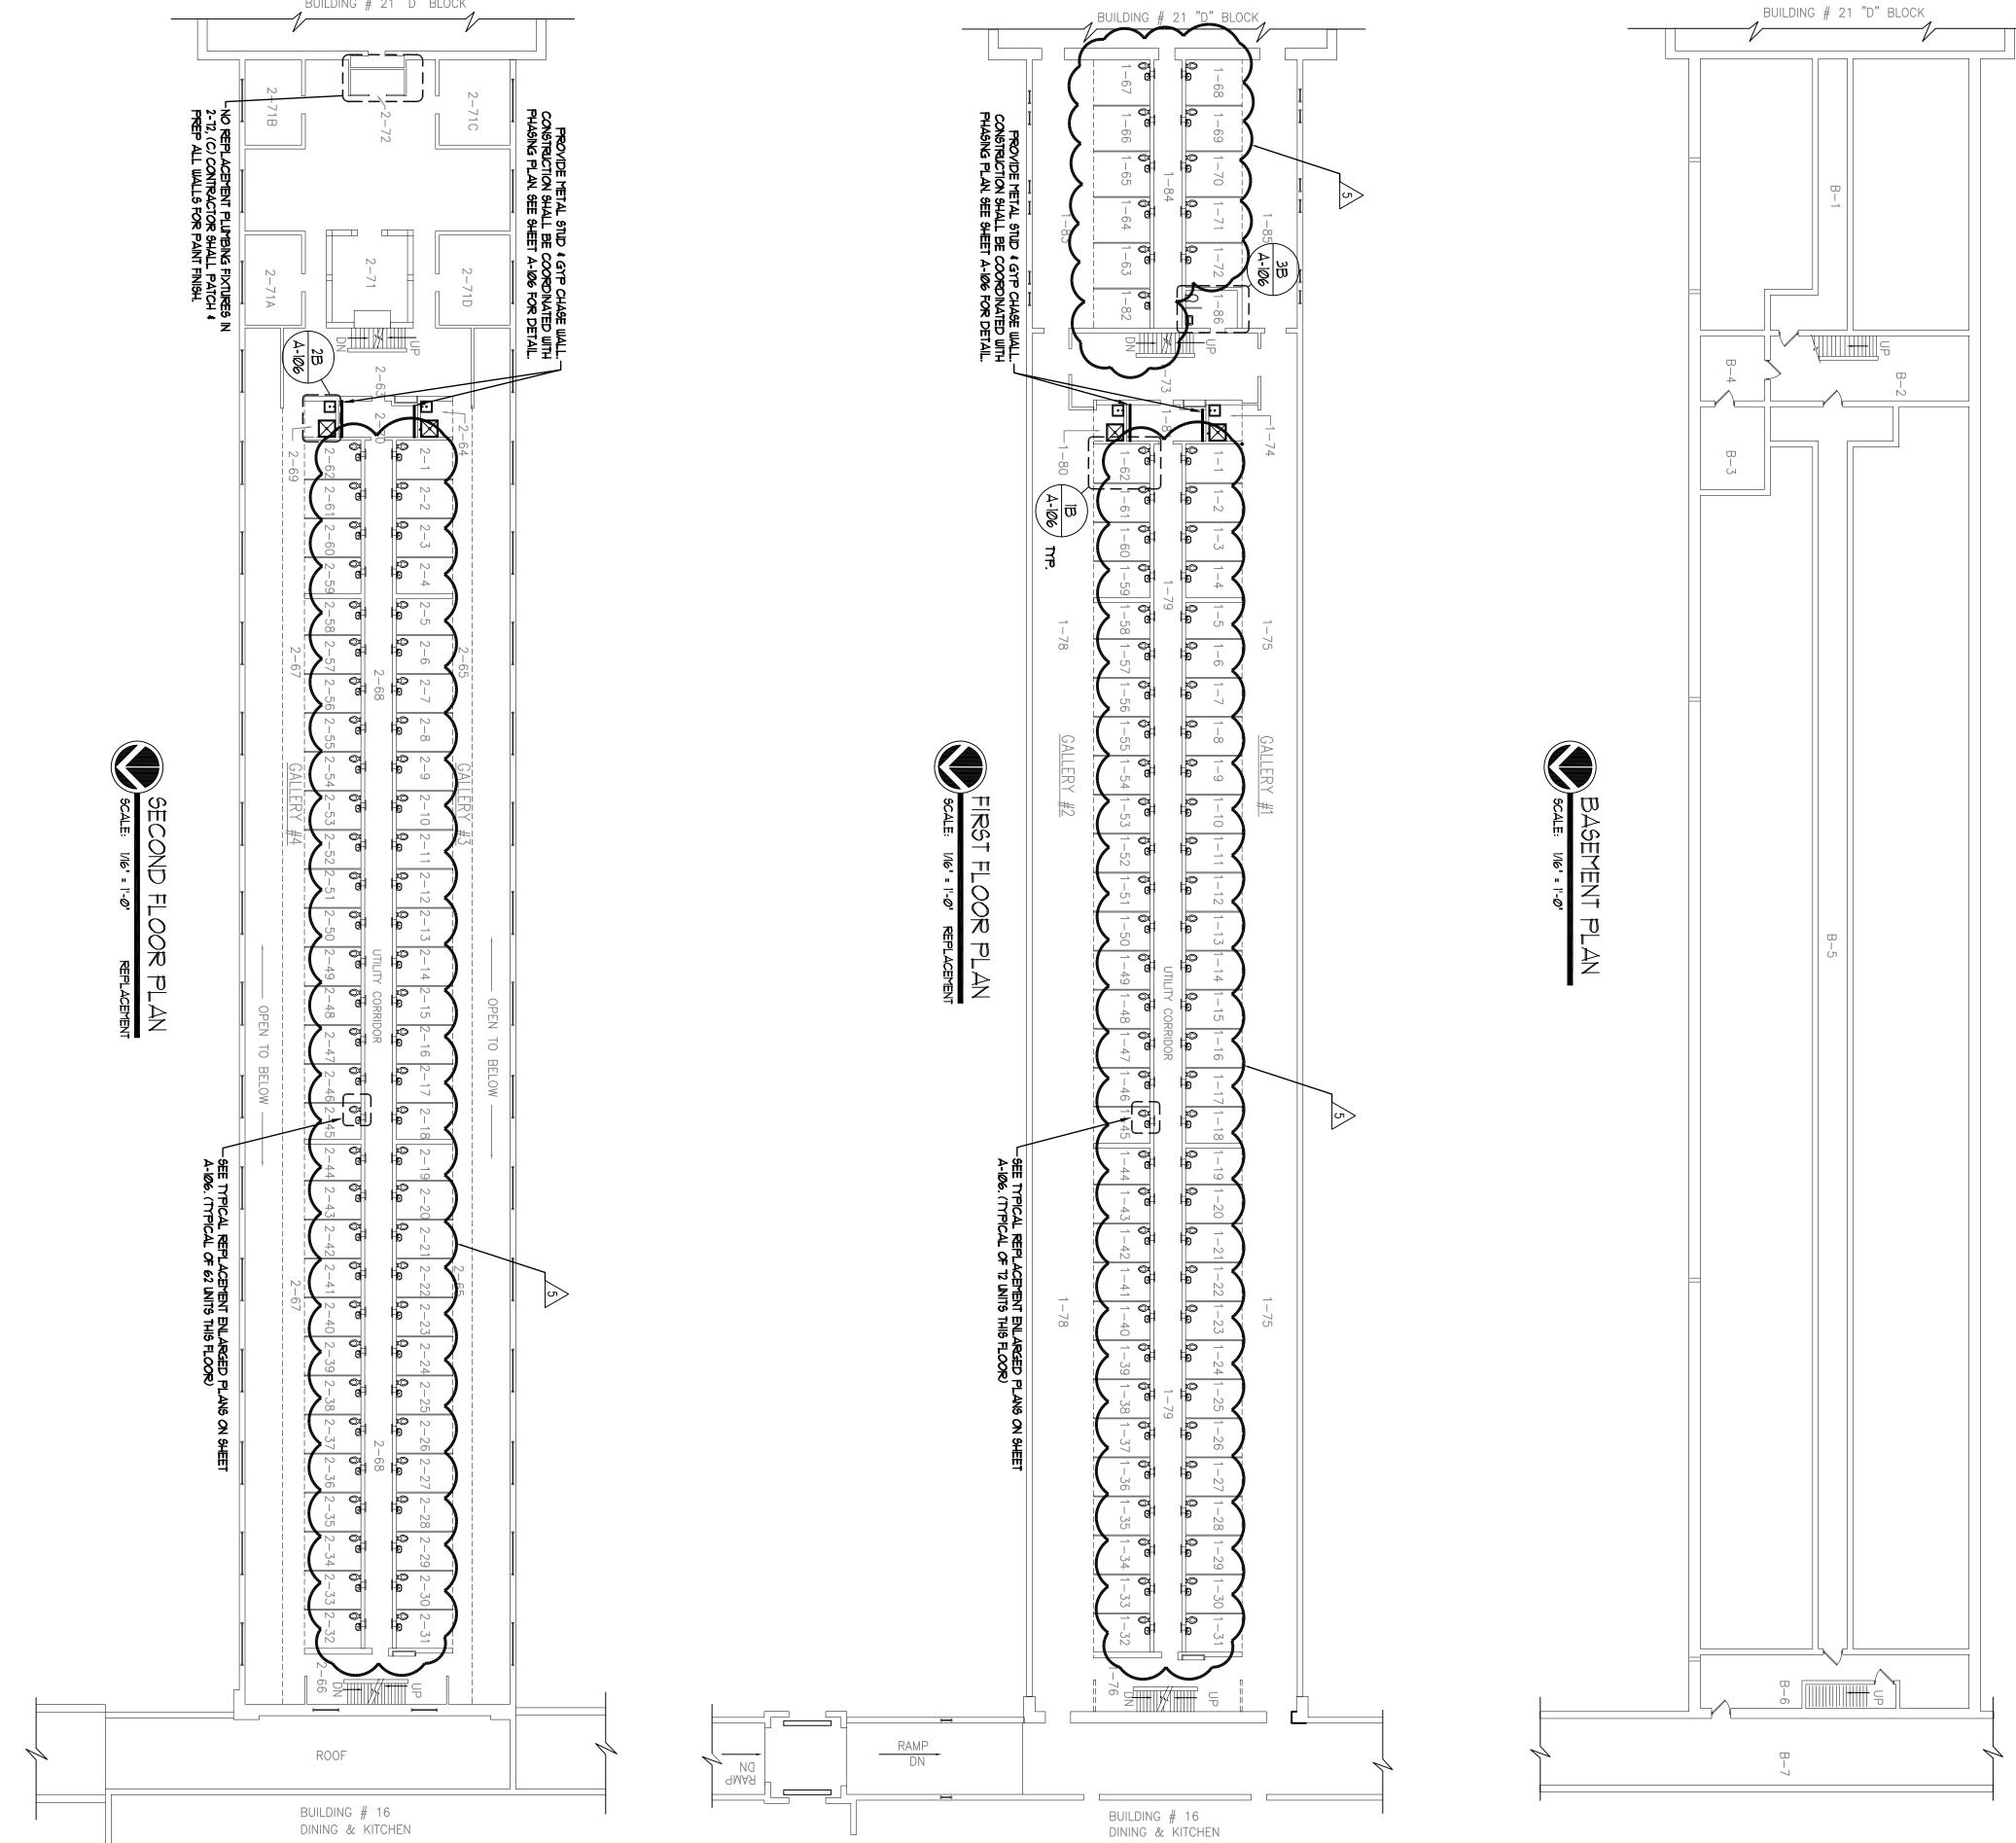
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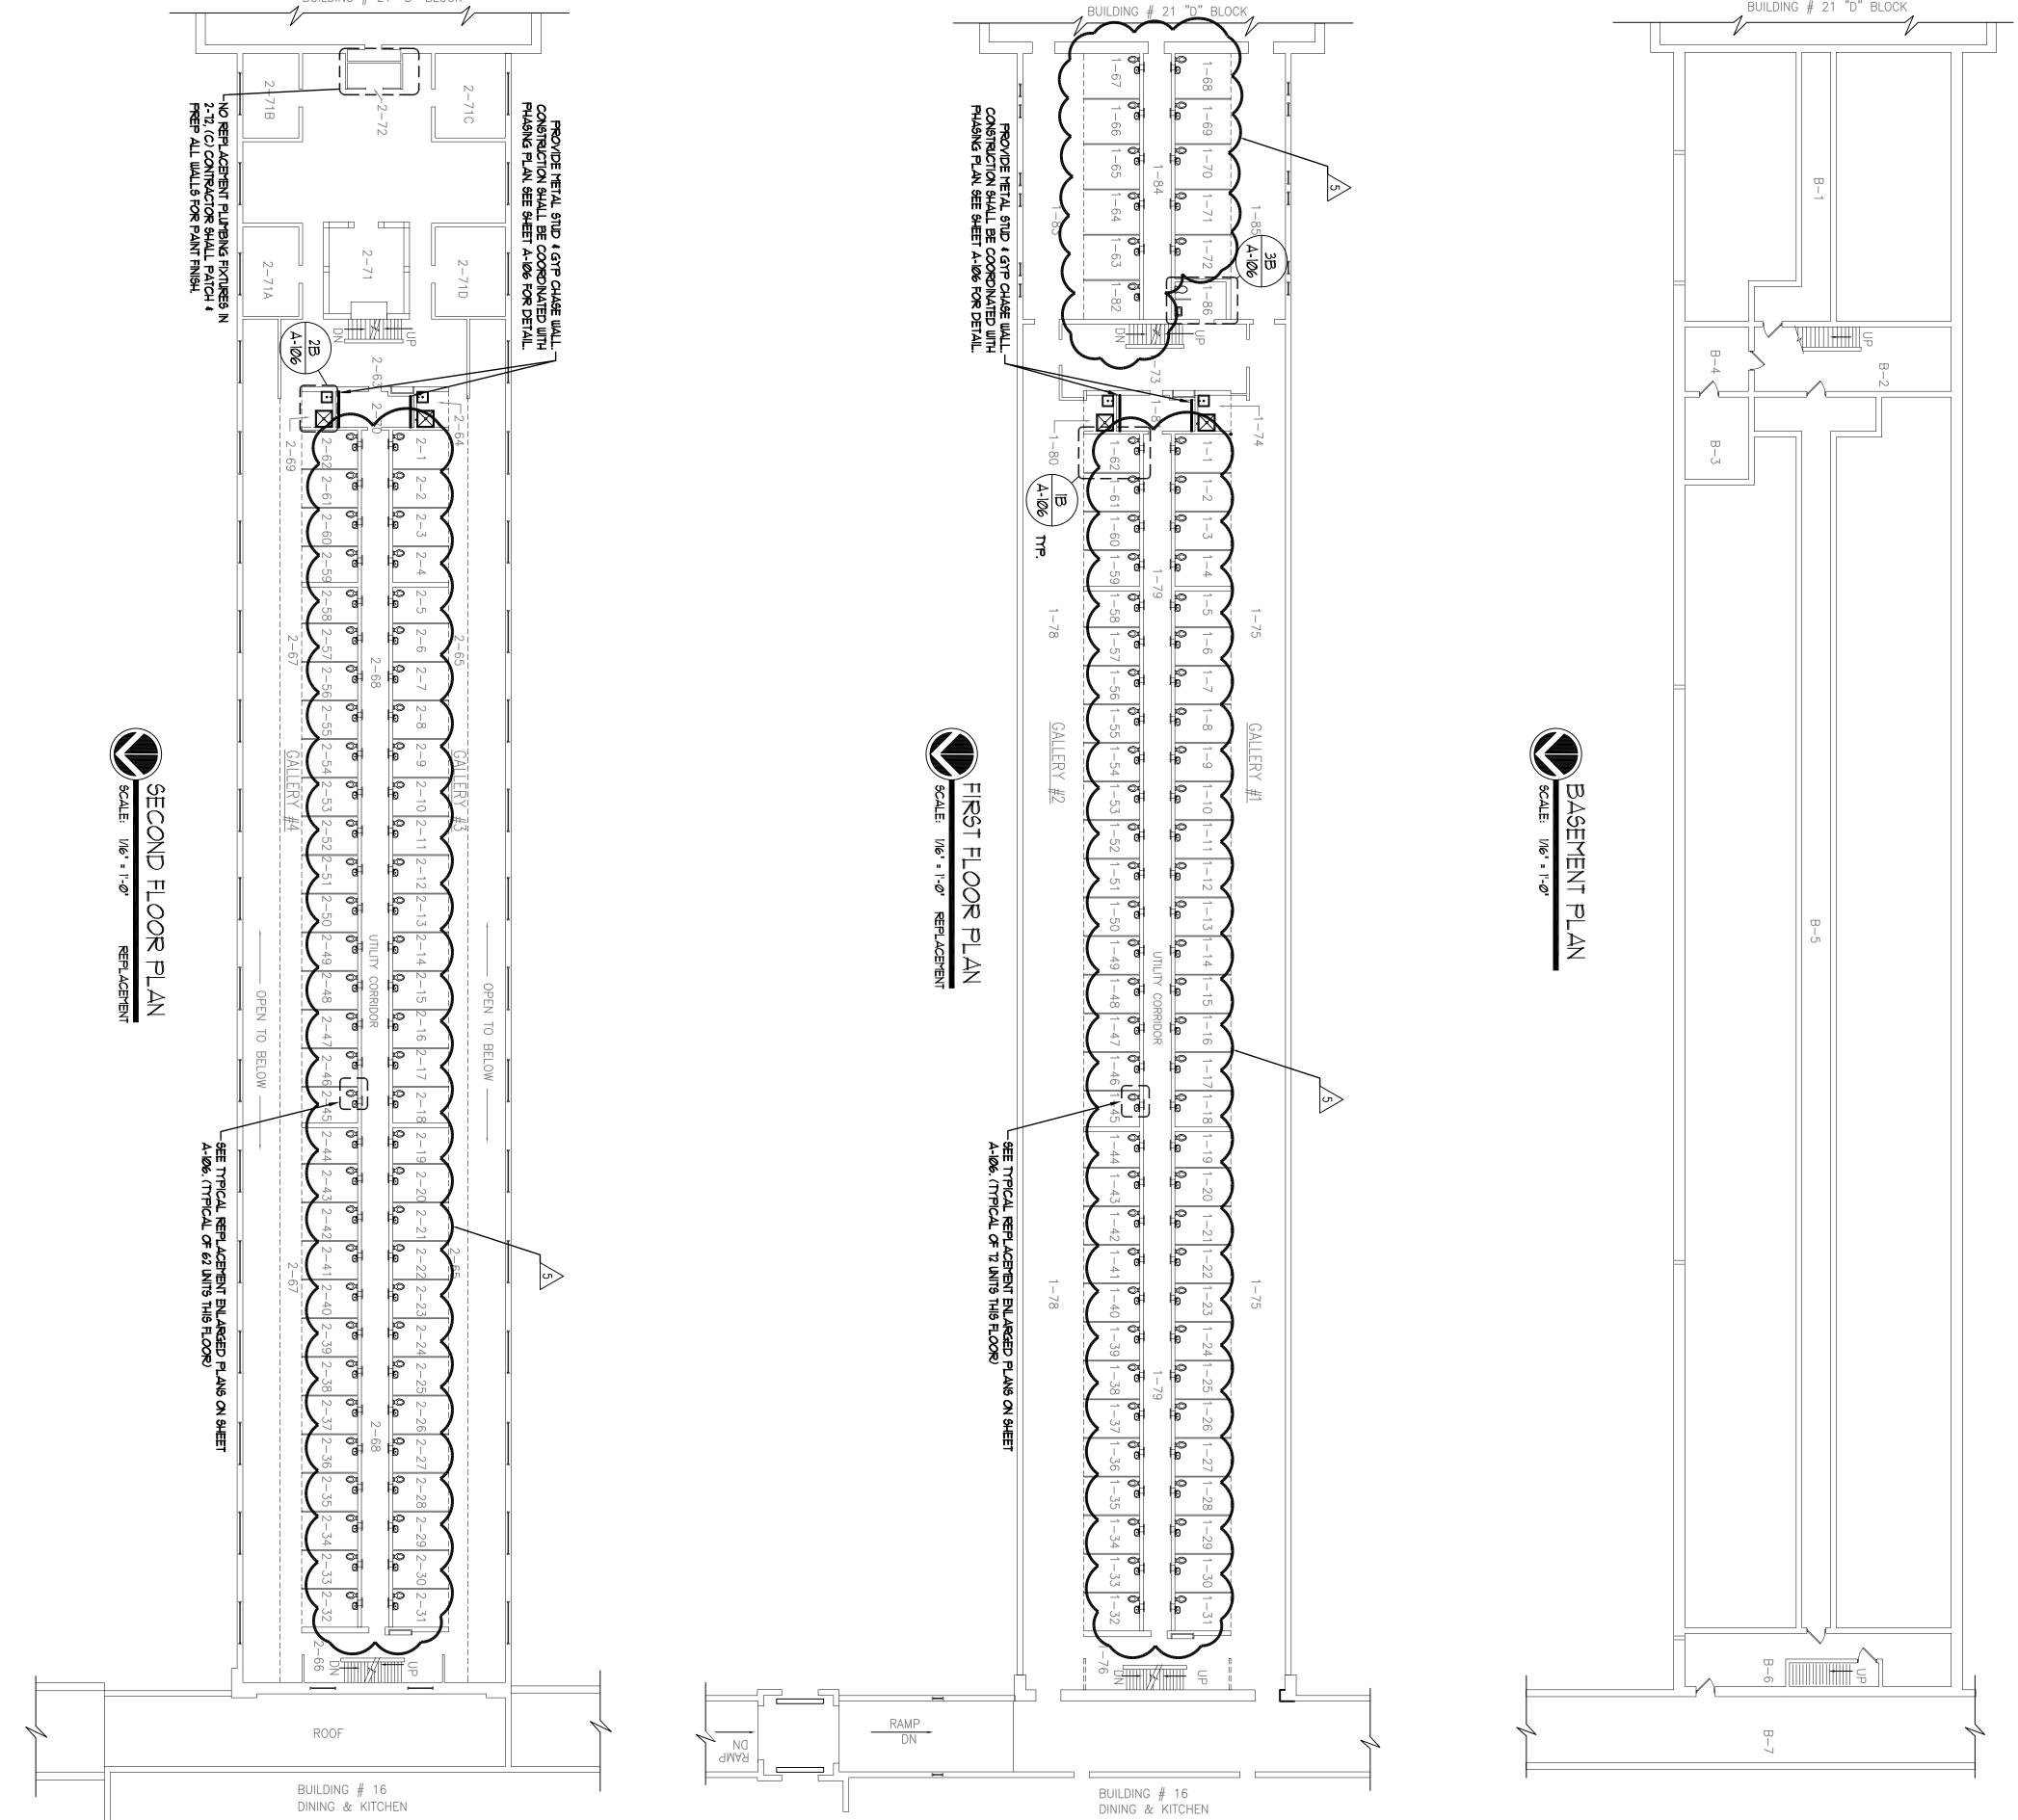
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	 REMOVALS, REPAIR AND ABATEMENT OF LEAD CONTAINING MATERIALS. TIERS 1 TO 4. OVIDE WASTE STACK, VENT STACK & DOMESTIC HOT, COLD & RECIRCULATING RISERS 1 S 1-81, 2-70, 3-63 & 4-70. PROVIDE MOP SERVICE SINK , SHOWER & FLOOR DRAIN IN 3 & 4-70. REMOVE EXISTING RISERS & STACKS AS PER PHASE 11. AS PER PHASE 9 ABOVE. PER PHASE 9 ABOVE. JACENT TO WET COLUMN IN PIPE SPACE FLOORS 1 THROUGH 4. MOVAL OF ALL NON-ESSENTIAL WATER, WASTE, SOIL AND VENT PIPING. W GRADE SOIL & FAI PIPING WHERE INDICATED ON DRAWINGS. 	ELECTRIC AND PLUMBING CONTRACT WORK AT WET COLUMNS A-2 AND C-2. ELECTRIC AND PLUMBING CONTRACT WORK AT WET COLUMNS B-1 AND D-1. ELECTRIC AND PLUMBING CONTRACT WORK FOR WET COLUMNS B-2 AND D-2. JACENT TO WET COLUMN D-2. H: REMOVALS, REPAIRS AND ABATEMENT OF LEAD CONTAINING MATERIALS IN CELLS 1-63 TO -82 AND SECOND AND FOURTH THER CORRECTIONAL OFFICERS TOILET ROOMS 2-72 AND CTIONAL OFFICERS' TOILET ROOMS 2-72, AND EXISTING LOCAL PIPING IN CELLS 1-63 TO SERVICE SINK IN JANITOR'S ROOM 1-82. REMOVE WATER CLOSETS AND LAVATORY IN SECOND CTIONAL OFFICERS' TOILET ROOMS 2-72, AND 2-74, PROVIDE SOLL AND LAVATORY IN SECOND CTIONAL OFFICERS' TOILET ROOMS 2-74, PROVIDE SOLL AND LAVATORY IN SECOND CORRECTIONAL OFFICERS' TOILET ROOMS ON THE SECOND AND FOURTH TIERS. D WATER RISERS TO NEW MAINS IN THE BASEMENT UTILITY CORRIDOR. H: H: H: H: H: H: H: H: H: H:	A CORRECTIONAL FACILITY, BUILDING 20 INCLUDES THE FOLLOWING WHILE MAINTAINING FULL TAY COCUPED FACILITY, BUILDING 20 INCLUDES THE FOLLOWING WHILE MAINTAINING FULL TAY CORRECTIONAL FACILITY, BUILDING 20 INCLUDES THE FOLLOWING WHILE MAINTAINING FULL THE COLUMES, FLUMBING SOL, WASTE AND VENT STACKS. ACCOMPLISHED BY PROVIDING PARALLEL RISERS AND STACK SWITH TEMPORARY PLUGGED SOL ACCOMPLISHED BY PROVIDING PARALLEL RISERS AND STACKS WITH TEMPORARY PLUGGED SOL ACCOMPLISHED BY PROVIDING PARALLEL RISERS AND STACKS WITH TEMPORARY PLUGGED SOL ACCOMPLISHED BY PROVIDING OUTSIDE THE BUILDING FOR FINAL CONNECTION. UTILITY CORRIDOR EXTENDING OUTSIDE THE BUILDING FOR FINAL CONNECTION. UTILITY CORRIDOR EXTENDING OUTSIDE FILE I DOMESTIC WAITER MAINS IN THE BASEMENT THAT CONNECT OUTSIDE OF THE BUILDING, WITH ID WATER CONNECTIONS. AND BASEMENT THAT CONNECT OUTSIDE OF THE BUILDING, WITH ID WATER CONNECTIONS FOR BOTH THE BASEMENT THAT CONNECT OUTSIDE OF THE BUILDING, WITH ID WATER CONNECTIONED FOR BOTH THE FIRE AND COLD WATER SERVICE ENTRANCES. IT STACKS AND DOMESTIC COLD WATER RISERS ADJACENT TO THE EXISTING 1939 RISERS IN THESE STACKS AND DOMESTIC COLD WATER RISERS ADJACENT TO THE AND COLD WATER SERVICE ENTRANCES. IT STACKS AND DOMESTIC COLD WATER RISERS ADJACENT TO THE EXISTING 1939 RISERS IN THESE STACKS AND ABATEMENT OF LEAD CONTAINING MATERIALS, WET COLUMN A-1, SET COLUMN A-1, CELLS 1-55 TO 1-8. WET COLUMN A-1, CELLS 2-55 TO 2-62. CONTRACT WORK AS ABOVE: WET COLUMN A-1, CELLS 2-55 TO 2-62. CONTRACT WORK AS ABOVE: WET COLUMN A-1, CELLS 2-55 TO 2-62. CONTRACT WORK AS ABOVE: WET COLUMN A-1, CELLS 2-55 TO 2-62. CONTRACT WORK AS ABOVE: WET COLUMN A-1, CELLS 2-55 TO 2-62. CONTRACT WORK AS ABOVE: WET COLUMN A-1, CELLS 2-55 TO 2-62. CONTRACT WORK AS ABOVE: WET COLUMN A-1, CELLS 2-55 TO 2-62. CONTRACT WORK AS ABOVE: WET COLUMN A-1, CELLS 2-55 TO 2-62. CONTRACT WORK AS ABOVE: WET COLUMN A-1, CELLS 2-55 TO
AND COMMUNITY SUPERVISION Image: 1 Image: 1	CONTRACT: CONTRACT: CONSTRUCTION TITLE: REPLACE PLUMBING C BLOCK, BUILDING 20 LOCATION: ELMIRA CORRECTIONAL FACILITY 1879 DAVIS STREET, BOX 500 ELMIRA, NEW YORK CLIENT: DEPARTMENT OF CORRECTIONS AND COMMINITY SUPERVISION	WARNING: THE ALTERATION OF THIS MATERIAL IN ANY WAY, UNLESS DONE UNDER THE DIRECTION OF A COMPARABLE PROFESSIONAL, I.E. ARCHITECT FOR AN ARCHITECT, ENGINEER FOR AN ENGINEER OR LANDSCAPE ARCHITECT FOR A LANDSCAPE ARCHITECT, IS A VIOLATION OF THE NEW YORK STATE EDUCATION LAW AND/OR REGULATIONS AND IS A CLASS 'A' MISDEMEANOR.	AVES OFFICE OF GENERAL SERVICES NVS OFFICE OF GENERAL SERVICES Serving New York ANDREW M. CUOMO Governor ROANN M. DESTITO Commissioner BERNIER CARR & ASSOCIATES Inglineers - architects - land surveyors









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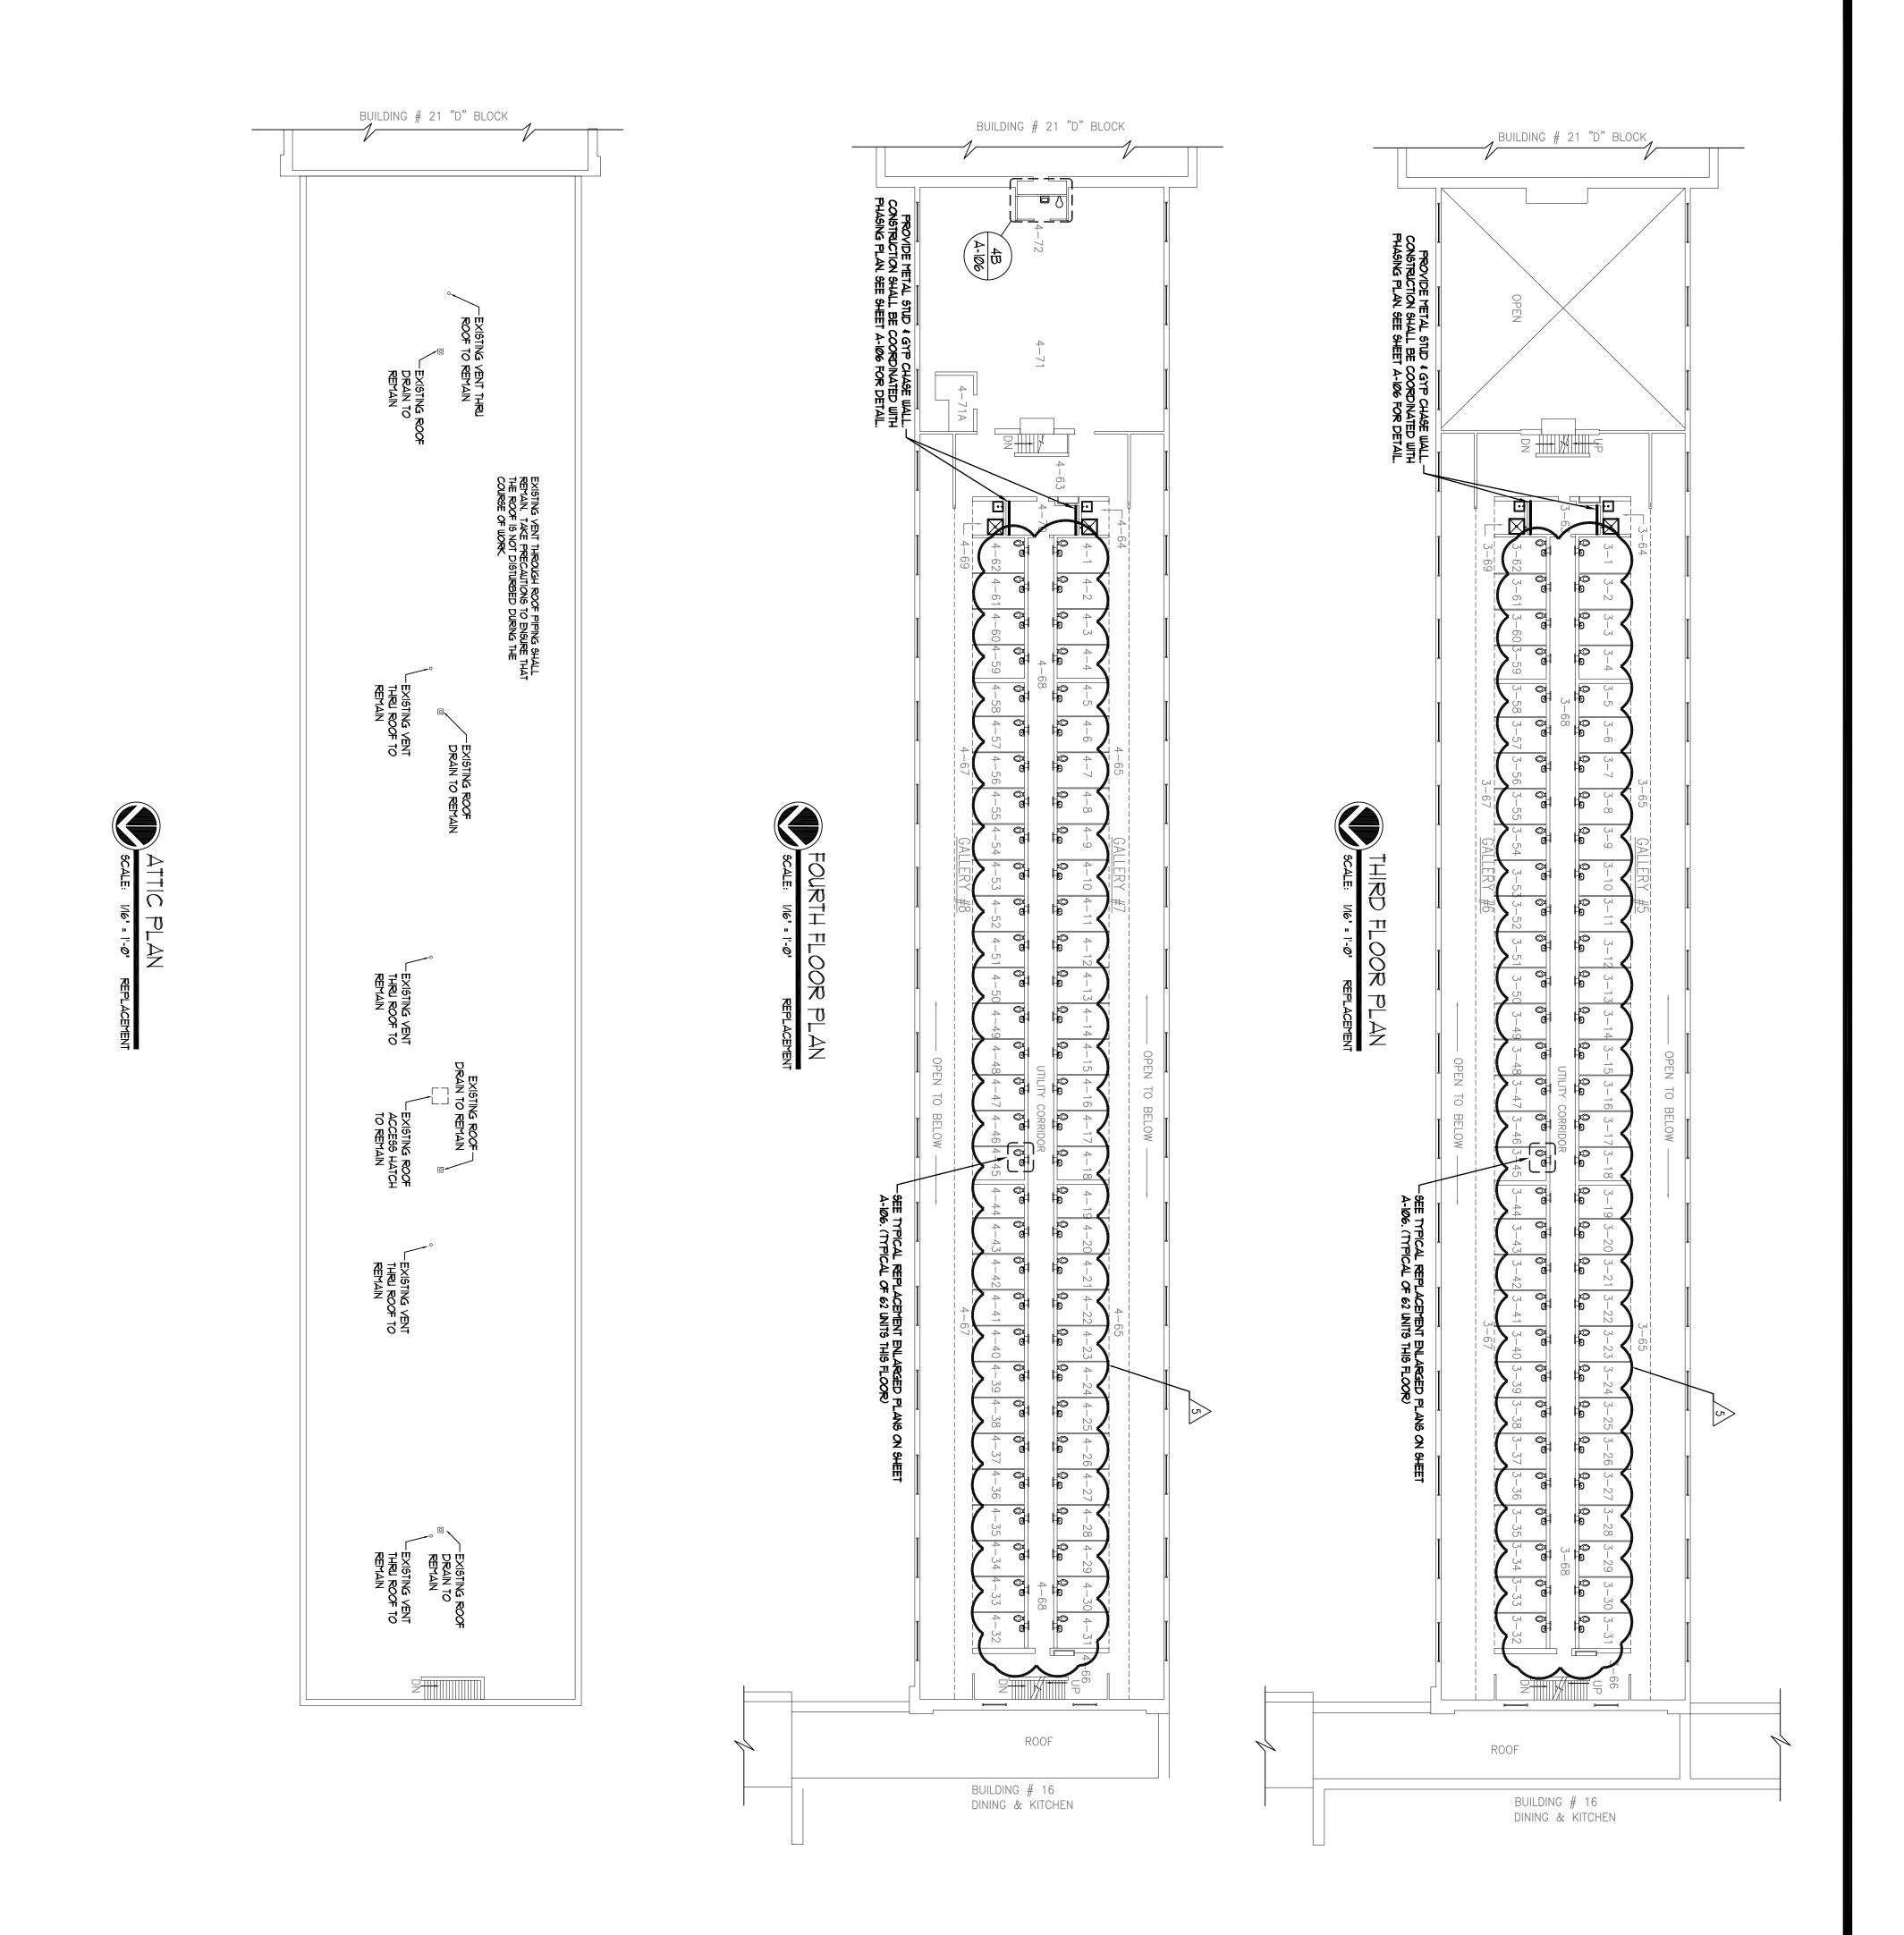
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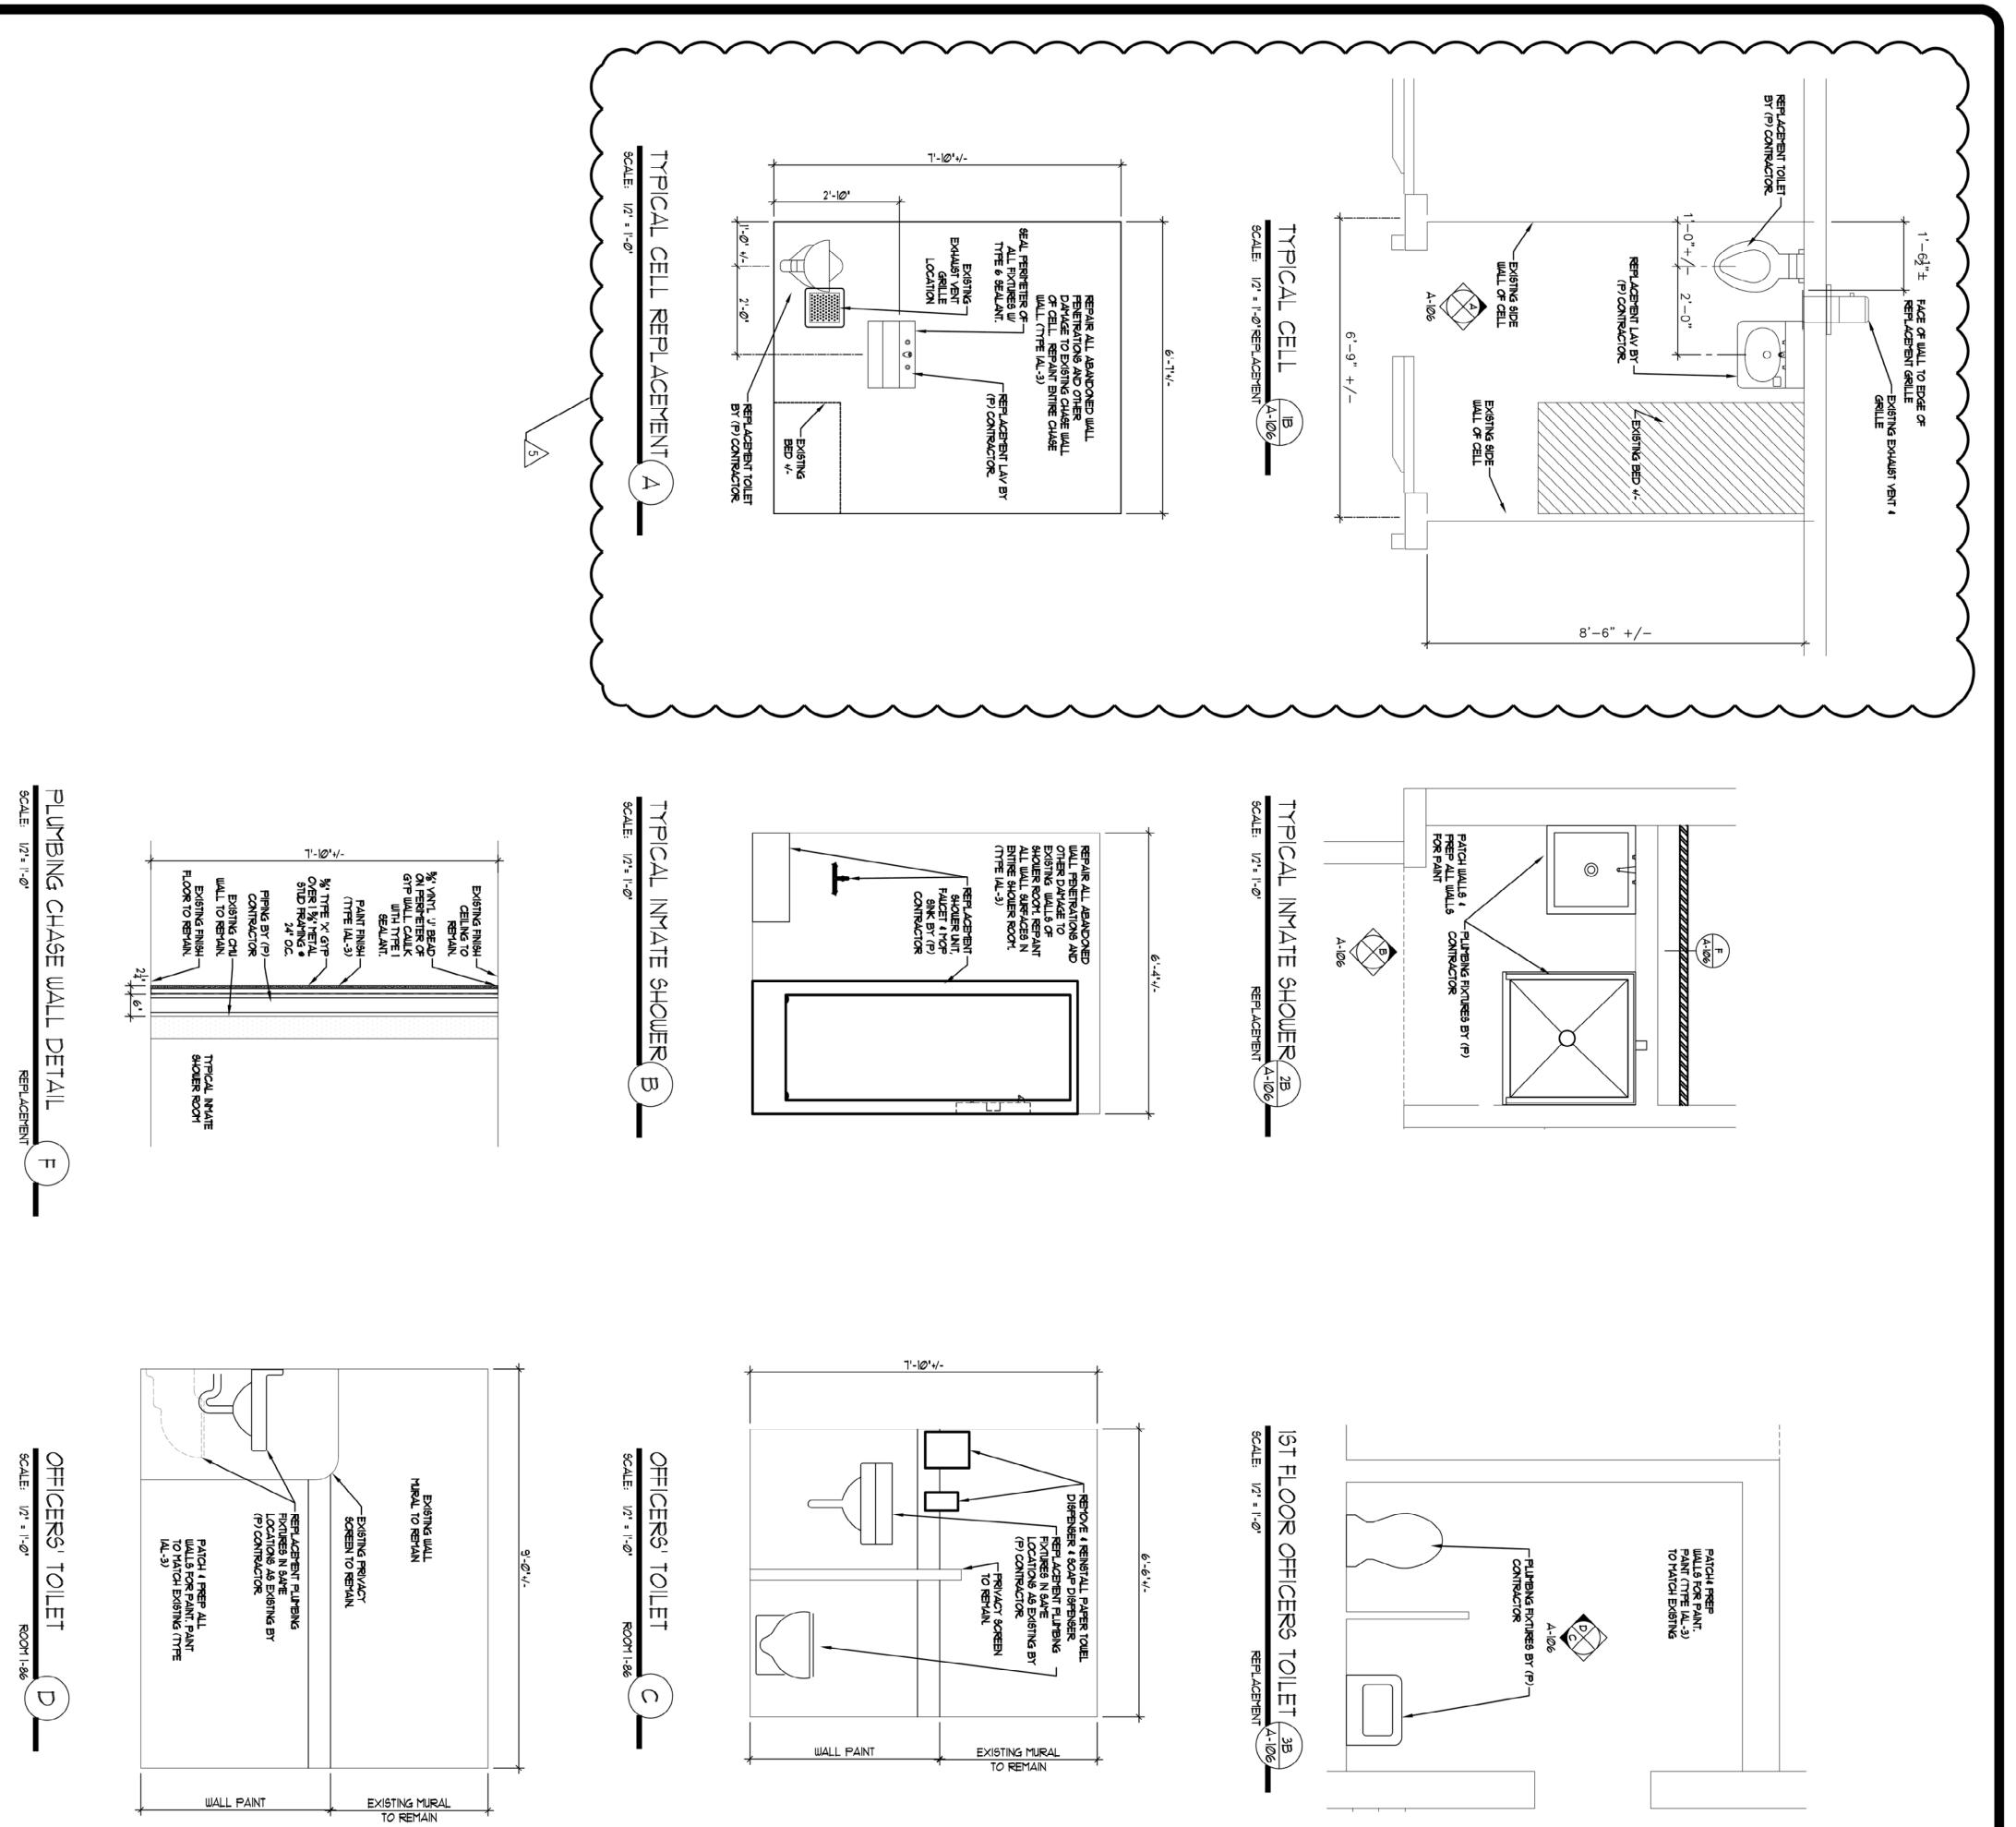


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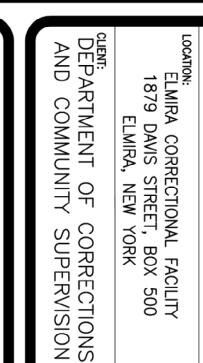
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REPLACEMENT PLUMBING FIXTURES IN SAME LOCATIONS AS EXISTING BY (P) CONTRACTOR

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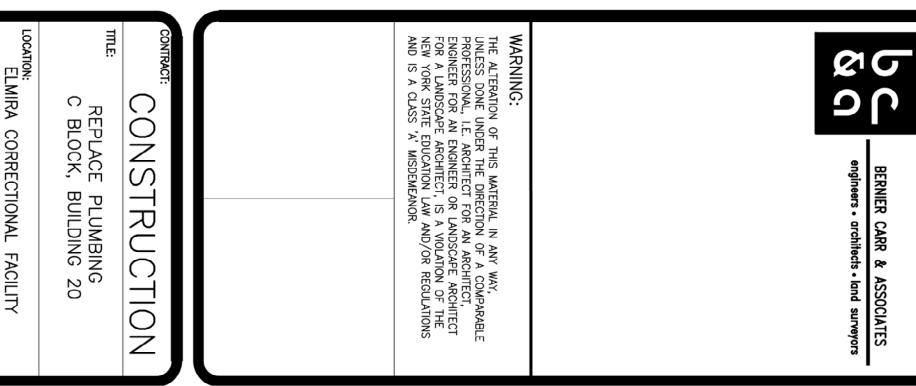
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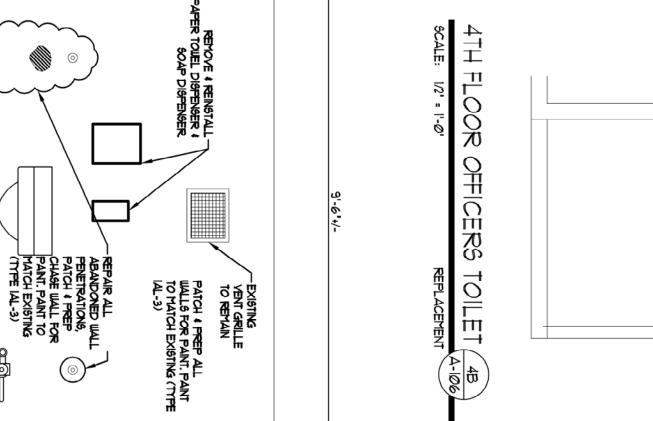
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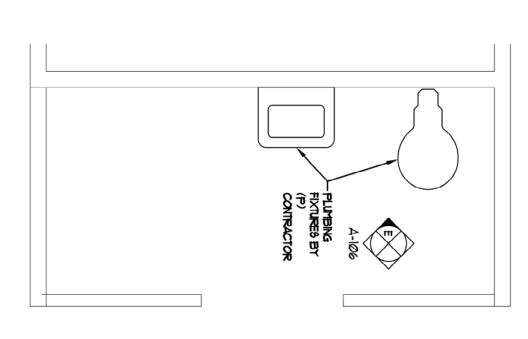
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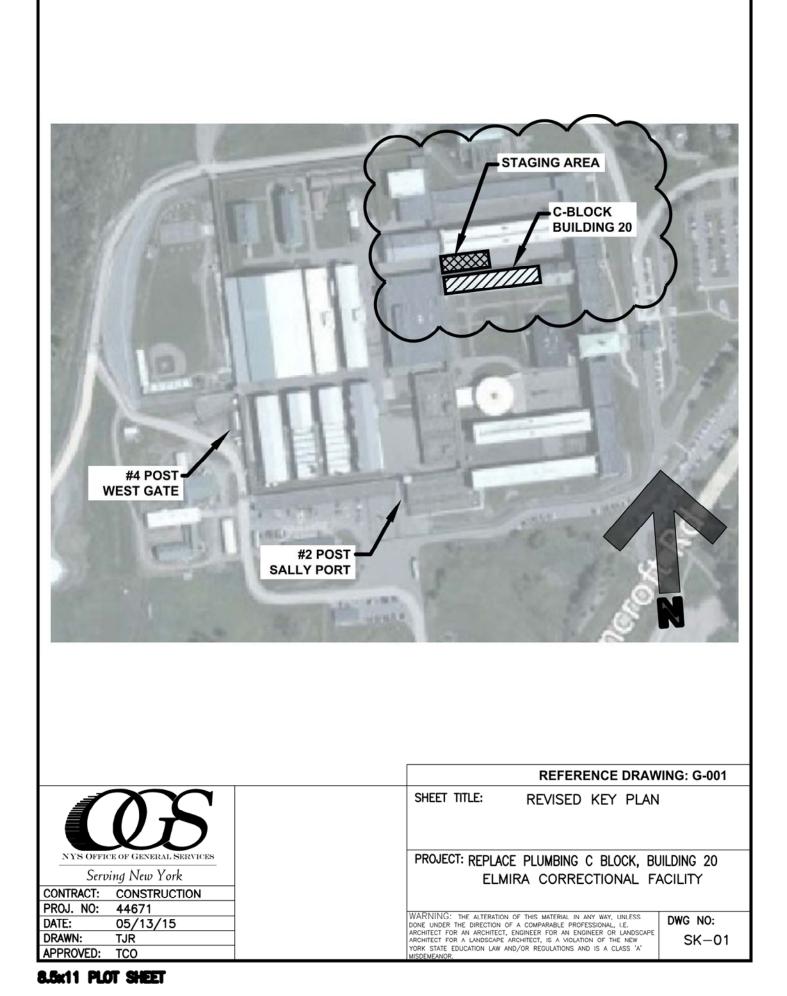
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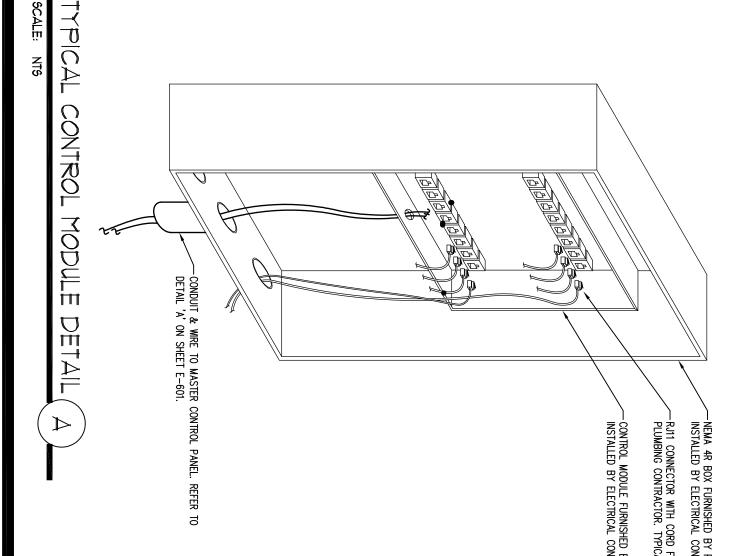
GENERAL NOTES

- PROVIDE ELECTRICAL CONNECTION FOR EVERY FIXTURE, OR ITEM OF DRAWING OR NOTED IN TECHNICAL SPECIFICATION. EQUIPMENT REQUIRING SAME, WHICH IS SHOWN ON CONTRACT
- ? .¹ INSTALL EQUIPMENT IN ACCORDANCE WITH THE MANUFACTURER'S RECOMMENDATIONS & CONDITIONS FOR WARRANTY & GUARANTEE. PROVIDE ACCESSORIES REQUIRED FOR A COMPLETE INSTALLATION READY FOR CONTINUOUS USE.
- ы. COMPLY WITH LOCAL & APPLICABLE CODES. IN THE EVENT OF A CONFLICT THE MOST STRINGENT SHALL GOVERN. SHOULD A CONFLICT ARISE BETWEEN CONSTRUCTION DOCUMENTS & APPLICABLE CODES, WORK SHALL COMPLY WITH THE REQUIREMENTS OF THE ENFORCING CODE AUTHORITIES.
- 9. 4. GROUNDING: PROVIDE GROUNDING & BONDING IN ACCORDANCE WITH NEC ARTICLE 250. CONDUCTORS SHALL BE COPPER. FEEDERS, BRANCH CIRCUITS, & OTHER WIRING SYSTEMS SHALL HAVE A SEPARATE DEDICATED GREEN INSULATED GROUND WIRE. BONDING: PROVIDE BONDING IN ACCORDANCE WITH NEC ARTICLE 250. ELECTRICALLY CONDUCTIVE MATERIALS ASSOCIATED WITH THE PROJECT SHALL BE CONNECTED TOGETHER IN A MANNER THAT CREATES A PERMANENT, LOW IMPEDANCE PATH FOR GROUND FAULT CURRENT. COORDINATE ELECTRICAL CHARACTERISTICS & CIRCUIT PROTECTION REQUIREMENTS OF EQUIPMENT SUPPLIED, REGARDLESS OF TRADE. PROVIDE NECESSARY REVISIONS TO FEEDERS &/OR CIRCUIT PROTECTION TO MEET ACTUAL MANUFACTURER NAMEPLATE DATA.
- 10. EQUIPMENT OR MATERIALS PROVIDED SHALL BE NEW & BE A PRODUCT OF THE SAME MANUFACTURER, UNLESS NOTED OTHERWISE. 11. BRANCH CIRCUITS REQUIRING A NEUTRAL SHALL HAVE SEPARATE DEDICATED FULL SIZE NEUTRAL CONDUCTORS. 12. EXISTING SYSTEMS FEEDERS & BRANCH CIRCUITS WHICH PASS THROUGH ALTERED AREAS & SERVE OTHER AREAS SHALL RF MAINT. BE RESPONSIBLE FOR LOCATING & MADING THEORY FOR LOCATION & MADING THEORY FOR LOCATING A MADING THEORY FOR LOCATING EXISTING SYSTEMS FEEDERS & BRANCH CIRCUITS WHICH PASS THROUGH ALTERED AREAS & SERVE OTHER AREAS SHALL BE MAINTAINED. BE RESPONSIBLE FOR LOCATING & AVOIDING THESE FEEDERS & BRANCH CIRCUITS. IF DISTURBED, THEY SHALL BE REPAIRED & BROUGHT BACK ON-LINE PROMPTLY & AT THE CONTRACTORS EXPENSE.
- 13. 14. COORDINATE ARRANGEMENT, MOUNTING & SUPPORT OF ELECTRICAL CONDUIT TO ALLOW MAXIMUM POSSIBLE HEADROOM. PERFORM WORK & PROVIDE MATERIALS & EQUIPMENT AS SHOWN ON DRAWINGS. COORDINATE ELECTRICAL WORK WITH WORK OF OTHER SECTIONS. GIVE NOTICES, FILE PLANS, OBTAIN PERMITS & LICENSES, PAY FEES & BACK CHARGES, & OBTAIN NECESSARY APPROVALS FROM AUTHORITIES THAT HAVE JURISDICTION.
- 15. PERFORM WORK AS REQUIRED BY CODES, REGULATIONS & LAWS OF LOCAL, STATE & FEDERAL GOVERNMENTS & OTHER AUTHORITIES WITH LAWFUL JURISDICTION. MATERIAL & EQUIPMENT SHALL BE UL, NEMA, ANSI, IEEE, ADA, & APPROVED FOR INTENDED SERVICES.
- 16. MAINTAIN RECORD DRAWINGS ON SITE. RECORD SET MUST BE COMPLETE & CURRENT & AVAILABLE FOR INSPECTION WHEN REQUISITIONS FOR PAYMENT ARE SUBMITTED. GUARANTEE WORK IN WRITING FOR ONE YEAR FROM DATE OF FINAL ACCEPTANCE.
- 17. SHOP DRAWINGS & SUBMITTALS SHALL BE PROVIDED FOR EQUIPMENT SHOWN ON THE DRAWINGS. DEVIATION FROM CONTRACT DOCUMENTS, OR PROPOSED SUBSTITUTION OF MATERIALS OR EQUIPMENT FOR THOSE SPECIFIED, SHALL BE REQUESTED IN ACCORDANCE WITH THE CONTRACT REQUIREMENTS WHETHER DEVIATIONS ARE DUE TO FIELD CONDITIONS, STANDARD SHOP PRACTICE, OR OTHER CAUSE.


- 18. WIRING SHALL BE RUN CONCEALED UNLESS SPECIFIED OTHERWISE.
 19. RACEWAYS SHALL BE INSTALLED IN A NEAT & WORKMANLIKE MANNER, RECTILINEAR TO BUILDING STRUCTURE.
 20. EQUIPMENT SHALL BE INSTALLED IN A NEAT & WORKMANLIKE MANNER, RECTILINEAR TO BUILDING STRUCTURE.
 21. RACEWAYS RUNNING THROUGH BUILDING EXPANSION JOINTS SHALL BE EQUIPPED WITH EXPANSION FITTINGS.
 22. MINIMUM BRANCH CIRCUIT WIRING SHALL BE NO. 12 AWG SOLID COPPER. BRANCH CIRCUITS LONGER THAN 75 FEET FOR 120V CIRC SHALL BE AT LEAST #10 FROM PANEL TO LAST OUTLET.
 23. MINIMUM BRANCH CIRCUIT WIRING SHALL BE NO. 12 AWG SOLID COPPER. BRANCH CIRCUITS LONGER THAN 75 FEET FOR 120V CIRC SHALL BE AT LEAST #10 FROM PANEL TO LAST OUTLET. SLID
- 24.
- 25. FIELD VERIFY EXISTING CONDITIONS & DIMENSIONS PRIOR TO COMMENCEMENT OF ANY WORK OR SHOP FABRICATION. REQUIRED CHANGES TO WORK SHOWN ON CONSTRUCTION DRAWINGS SHALL BE APPROVED BY THE ENGINEER IN WRITING, OTHER TRADES & DIRECTOR'S REPRESENTATIVE AS REQUIRED PRIOR TO ANY CONSTRUCTION.
- 26. THE WORK INCLUDED IN THIS CONTRACT ENCOMPASSES THE DRAWINGS & SPECIFICATIONS. WORK INCLUDED ON THE DRAWINGS ONLY, OR IN THE SPECIFICATIONS ONLY, SHALL BE INCORPORATED AS IF INCLUDED IN BOTH. SYSTEMS SHOWN ARE INTENDED TO BE COMPLETE & FULLY FUNCTIONING. PROVIDE SUCH COMPONENTS AS NECESSARY FOR A FULLY FUNCTIONING SYSTEM.
- PROVIDE SUPPORT FRAMING, STIFFENERS, BRACING, & HANGERS WHETHER SHOWN OR NOT TO ENSURE A COMPLETE & DURABLE SYSTEM. SUPPORT FRAMING CONNECTIONS SHALL BE WELDED UNLESS SPECIFICALLY SHOWN OTHERWISE. ACTUAL SUPPORTS MAY VARY FROM THOSE SHOWN IN DETAILS OR FOR EXISTING FIELD CONDITIONS.





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MASTER CONTROL PANEL 1-A

<u>GENERAL SHEET NOTES:</u> 1. REFER TO DRAWING E-ØØI FOR ELECTRICAL GENERAL NOT 2. REFER TO DRAWING E-6ØI FOR ADDITIONAL INFORMATION.

GENERAL NOTES.
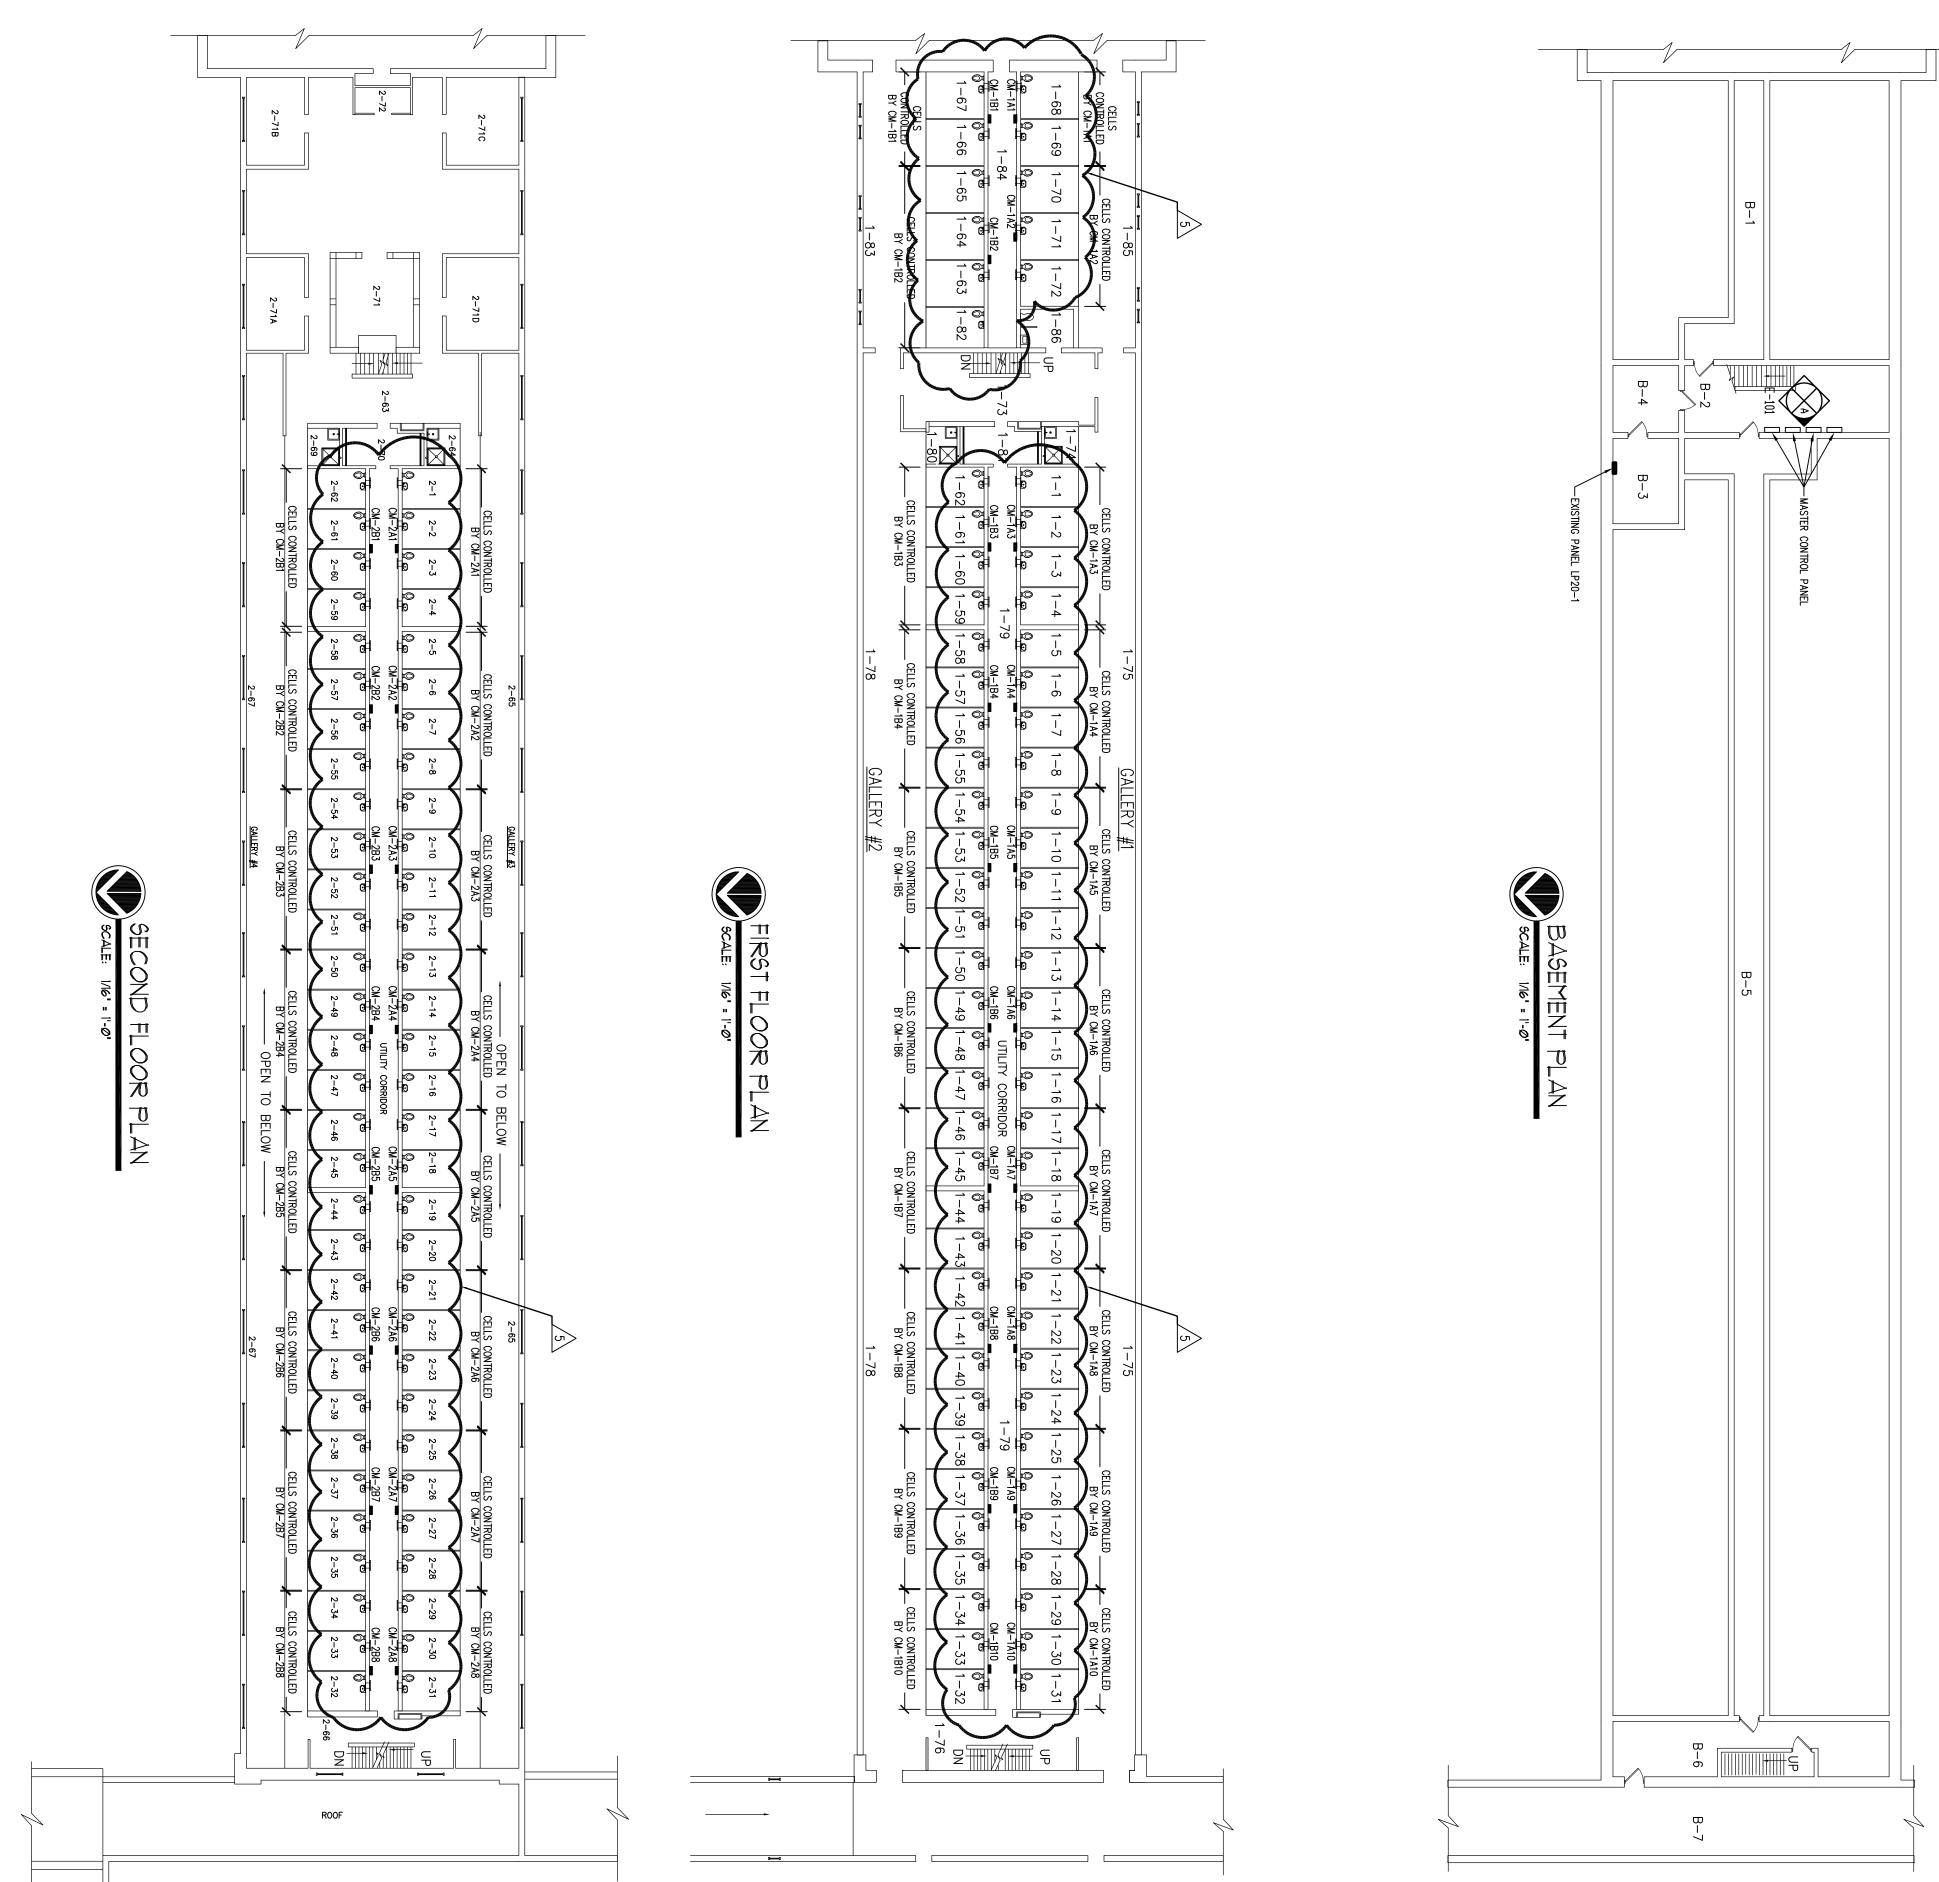
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MASTER CONTROL PANEL 1-B

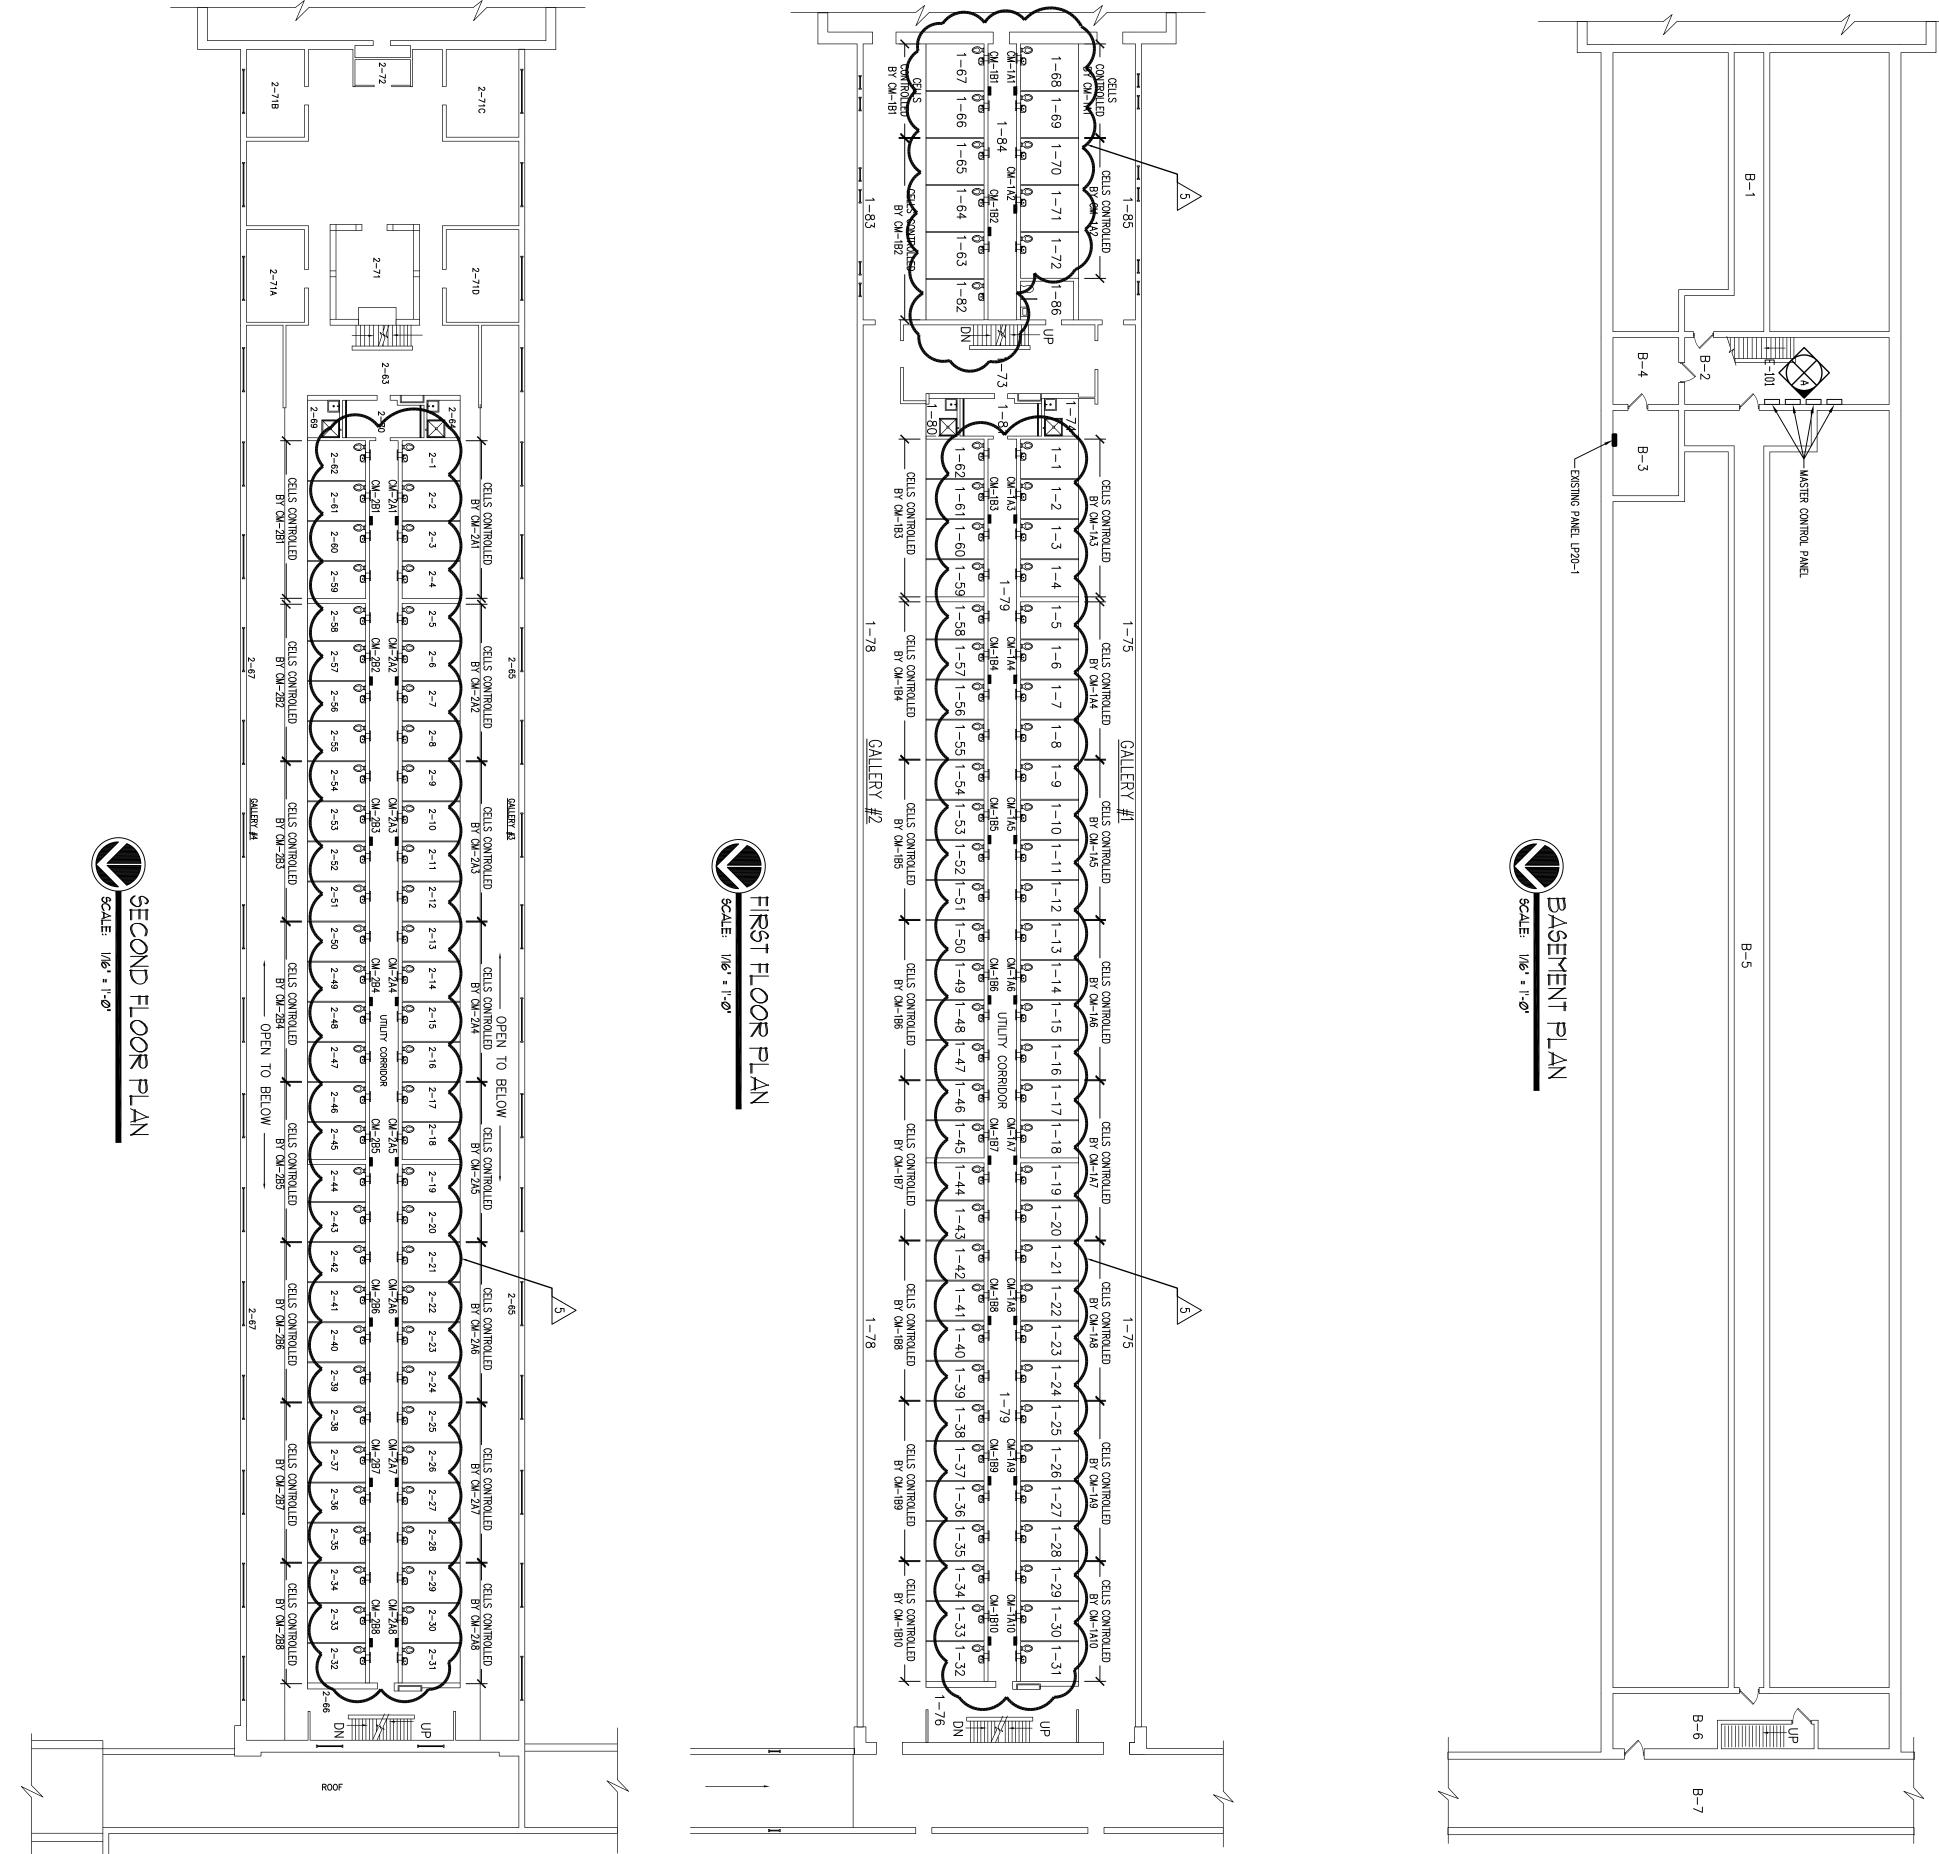MASTER CONTROL PANEL 2-A MASTER CONTROL PANEL 2-B

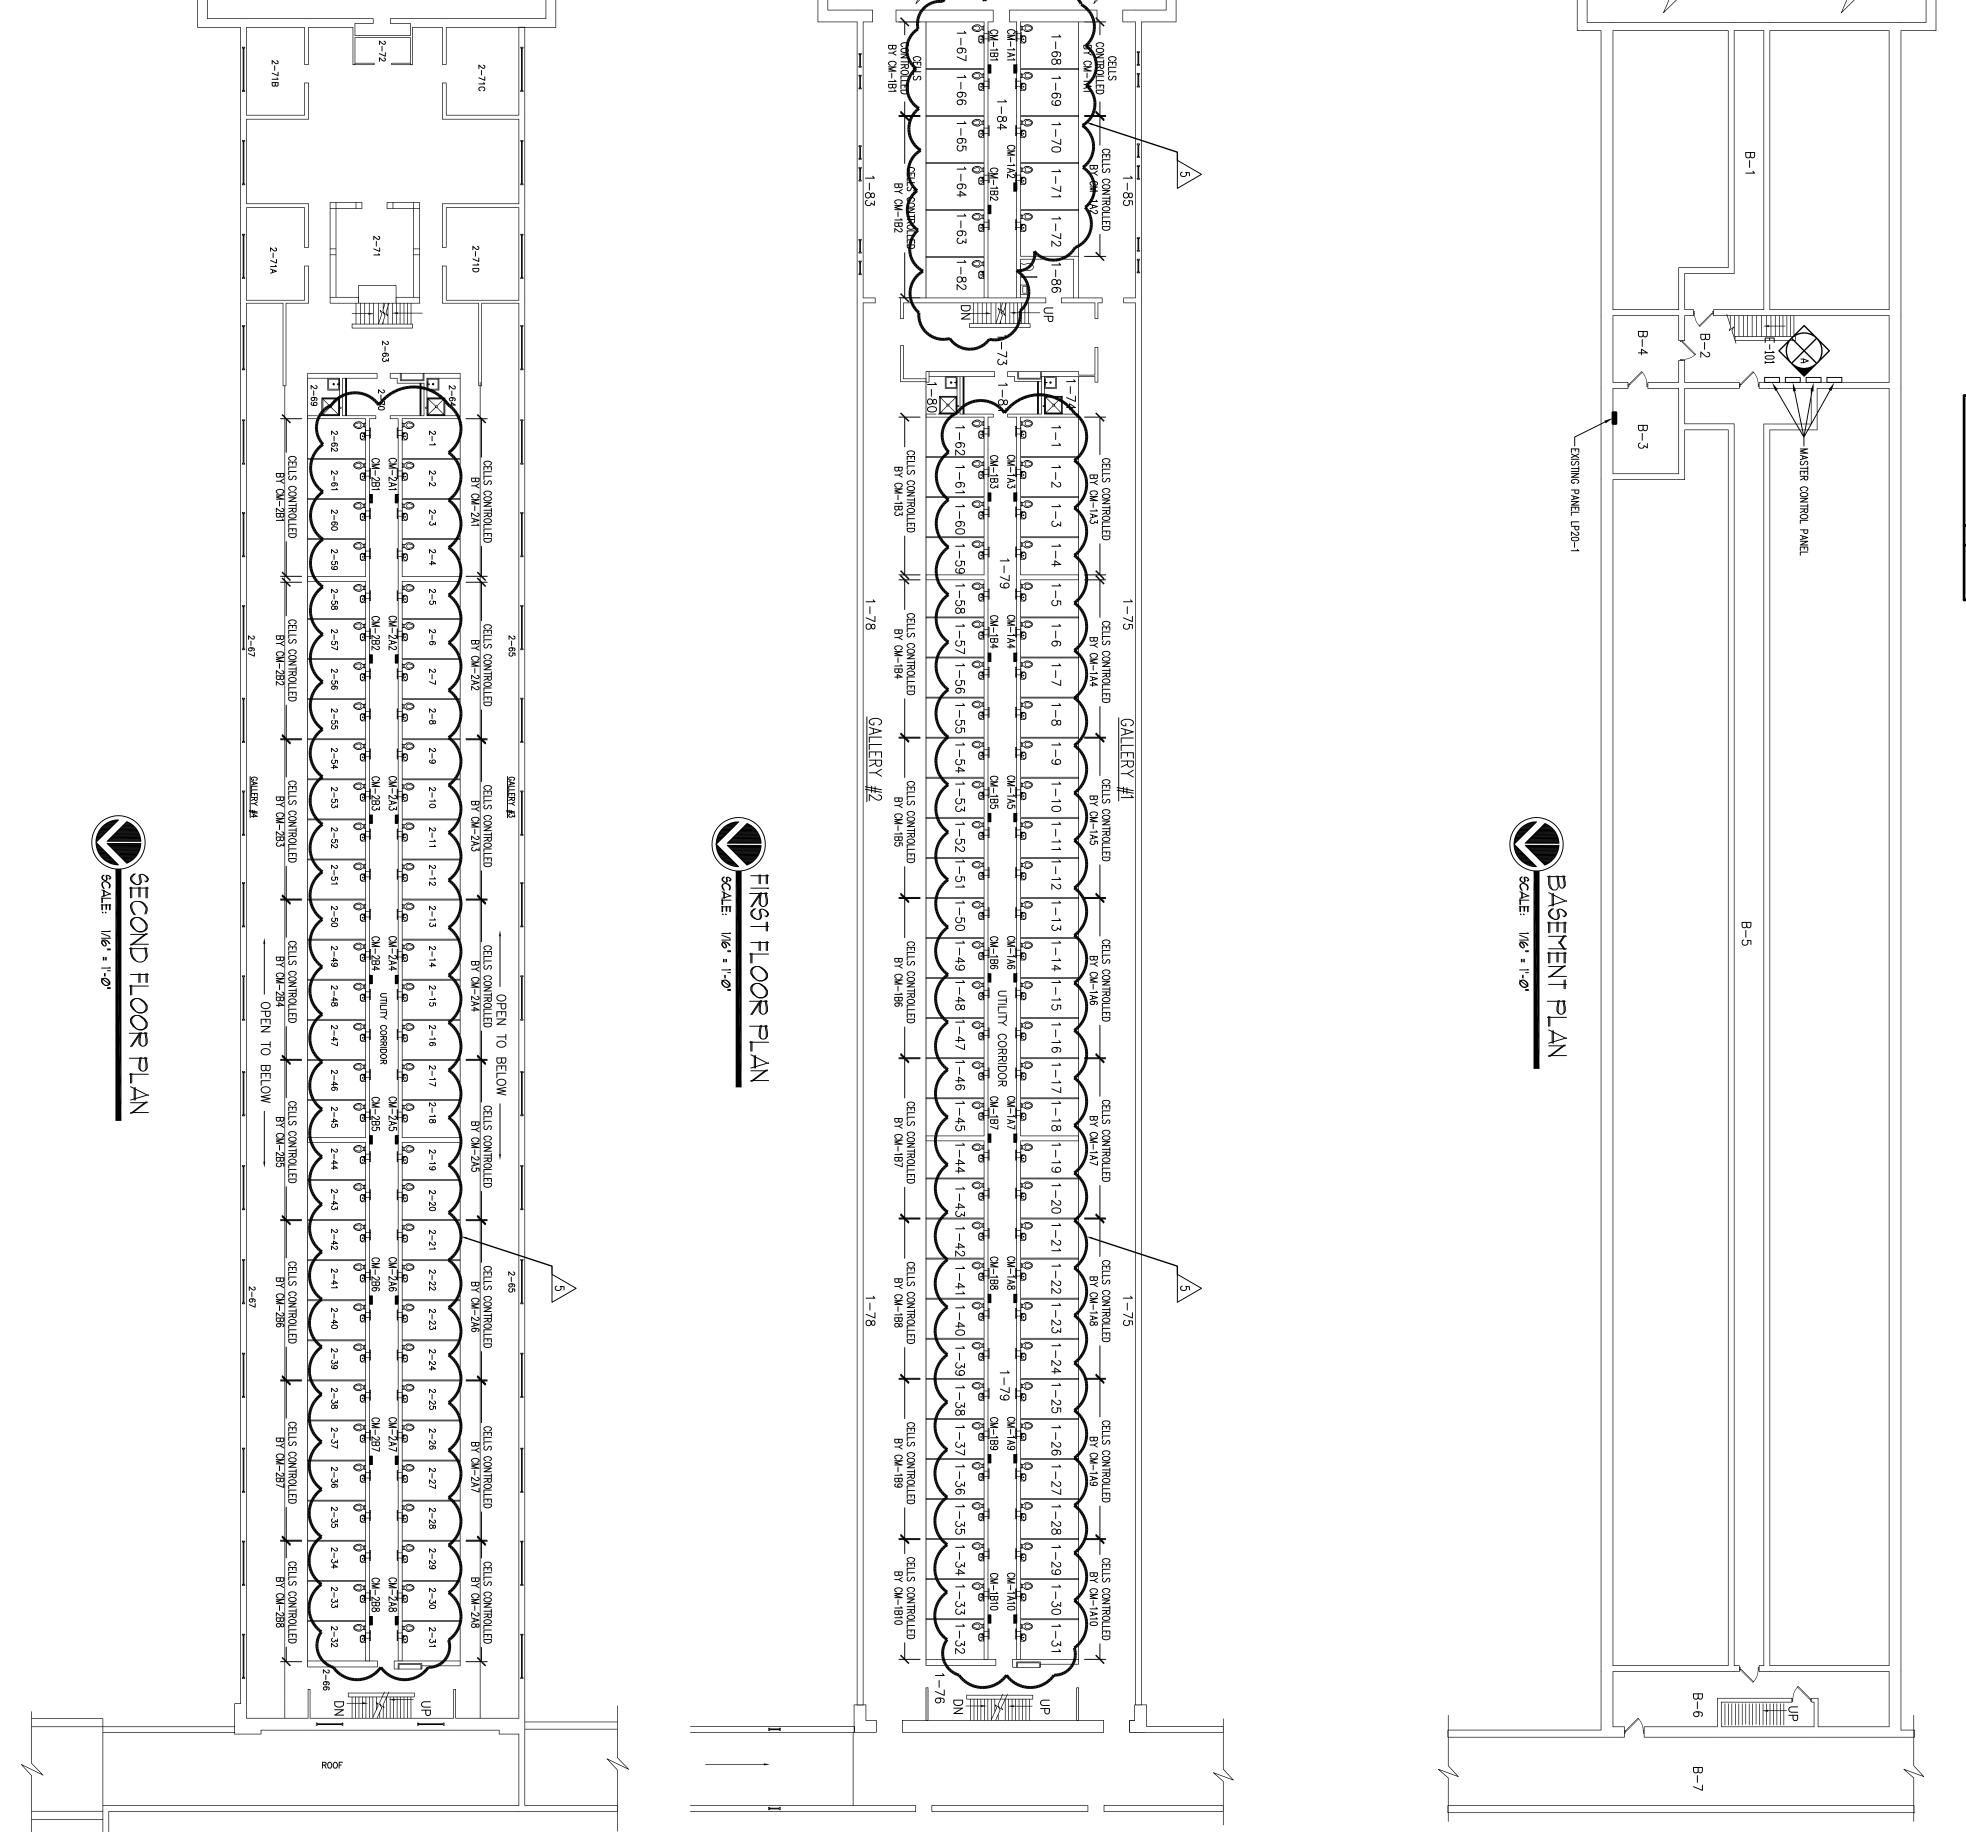MASTER CONTROL PANEL 3-A MASTER CONTROL PANEL 3-B

MASTER CONTROL PANEL 4-A MASTER CONTROL PANEL 4-B

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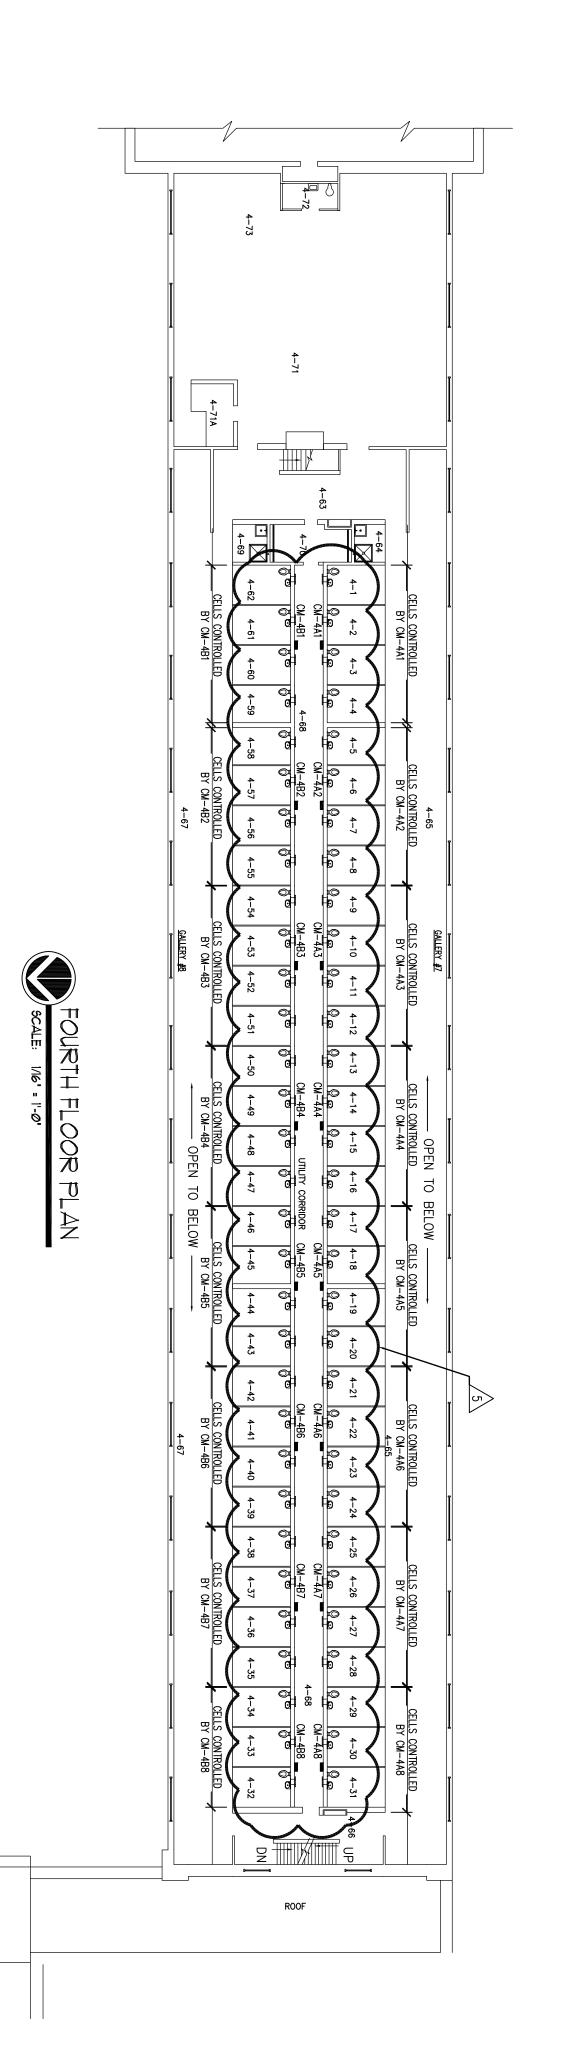
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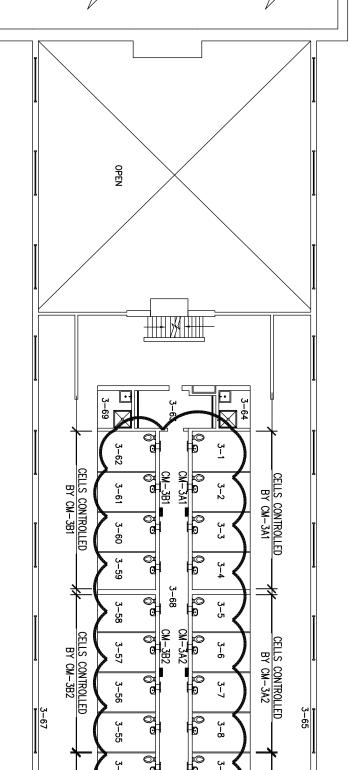
ELMIRA CORRECTIONAL FACILITY

TITLE:

ELECTRICAL

REPLACE PLUMBING C BLOCK, BUILDING 20





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<u>General Sheet Notes:</u> 1. Refer to drawing E-001 for electrical general notes 2. Refer to drawing E-601 for additional information.