



**DESIGN AND CONSTRUCTION GROUP
THE GOVERNOR NELSON A. ROCKEFELLER
EMPIRE STATE PLAZA
ALBANY, NY 12242**

ADDENDUM NO. 2 TO PROJECT NO. 44943

**CONSTRUCTION WORK, HVAC WORK, & ELECTRICAL WORK
Replace Roof, Buildings 8, 11, 12 and 14
Wyoming Correctional Facility
3203 Dunbar Road
Attica, NY 14011-0501**

November 12, 2015

NOTE: This Addendum forms a part of the Contract Documents. Insert it in the Project Manual. Acknowledge receipt of this Addendum in the space provided on the Bid Form.

HVAC WORK DRAWINGS

1. Revised Drawings:
 - a. Drawing Nos. M-100, M-101, M-102 and M-103, noted "REVISION NO. 1 dated 11/10/2015" accompanies this Addendum and supersedes the same numbered originally Issued drawings.

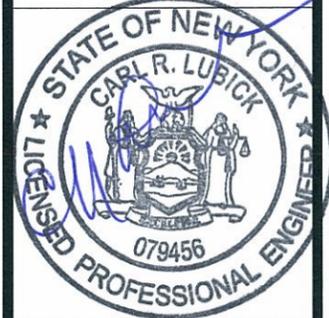
END OF ADDENDUM

Margaret F. Larkin
Executive Director
Design and Construction

CONSULTANT



Wendel VMD Architecture, Engineering, Surveying and Landscape Architecture P.C.



WARNING:

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CONTRACT:

HVAC

TITLE: REPLACE ROOFS, BUILDINGS 8,11,12 & 14

LOCATION: WYOMING COUNTY CORRECTIONAL FACILITY 3203 DUNBAR ROAD, ATTICA, NEW YORK

CLIENT: DEPARTMENT OF CORRECTIONS AND COMMUNITY SUPERVISION

11/10/2015 ADDENDUM 2
04/28/2015 BID DOCUMENTS

PROJECT NUMBER: **44943 - H**

DESIGNED BY: TIP

DRAWN BY: TIP

FIELD CHECK: -

APPROVED:

SHEET TITLE:

**BUILDING 8
HVAC ROOF PLAN
AND NOTES**

DRAWING NUMBER:

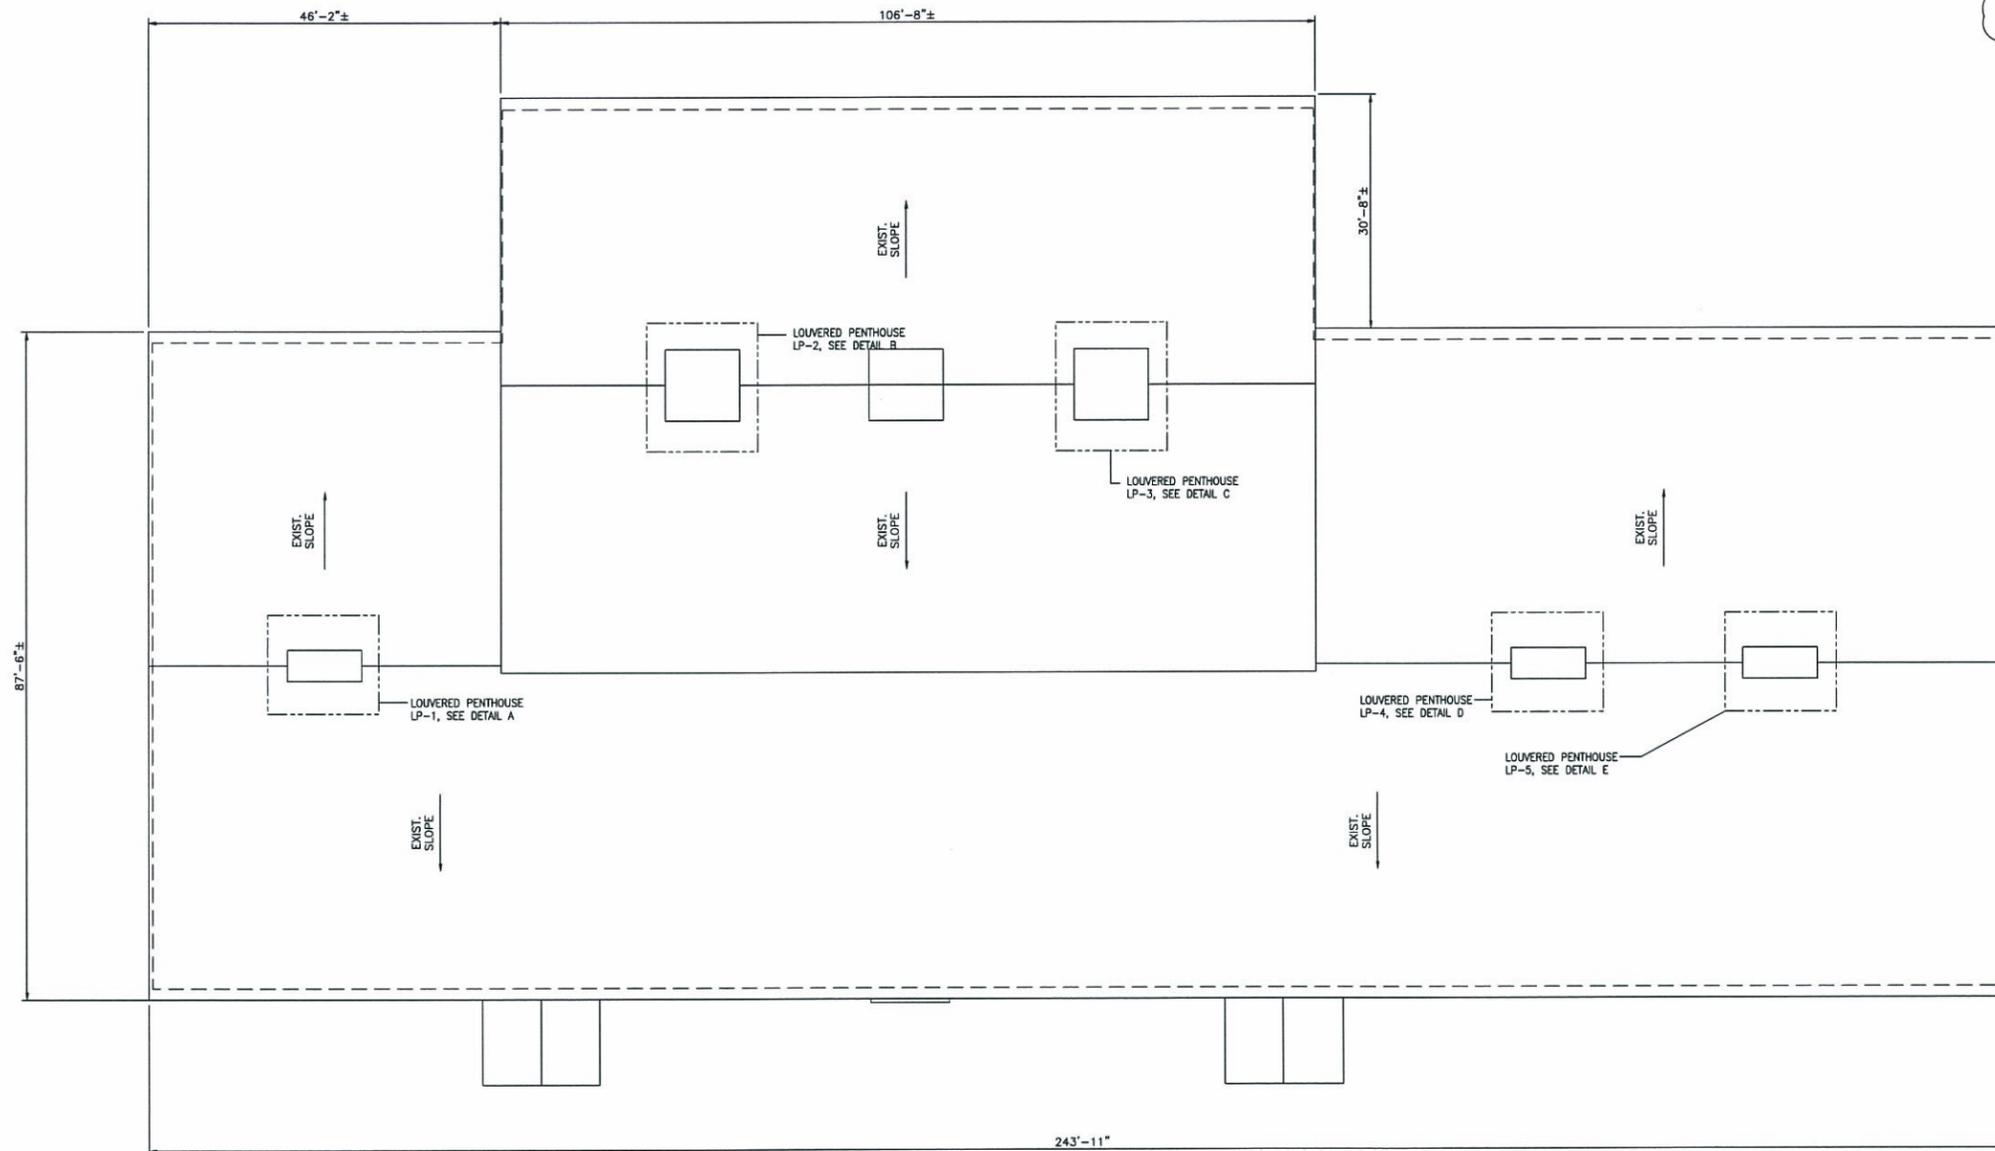
M-100

PIPE INSULATION NOTES:


1. INSULATE ALL QUANTITIES OF PIPING AND PIPE FITTINGS IN NOTES A-J. NOTIFY DIRECTOR'S REPRESENTATIVE FOR FURTHER DIRECTION ON QUANTITIES EXCEEDING THOSE NOTED. QUANTITIES EXCEEDING THOSE IN NOTES A-J ARE NOT INCLUDED IN THE CONTRACT.
2. PROVIDE ALL LABOR AND MATERIALS IN PROJECT BID FOR THE FOLLOWING PIPE INSULATION QUANTITY:
 - A. 50 FEET 1/2" DIAMETER, 1/2" THICK DOMESTIC COLD WATER PIPE INSULATION AND 5 FITTINGS.
 - B. 50 FEET 3/4" DIAMETER, 1/2" THICK DOMESTIC COLD WATER PIPE INSULATION AND 5 FITTINGS.
 - C. 50 FEET 1" DIAMETER, 1/2" THICK DOMESTIC COLD WATER PIPE INSULATION AND 5 FITTINGS.
 - D. 50 FEET 1/2" DIAMETER, 1" THICK DOMESTIC HOT WATER PIPE INSULATION AND 5 FITTINGS.
 - E. 50 FEET 3/4" DIAMETER, 1" THICK DOMESTIC HOT WATER PIPE INSULATION AND 5 FITTINGS.
 - F. 50 FEET 1" DIAMETER, 1" THICK DOMESTIC HOT WATER PIPE INSULATION AND 5 FITTINGS.
 - G. 100 FEET 3/4" DIAMETER, 2" THICK HEATING HOT WATER PIPE INSULATION AND 10 FITTINGS.
 - H. 100 FEET 1" DIAMETER, 2" THICK HEATING HOT WATER PIPE INSULATION AND 10 FITTINGS.
 - I. 100 FEET 1 1/4" DIAMETER, 2" THICK HEATING HOT WATER PIPE INSULATION AND 10 FITTINGS.
 - J. 100 FEET 1 1/2" DIAMETER, 2" THICK HEATING HOT WATER PIPE INSULATION AND 10 FITTINGS.

GENERAL NOTES:


1. COORDINATE WITH THE CONSTRUCTION CONTRACTOR WHEN THE ROOF REMOVAL AND BUILDING INSULATION WORK IS BEING PERFORMED. ROOF ACCESS OPENINGS WILL BE PROVIDED FOR EASE OF TRANSFERRING MATERIALS WITHIN THE ATTIC SPACE.
2. REMOVE BUILDING FIBERGLASS BATT INSULATION WITHIN THE CEILING JOISTS AS REQUIRED TO ACCESS PIPING FOR INSULATION INSTALLATION. AFTER PIPE INSULATION IS COMPLETE REINSTALL BUILDING INSULATION.
3. EXTEND EXISTING DUCTWORK UP INTO THE LOUVERED PENTHOUSE TO 8" BELOW THE UNDERSIDE OF THE LOUVERED PENTHOUSE. SEE DETAILS ON DRAWING M104.
4. VERIFY LOCATION OF DUCT RISERS AFTER REMOVAL OF EXISTING PENTHOUSE AND OFFSET DUCT RISERS AS REQUIRED TO RISE UP WITHIN PROPOSED PENTHOUSE LOCATIONS.
5. EXISTING ATTIC IS OPEN WOOD TRUSSES WITH FIBERGLASS BATT INSULATION LAYING BETWEEN CEILING JOISTS. ATTIC CAN BE ACCESSED THROUGH CEILING ACCESS PANELS AND PLUMBING CHASES. THERE ARE NO EXISTING WALKWAYS PROVIDED IN THE ATTIC.



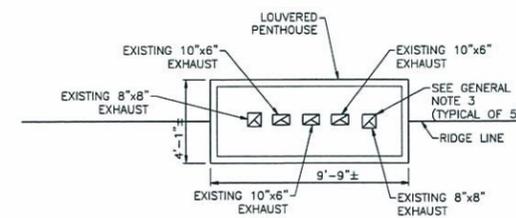
1 BUILDING 8 - ROOF PLAN
SCALE: 3/32" = 1'-0"




E DETAIL E
SCALE: 1/4" = 1'-0"

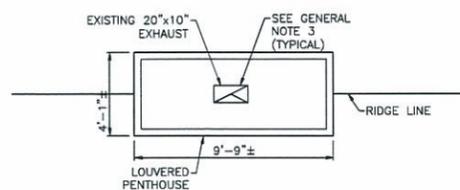


A DETAIL A
SCALE: 1/4" = 1'-0"

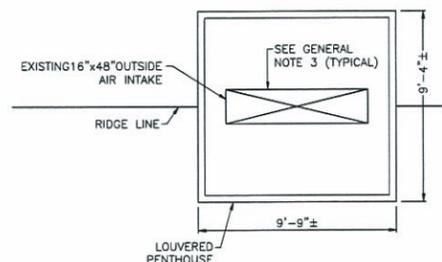


B DETAIL B
SCALE: 1/4" = 1'-0"

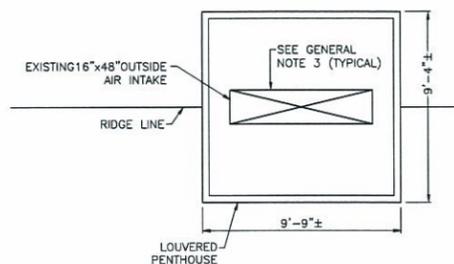

C DETAIL C
SCALE: 1/4" = 1'-0"

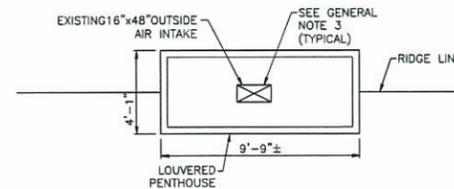

D DETAIL D
SCALE: 1/4" = 1'-0"

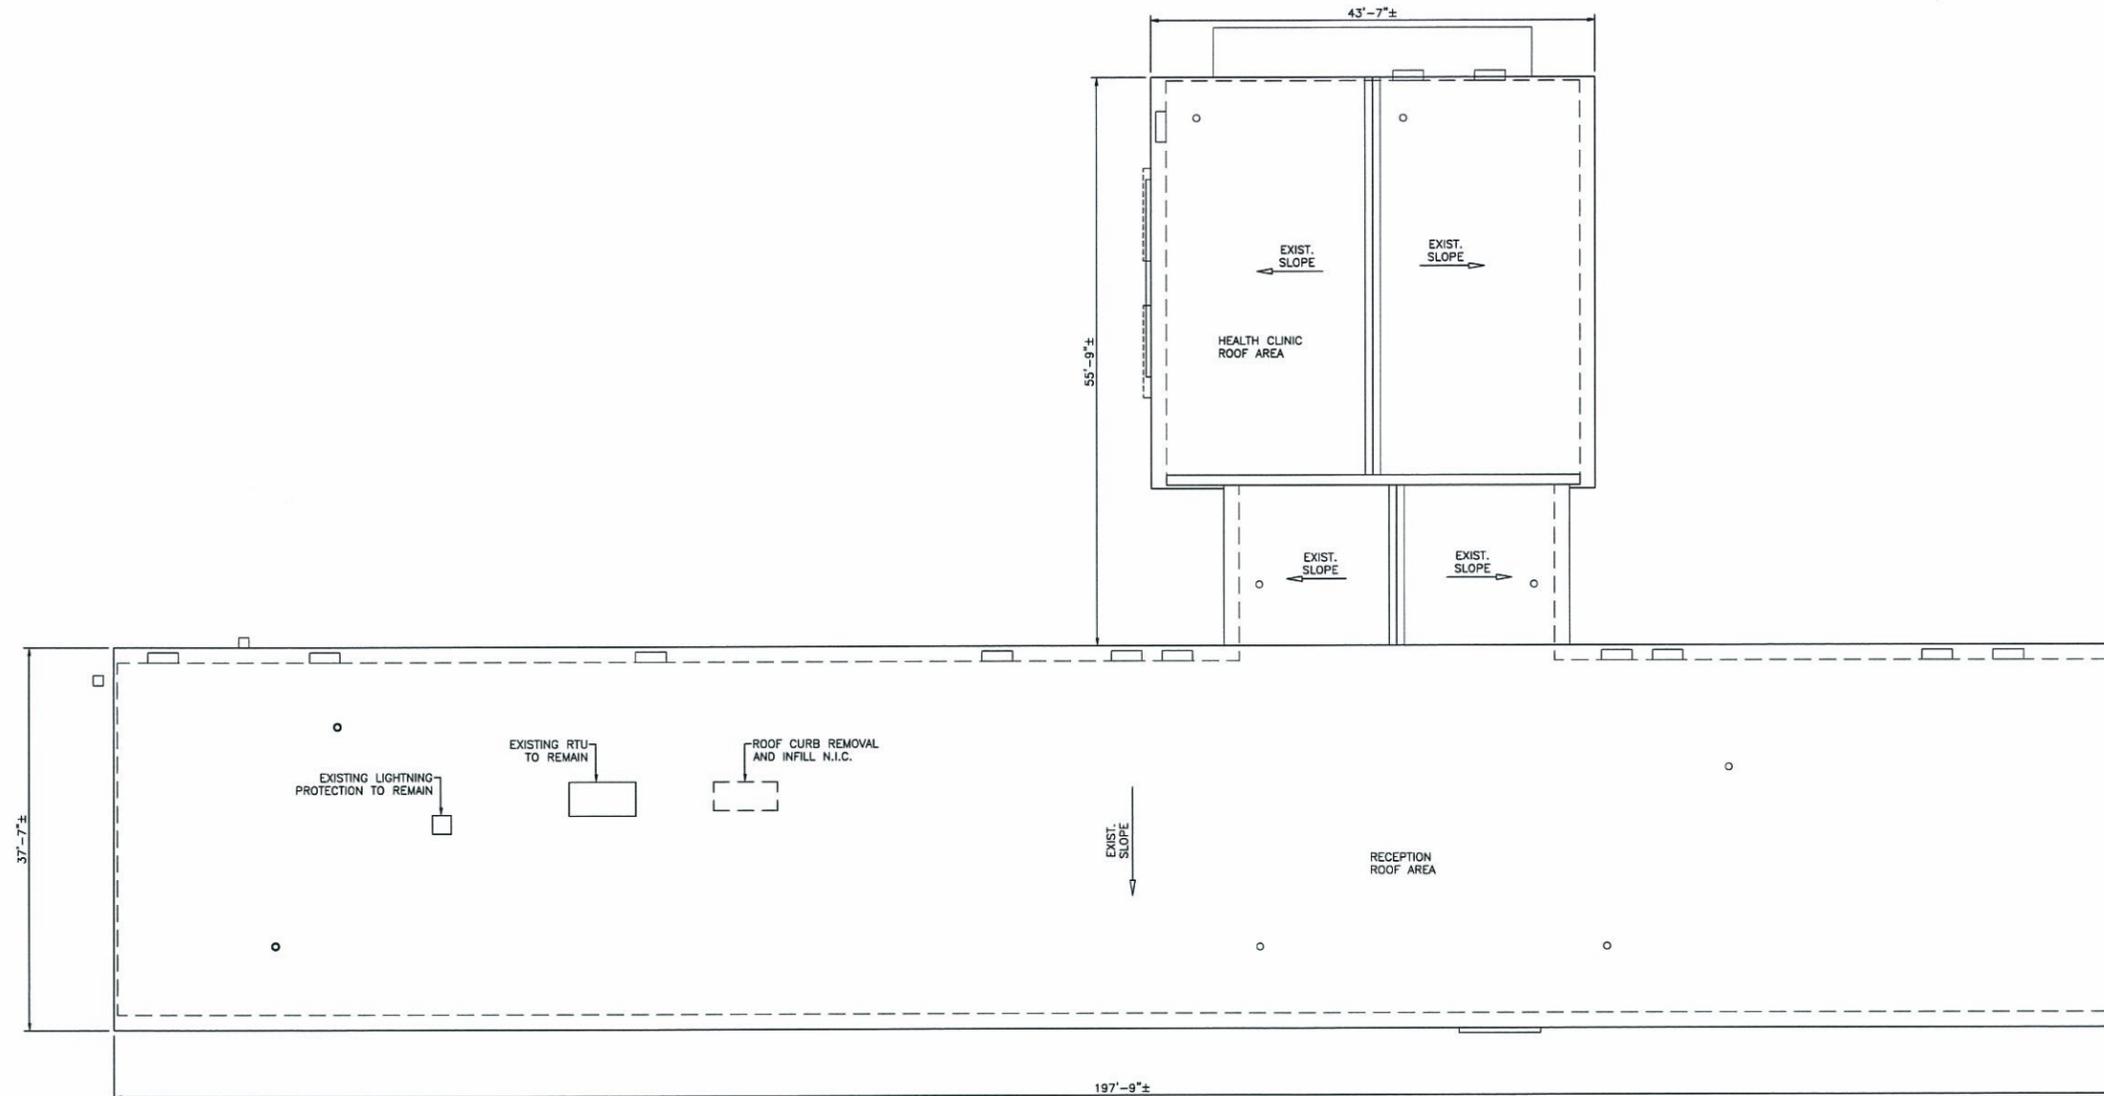

1 BUILDING 11 - ROOF PLAN
SCALE: 1/8"=1'-0"

PIPE INSULATION NOTES:

1. INSULATE ALL QUANTITIES OF PIPING AND PIPE FITTINGS IN NOTES A-J. NOTIFY DIRECTOR'S REPRESENTATIVE FOR FURTHER DIRECTION ON QUANTITIES EXCEEDING THOSE NOTED. QUANTITIES EXCEEDING THOSE IN NOTES A-J ARE NOT INCLUDED IN THE CONTRACT.
2. PROVIDE ALL LABOR AND MATERIALS IN PROJECT BID FOR THE FOLLOWING PIPE INSULATION QUANTITY:
 - A. 25 FEET 1/2" DIAMETER, 1/2" THICK DOMESTIC COLD WATER PIPE INSULATION AND 5 FITTINGS.
 - B. 25 FEET 3/4" DIAMETER, 1/2" THICK DOMESTIC COLD WATER PIPE INSULATION AND 5 FITTINGS.
 - C. 25 FEET 1" DIAMETER, 1/2" THICK DOMESTIC COLD WATER PIPE INSULATION AND 5 FITTINGS.
 - D. 25 FEET 1/2" DIAMETER, 1" THICK DOMESTIC HOT WATER PIPE INSULATION AND 5 FITTINGS.
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 - F. 25 FEET 1" DIAMETER, 1" THICK DOMESTIC HOT WATER PIPE INSULATION AND 5 FITTINGS.
 - G. 50 FEET 3/4" DIAMETER, 2" THICK HEATING HOT WATER PIPE INSULATION AND 10 FITTINGS.
 - H. 50 FEET 1" DIAMETER, 2" THICK HEATING HOT WATER PIPE INSULATION AND 10 FITTINGS.
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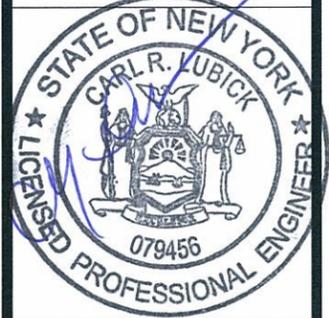
GENERAL NOTES:

1. COORDINATE WITH THE CONSTRUCTION CONTRACTOR WHEN THE ROOF REMOVAL AND BUILDING INSULATION WORK IS BEING PERFORMED. ROOF ACCESS OPENINGS WILL BE PROVIDED FOR EASE OF TRANSFERRING MATERIALS WITHIN THE ATTIC SPACE.
2. REMOVE BUILDING FIBERGLASS BATT INSULATION WITHIN THE CEILING JOISTS AS REQUIRED TO ACCESS PIPING FOR INSULATION INSTALLATION. AFTER PIPE INSULATION IS COMPLETE REINSTALL BUILDING INSULATION.
3. EXISTING ATTIC IS OPEN WOOD TRUSSES WITH FIBERGLASS BATT INSULATION LAYING BETWEEN CEILING JOISTS. ATTIC CAN BE ACCESSED THROUGH CEILING ACCESS PANELS AND PLUMBING CHASES. THERE ARE NO EXISTING WALKWAYS PROVIDED IN THE ATTIC.
4. RECEPTION ROOF AREA CONSISTS OF INSULATION DRAPED OVER STEEL PURLINS ON STEEL JOISTS. NO INSULATION AT CEILING LEVEL. ATTIC CAN BE ACCESSED THROUGH CEILING ACCESS PANELS AND PLUMBING CHASES. THERE ARE NO EXISTING WALKWAYS PROVIDED IN THE ATTIC.

CONSULTANT



Wendel W/D Architecture, Engineering, Surveying and Landscape Architecture P.C.



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CONTRACT: HVAC
TITLE: REPLACE ROOFS, BUILDINGS 8,11,12 & 14
LOCATION: WYOMING COUNTY CORRECTIONAL FACILITY 3203 DUNBAR ROAD, ATTICA, NEW YORK
CLIENT: DEPARTMENT OF CORRECTIONS AND COMMUNITY SUPERVISION

MARK	DATE	DESCRIPTION
1	11/10/2015	ADDENDUM 2
	04/28/2015	BIO DOCUMENTS
PROJECT NUMBER: 44943 - H		
DESIGNED BY:	TIP	
DRAWN BY:	TIP	
FIELD CHECK:	-	
APPROVED:		
SHEET TITLE: BUILDING 11 HVAC ROOF PLAN AND NOTES		
DRAWING NUMBER: M-101		
SHEET 27 OF 36		

CONSULTANT



Wendel W/D Architecture, Engineering, Surveying and Landscape Architecture P.C.



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CONTRACT:

HVAC

TITLE:
REPLACE ROOFS,
BUILDINGS 8,11,12 & 14


LOCATION:
WYOMING COUNTY CORRECTIONAL FACILITY
3203 DUNBAR ROAD,
ATTICA, NEW YORK

CLIENT:
DEPARTMENT OF CORRECTIONS
AND COMMUNITY SUPERVISION

	11/10/2015	ADDENDUM 2
	04/28/2015	BID DOCUMENTS
MARK	DATE	DESCRIPTION
PROJECT NUMBER:	44943 - H	
DESIGNED BY:	TIP	
DRAWN BY:	TIP	
FIELD CHECK:	-	
APPROVED:		

SHEET TITLE:
BUILDING 12
HVAC ROOF PLAN
AND NOTES

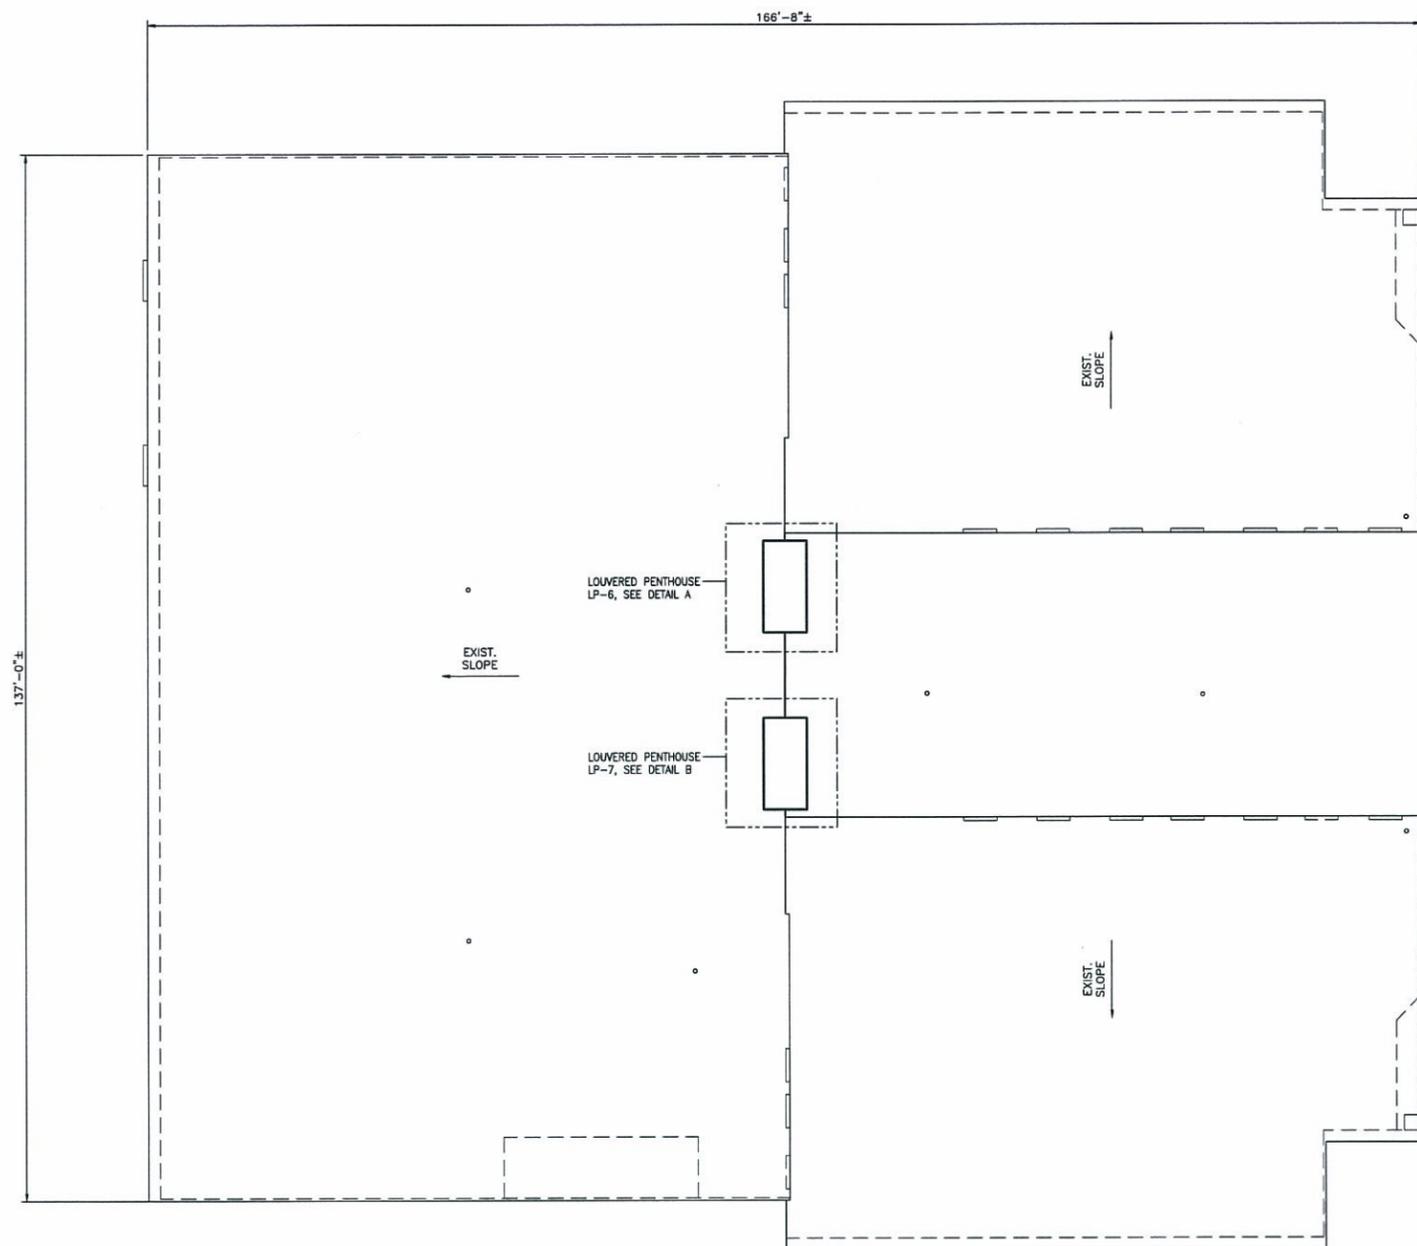DRAWING NUMBER:
M-102



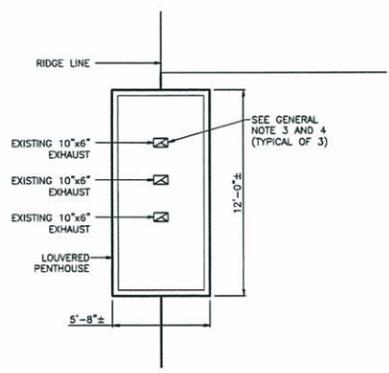
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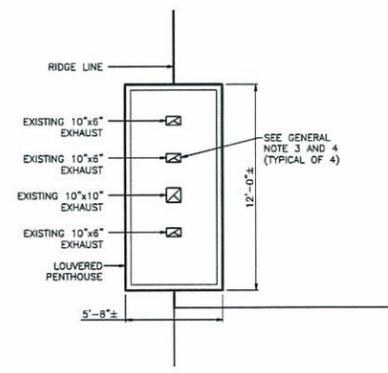
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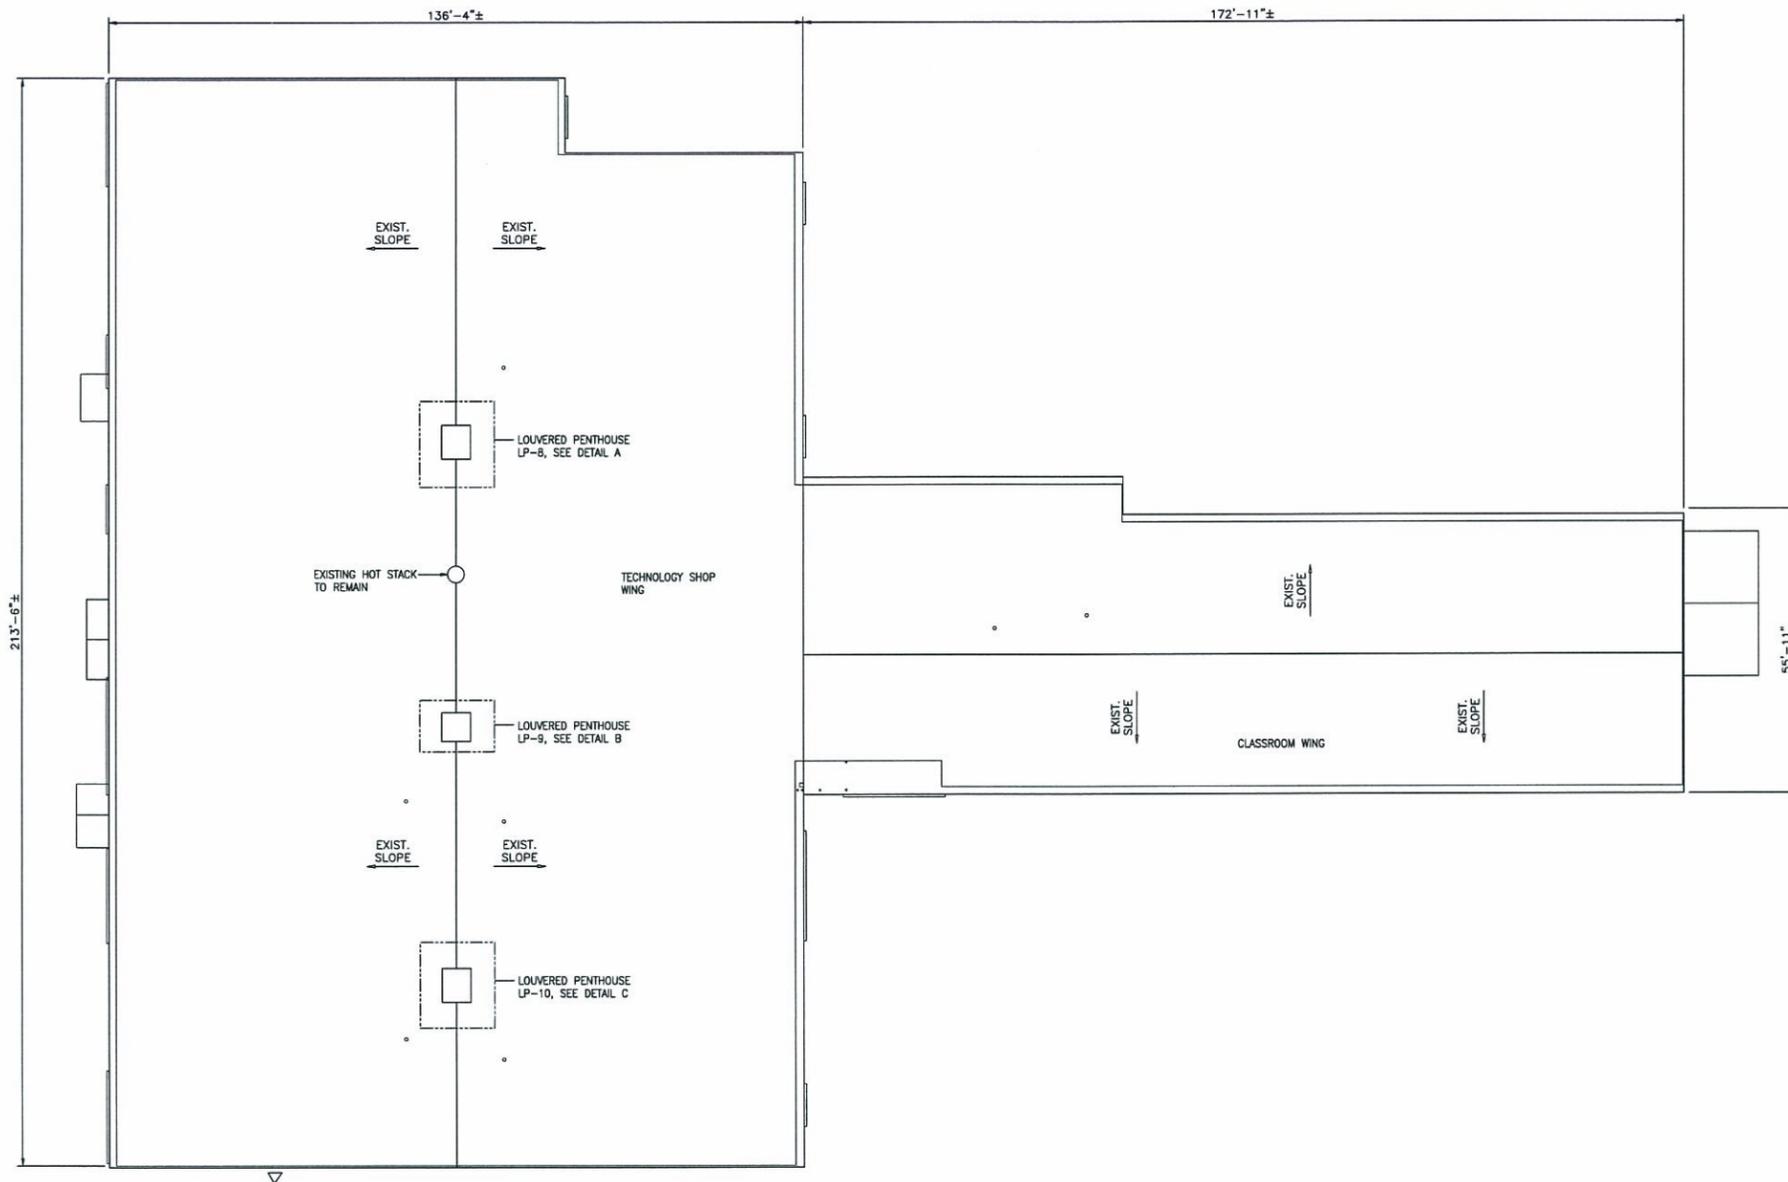
1 BUILDING 12 - ROOF PLAN
SCALE: 3/32" = 1'-0"




A DETAIL A
SCALE: 1/4" = 1'-0"




B DETAIL B
SCALE: 1/4" = 1'-0"



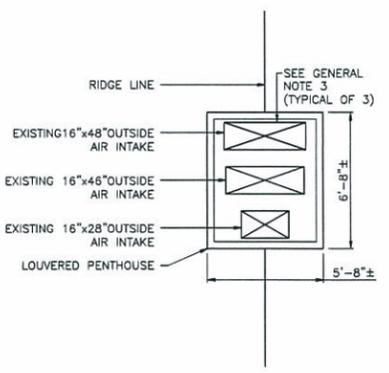
1 BUILDING 14 - ROOF PLAN
SCALE: 1/16"=1'-0"



A DETAIL A
SCALE: 1/4"=1'-0"

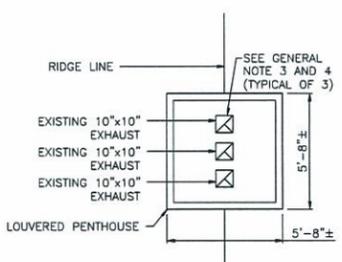

B DETAIL B
SCALE: 1/4"=1'-0"

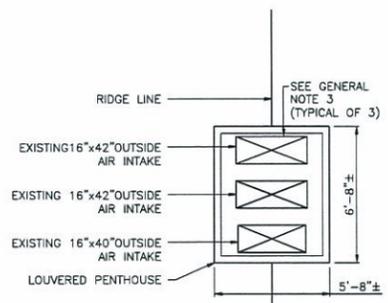


C DETAIL C
SCALE: 1/4"=1'-0"

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CONTRACT: **HVAC**

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LOCATION: **WYOMING COUNTY CORRECTIONAL FACILITY 3203 DUNBAR ROAD, ATTICA, NEW YORK**

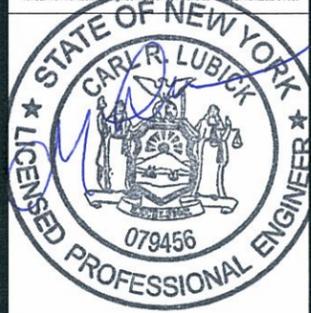CLIENT: **DEPARTMENT OF CORRECTIONS AND COMMUNITY SUPERVISION**

MARK	DATE	DESCRIPTION
△	11/10/2015	ADDENDUM 2
	04/28/2015	BID DOCUMENTS
PROJECT NUMBER: 44943 - H		
DESIGNED BY: TIP		
DRAWN BY: TIP		
FIELD CHECK: -		
APPROVED:		
SHEET TITLE: BUILDING 14 HVAC ROOF PLAN AND NOTES		
DRAWING NUMBER: M-103		
SHEET 29 OF 36		