

#### DESIGN AND CONSTRUCTION GROUP THE GOVERNOR NELSON A. ROCKEFELLER EMPIRE STATE PLAZA ALBANY, NY 12242

#### ADDENDUM NO. 1 TO PROJECT NO. 44975

#### CONSTRUCTION, PLUMBING AND ELECTRICAL WORK REHABILITATE KITCHEN BUILDING No. 12 GOUVERNEUR CORRECTIONAL FACILITY SCOTCH SETTLEMENT ROAD GOUVERNEUR, NY

February 17, 2016

**NOTE:** This Addendum forms a part of the Contract Documents. Insert it in the Project Manual. Acknowledge receipt of this Addendum in the space provided on the Bid Form.

#### **COMMON DIVISION 1 SECTIONS**

1. Page 015000-6, PART 1 GENERAL: Add the following Article:

#### "1.14 - LOCKABLE STORAGE CONTAINERS

- A. Contractor is to provide secure storage for items to be removed, stored and reinstalled as identified on Drawings. Contractor shall remove, store and protect items as required to prevent any damage to them. Lockable storage containers can remain on Facility property outside the secure perimeter. Exact location to be determined by the Director's Representative. Refer to Specification Section 017329 for Removals, Cutting and Patching."
- 2. SECTION 033001 CAST-IN-PLACE-CONCRETE: Add the attached Section (pages 033001-1 thru 033001-5) to the Project Manual.
- 3. Page 092531 3, Paragraph 2.01 F.: Delete this Paragraph in its entirety and replace with the following:
  - "F. Fasteners: Stainless steel drill screws, ASTM C 1002; gypsum board manufacturer's recommended for specified gypsum backer board and total composite PRSCB panel."

- 4. Page 114100-5, ARTICLE 2.08 ITEM NO. 8 DISPOSER: Delete this Article in its entirety and replace with the following:
  - "2.08 ITEM NO. 8 DISPOSER
    - A. Manufacturer: Red Goat Disposers, 165 Independence Ct. Lancaster, PA 17601, 1-800-237-6628, www.redgoat.com.
    - B. Model No. C10P-0 / C-C12 / RAC2-10L-EM.
    - C. Features:
      - 1. 10 Hp disposer, 208v/3ph.
      - 2. Disposer Controls, NEMA 4X box with disconnect switch, Automatic Reversing, Start-Stop w/ mounted solenoid valve, flow control and pressure switch, Eco-Mizer, electricity and water saver.
      - 3. 12" Cone assembly, with spray nozzle, welded to the base of Item 32 Scrap Sink.
      - 4. Standard Prison package includes: disposer safety guard security screws w/ tool for service covers and control panel.
      - 5. Control Panel padlock hasp.
    - D. Plumbing Trim
      - 1. Fixed cone nozzle.
      - 2. Vacuum breaker.
      - 3. Solenoid valve.
      - 4. Flow control valve.
    - E. Electrical Trim
      - 1. RAC2-10L-EM control.
- 5. Page 114100-14, Paragraph 2.32 B.: Delete this Paragraph in its entirety and replace with the following:
  - "B. Size 4'-0"x 30" x 36" working height, Configuration per Revised Drawing Nos. Q-106 and Q-502.
- 6. Page 114102-3, Subparagraph 2.01 F.1.: Delete this Subparagraph in its entirety.

#### GENERAL DRAWINGS

7. Drawing Nos. G-001, G-002 and G-003: Clarification: Room 27, Staging Area is the staging area associated with Room 26 General Storage Room and Room 36 Receiving. It is not to be interpreted as a "Contractor Staging Area".

#### CONSTRUCTION WORK DRAWINGS

8. Drawing Nos. A-001, A-101, A-102, A-103, A-104, A-105, A-106, A-107, A-108, A-109, A-110, A-111, A-401, A-501, A-601, and A-602: Clarification: Room 27, Staging Area is the staging area associated with Room 26 General Storage Room and Room 36 Receiving. It is not to be interpreted as a "Contractor Staging Area".

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- 9. Drawing No. A-001, CEILING ASSEMBLIES, BASIC COMPONENTS: Change "1<sup>1</sup>/<sub>2</sub>" Steel Galvanized Channels at 48" O.C." to read "1<sup>1</sup>/<sub>2</sub>" by 15/16" Galvanized Steel Tee at 48" O.C."
- 10. Drawing No. A-106, PHASE 2 SIDE 'B' REMOVALS: Remove approximately 10 sq. ft. of existing concrete floor slab to allow the work of related contracts to be performed. Coordinate exact removal requirements with related contracts through the Director's Representative. When directed, after related contract work is completed, replace concrete floor slab to match existing. See Detail 12/A-501.
- 11. Drawing No. A-602:
  - a. ROOM FINISH SCHEDULE PHASE 2: Columns "FLOOR FINISH" and "BASE" At Room Nos. 6B, 8B, 40 and 44: Change "FB (Floor Brick)" to read "QT (Quarry Tile".
  - b. HARDWARE NOTES, Note 2: Change Note to read the following:
    - "2. Mortise Lockset: 1ea Corbin Russwin x ML2022HS x GSA x SA114 x M17 x M04 x 630".
  - c. HARDWARE NOTES, Note 3: Change Note to read the following:
    - "3. Mortise Lock Cylinder: 2ea Compatible with specified lock above and Facility's existing Corbin Russwin N24 keyway system."
- 12. Revised Drawings:
  - a. Drawing Nos. A-501, Q-106, Q-502, and Q-601, noted "REVISED DRAWINGS 02/17/16" accompany this Addendum and supersede the same numbered originally issued drawings.

#### PLUMBING WORK DRAWINGS

 Drawing Nos. P-001, P-101, P-102, P-103, P-104, F-101, F-102, F-103, and F-104: Clarification: Room 27, Staging Area is the staging area associated with Room 26 General Storage Room and Room 36 Receiving. It is not to be interpreted as a "Contractor Staging Area".

#### ELECTRICAL WORK DRAWINGS

- Drawing Nos. E-001, E-101, E-102, E-103, E-104, E-105, E-106, E-107, F-108, E-500, and E-600: Clarification: Room 27, Staging Area is the staging area associated with Room 26 General Storage Room and Room 36 Receiving. It is not to be interpreted as a "Contractor Staging Area".
- 15. Revised Drawings:
  - a. Drawing Nos. E-104, E-108, and E-600, noted "REVISED DRAWINGS 02/17/16" accompany this Addendum and supersede the same numbered originally issued drawings.

#### **END OF ADDENDUM**

Margaret F. Larkin Executive Director Design and Construction

JRC:jc

#### **SECTION 033001**

#### CAST-IN-PLACE CONCRETE

#### PART 1 GENERAL

#### **1.01 REFERENCES**

 Except as shown or specified otherwise, the Work of this Section shall conform to the requirements of Specifications for Structural Concrete for Buildings ACI 301-05 of the American Concrete Institute.

#### **1.02 DEFINITIONS (Amendments to ACI 301, Section 1.2):**

A. Exposed Construction: Exposed to view.

#### **1.03 SUBMITTALS**

- A. Submittals Package: Submit product data for design mix(es) and materials for concrete specified below at the same time as a package.
- B. Shop Drawings: Placing drawings for bar reinforcement.
- C. Product Data:
  - 1. Concrete design mix(es) with name and location of batching plant.
  - 2. Portland Cement: Brand and manufacturer's name.
  - 3. Fly Ash: Name and location of source, and DOT test numbers.
  - 4. Air-entraining Admixture: Brand and manufacturer's name.
  - 5. Water-reducing Admixture: Brand and manufacturer's name.
  - 6. Aggregates: Name and location of source, and DOT test numbers.
  - 7. Lightweight Coarse Aggregate: Brand and manufacturer's name
  - 8. Chemical Hardener (Dustproofing): Brand and manufacturer's name, and application instructions.
  - 9. Bonding Agent (Adhesive): Brand and manufacturer's name, and preparation and application instructions.
  - 10. Expansion Joint Filler: Brand and manufacturer's name.
  - 11. Emery Aggregate: Brand and manufacturer's name, and application instructions.
- D. Quality Control Submittals:
  - 1. Certificates: Affidavit required under Quality Assurance Article.

#### 1.04 QUALITY ASSURANCE

- A. Concrete batching plant shall be currently approved as a concrete supplier by the New York State Department of Transportation.
- B. Fly ash supplier shall be currently approved as a fly ash supplier by the New York State Department of Transportation.

- C. Certifications: Affidavit by the bar reinforcement manufacturer certifying that bar material meets the contract requirements.
- D. Source Quality Control: The Director reserves the right to inspect and approve the following items, at his own discretion, either with his own forces or with a designated inspection agency:
  - 1. Batching and mixing facilities and equipment.
  - 2. Sources of materials.

#### 1.05 STORAGE

A. Store materials so as to insure the preservation of their quality and fitness for the Work. Materials, even though accepted prior to storage, are subject to inspection and shall meet the requirements of the Contract before their use in the Work.

#### PART 2 PRODUCTS

## 2.01 MATERIALS (Amendments to ACI 301, Section 4, for Normal Weight Concrete and Section 7, for Lightweight Concrete):

- A. Water-reducing Admixture: ASTM C 494, Type A, and on the New York State Department of Transportation's current "Approved List".
- B. Fly Ash: ASTM C 618, including Table 1A (except for footnote A), Class F except that loss on ignition shall not exceed 4.0 percent.
- C. Chemical Hardener (Dustproofing): Colorless aqueous solution of magnesiumzinc fluosilicate. Approved products include:
  - 1. Lapidolith by Sonneborn/ BASF Building Systems, 889 Valley Park Dr., Shakopee, MN 55379, (800) 433-9517.
  - 2. Surfhard by The Euclid Chemical Co., 19218 Redwood Rd., Cleveland, OH 44110, (216) 531-9222.
  - 3. Pena-Lith by W.R. Meadows, Inc., PO Box 543, Elgin, IL 60121, (847) 683-4500.
  - 4. FluoHard by L & M Construction Chemicals, Inc., 14851 Calhoun Rd., Omaha, NE 68152, (402) 453-6600.
  - 5. Armortop by Anti Hydro International, Inc., 265 Badger Ave., Newark, NJ 07108, (800) 777-1773.
  - 6. Diamond by Kaufman Products, Inc., 3811 Curtis Avenue, Baltimore, MD 21226, (800) 637-6372.

#### 2.02 **PROPORTIONING (Amendments to ACI 301, Sections 4 & 7):**

- A. Compressive Strength: Minimum 3000 psi.
- B. Weight: Normal.

- C. Durability: Concrete shall be air-entrained. Design air content shall be 6 percent by volume, with an allowable tolerance of plus or minus 1.5 percent for total air content. Entrained air shall be provided by use of an approved airentraining admixture. Air-entrained cement shall not be used.
- D. Slump:
  - 1. 3000 psi Normal Weight Concrete: Between 2 inches and 4 inches.
- E. Admixtures: Do not use admixtures in concrete unless specified or approved in writing by the Director.
- F. Selection of Proportions: Concrete proportions shall be established on the basis of previous field experience or laboratory trial batches, unless otherwise approved in writing by the Director. Proportion mix with a minimum cement content of 564 pounds per cubic yard for 3000 psi concrete.
  - 1. Optional Material: Fly ash may be substituted for (Portland) cement in normal weight concrete up to a maximum of 15 percent by weight of the required minimum (Portland) cement. If fly ash is incorporated in a concrete design mix, make necessary adjustments to the design mix to compensate for the use of fly ash as a partial replacement for (Portland) cement.
    - a. Adjustments shall include the required increase in air-entraining admixture to provide the specified air content.
    - b. Lower early strength of the concrete shall be considered in deciding when to remove formwork.

#### 2.03 **REINFORCEMENT** (Amendments to ACI 301, Section 3):

- A. Bar Reinforcement: ASTM A 615, Grade 60, deformed steel bars.
- B. Bar Supports: Galvanized steel or AISI Type 430 stainless steel, and without plastic tips.
- C. Tie Wire: Black annealed wire, 16-1/2 gage or heavier.

#### 2.04 JOINTS AND EMBEDDED ITEMS (Amendments to ACI 301, Section 5.3.2.6):

A. Obtain bond at construction joints by the use of bonding agent (adhesive) or the use of cement grout.

#### 2.05 **PRODUCTION (Amendments to ACI 301, Section 5):**

A. Provide ready-mixed concrete, either central-mixed or truck-mixed.

#### PART 3 EXECUTION

#### 3.01 EXAMINATION AND PREPARATION

- A. Do not use items of aluminum for mixing, chuting, conveying, forming or finishing concrete, except magnesium alloy tools may be used for finishing.
- B. Keep excavations free of water. Do not deposit concrete in water.
- C. Hardened concrete, reinforcement, forms, and earth which will be in contact with fresh concrete shall be free from frost at the time of concrete placement.
- D. Prior to placement of concrete, remove all hardened concrete spillage and foreign materials from the space to be occupied by the concrete.

#### **3.02** PLACING REINFORCEMENT (Amendments to ACI 301, Section 3):

A. At the time concrete is placed, reinforcement shall be free of mud, oil, loose rust, loose mill scale, and other materials or coatings that may adversely affect or reduce the bond.

#### **3.03** PLACING CONCRETE (Amendments to ACI 301, Section 5):

- A. Operation of truck mixers and agitators and discharge limitations shall conform to the requirements of ASTM C 94.
- B. Do not allow concrete to free fall more than 4 feet.

#### 3.04 FINISHING SLABS (Amendments to ACI 301, Section 5.3.4):

- A. Slabs On Grade: Provide key type joints unless otherwise shown. Tool exposed joints.
- B. Finish Schedule: Except where indicated otherwise on the Drawings, provide the finishes below:
  - 1. Scratched Finish for:
    - a. Surfaces to be covered with quarry tile set in a bonded thick mortar bed, except screed to a Class B tolerance.
- C. Finishing, General: Provide monolithic finishes on concrete floors and slabs without the addition of mortar or other filler material. Finish surfaces in true planes, true to line, with particular care taken during screeding to maintain an excess of concrete in front of the screed so as to prevent low spots. Screed and darby concrete to true planes while plastic and before free water rises to the surface. Do not perform finishing operations during the time free water (bleeding) is on the surface.

#### 3.05 CURING AND PROTECTION (Amendments to ACI 301, Section 5.3.6):

A. Maintain concrete surfaces in a moist condition for at least 7 days after placing, except where otherwise indicated. Do not use curing compound.


#### **3.06 CHEMICAL HARDENER (DUSTPROOFING)**


- A. Apply chemical hardener to all troweled finished interior floors which are to be left exposed.
- B. Do not apply chemical hardener until concrete has cured the number of days recommended in manufacturer's instructions.
- C. Prepare surfaces and apply chemical hardener in accordance with manufacturer's printed instructions and recommendations.

#### **3.07** FIELD QUALITY CONTROL (Amendments to ACI 301, Section 1):

A. Make available to the Director's Representatives whatever test samples are required to make tests. Furnish shipping boxes for compression test cylinders.

#### **END OF SECTION**

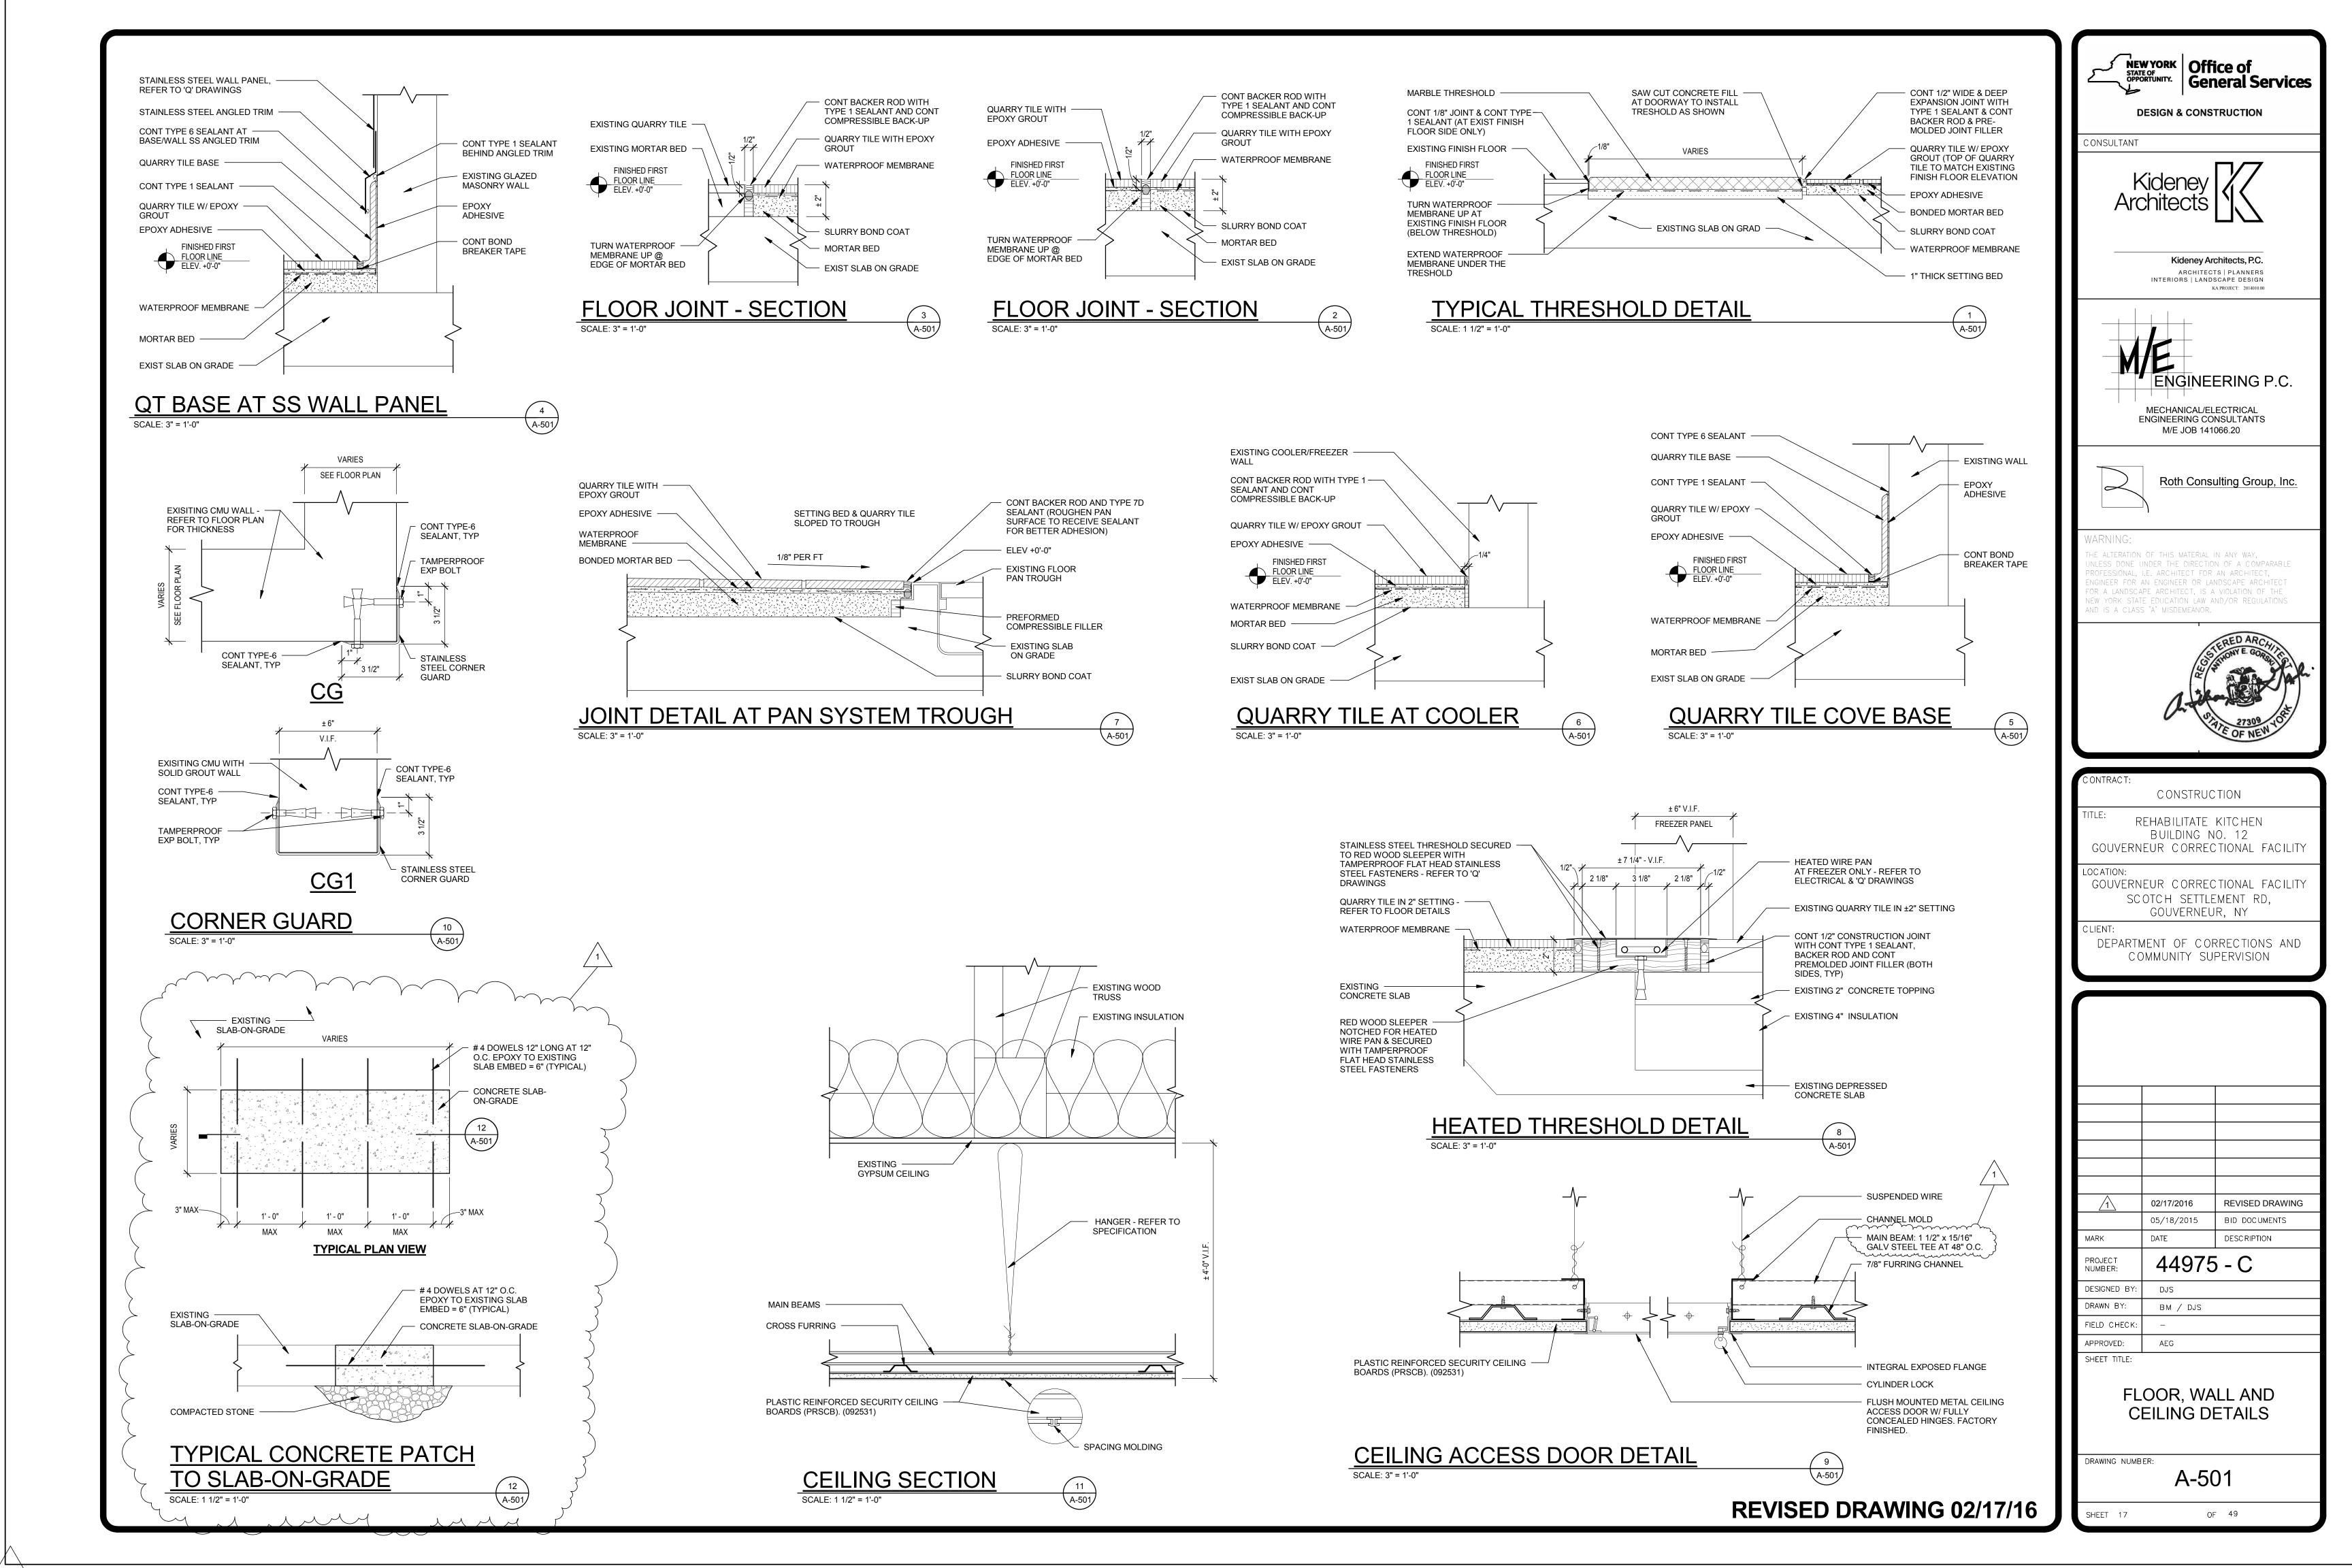

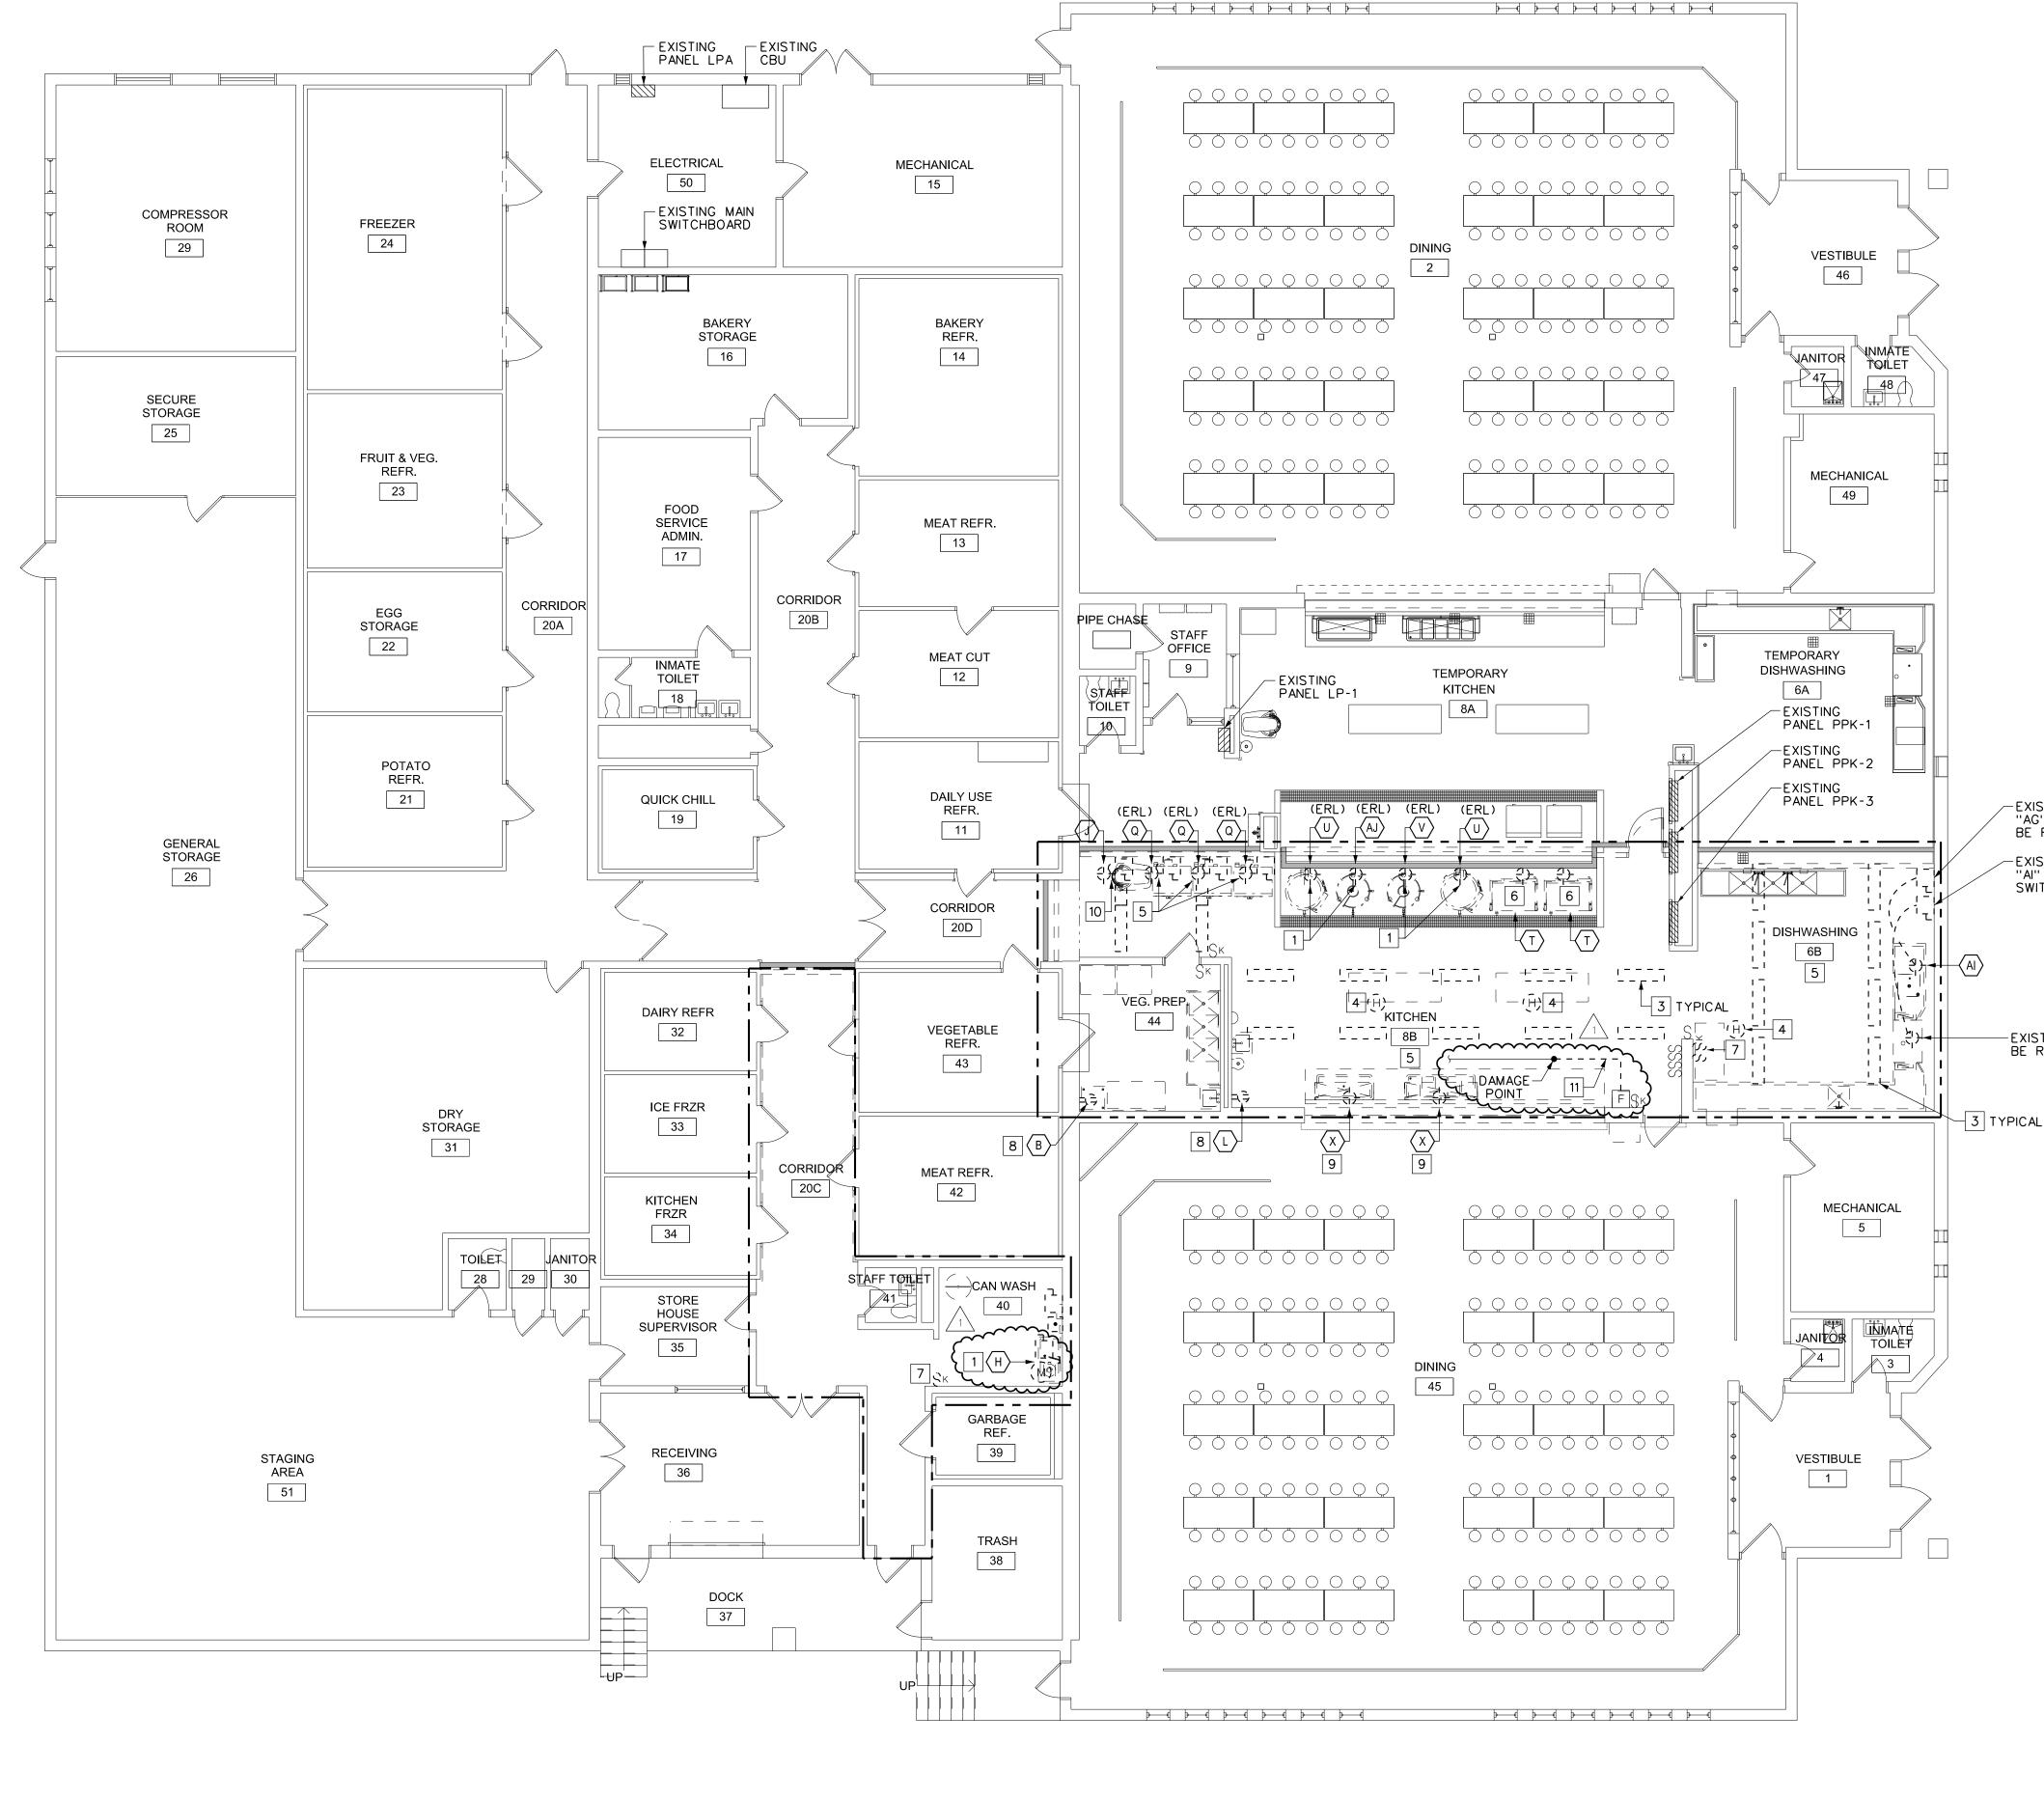

# PHASE 2 - SIDE 'B' - REMOVALS - ELECTRICAL

SCALE: 1/8" = 1'-0"

### **GENERAL NOTES:**

- A. ALL DEVICES ON SURFACES AFFECTED BY CONSTRUCTION SHALL BE REMOVED TO AN EXTENT NECESSARY TO ACCOMMODATE CEILING AND WALL SURFACE REPLACEMENT. EXISTING DEVICES AND CIRCUITING ARE TO BE REUSED UNLESS OTHERWISE NOTED. LIGHTING FIXTURES ARE TO BE REPLACED.
- B. PROVIDE TEMPORARY LIGHTING FOR A SAFE, WORKABLE CONSTRUCTION AREA IN THIS PHASE.

- EXISTING BOOSTER HEATER "AG" DISCONNECT SWITCH TO BE REPLACED. 2 - EXISTING DISH MACHINE 2 "AI" 200A. DISCONNECT 2 SWITCH TO BE REUSED.


-EXISTING DISH MACHINE TO BE REUSED.

1 E-104 N

	MOVAL NOTES: REMOVE EXISTING ELECTRICAL EQUIPMENT TO ACCOMMODATE CONSTRUCTION. EQUIPMENT TO BE REPLACED BY ITEM 8 IN RENOVATED KITCHEN. REFER TO DRAWINGS E-108 AND E-600.
2	DISCONNECT AND REMOVE EXISTING DISHWASHER AND BOOSTER HEATER TO ACCOMMODATE WALL, FLOOR AND CEILING CONSTRUCTION. TO BE REINSTALLED IN PHASE 2 REFER TO DRAWING E-108.
3	AFTER TEMPORARY KITCHEN AND DISHWASHING 8A IS FULLY FUNCTIONAL, DISCONNECT AND REMOVE ALL EXISTING LIGHTING FIXTURES IN "KITCHEN 8B" AND "DISHWASHING 6B" TO ALLOW FOR CONSTRUCTION IN THIS AREA. MAINTAIN CONTINUITY OF CIRCUIT TO ALL FIXTURES AND SWITCHES THAT ARE TO REMAIN DURING THIS PHASE OF CONSTRUCTION. FIELD VERIFY QUANTITIES AND LOCATIONS. COORDINATE WORK WITH PHASE 2 SIDE "A".
4	DISCONNECT AND REMOVE EXISTING DETECTOR. REINSTALL IN SAME LOCATION. REFER TO DRAWING E-107.
5	DISCONNECT EXISTING EQUIPMENT AT ELECTRICAL TROUGH. PROTECT CONDUIT AND CABLE DURING CONSTRUCTION. EXISTING CIRCUIT TO BE EXTENDED FOR TEMPORARY USE. REFER TO DRAWING E-105.
6	REMOVE EXISTING SKILLET AND ALL ASSOCIATED WIRE BACK TO PANEL PPK-2. EXISTING CONDUIT MAY BE REUSED WHERE FEASIBLE.
7	DISCONNECT EXISTING LIGHT SWITCHES TO ACCOMMODATE CONSTRUCTION.
8	REMOVE EXISTING RECEPTACLE AND ASSOCIATED CONDUCTORS BACK TO PANEL PPK-3. MARK BREAKER AS SPARE. REFER TO DRAWING E-108 AND E-600 FOR ADDITIONAL WORK.
9	DISCONNECT EXISTING SERVING LINE. EXISTING CIRCUIT SHALL BE REUSED FOR ITEM 4a AND 4b. REFER TO DRAWING E-108.
	REMOVE EXISTING MIXER AND ALL ASSOCIATED CONDUIT
	DAMAGED CONDUIT IN SLAB TO BE REPLACED. REMOVE CONDUIT FROM DAMAGE POINT BACK TO PULL STATION ON EAST WALL. REPLACE CONDUIT AND REINSTALL EXISTING CABLE. NO SPLICES IN EXISTING CABLES ARE PERMITTED. PROVIDE ALL THREADED FITTINGS REQUIRED FOR A COMPLETE CONDUIT SYSTEM FROM END TO END.


**REVISED DRAWING 02/17/16** 

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LOCATION: GOUVERNEUR CORRECTIONAL FACILITY SCOTCH SETTLEMENT RD,
GOUVERNEUR, NY CLIENT: DEPARTMENT OF CORRECTIONS AND COMMUNITY SUPERVISION
Image:
SHEET TITLE:
PHASE 2 - SIDE 'B' - REMOVALS ELECTRICAL
DRAWING NUMBER:
E-104

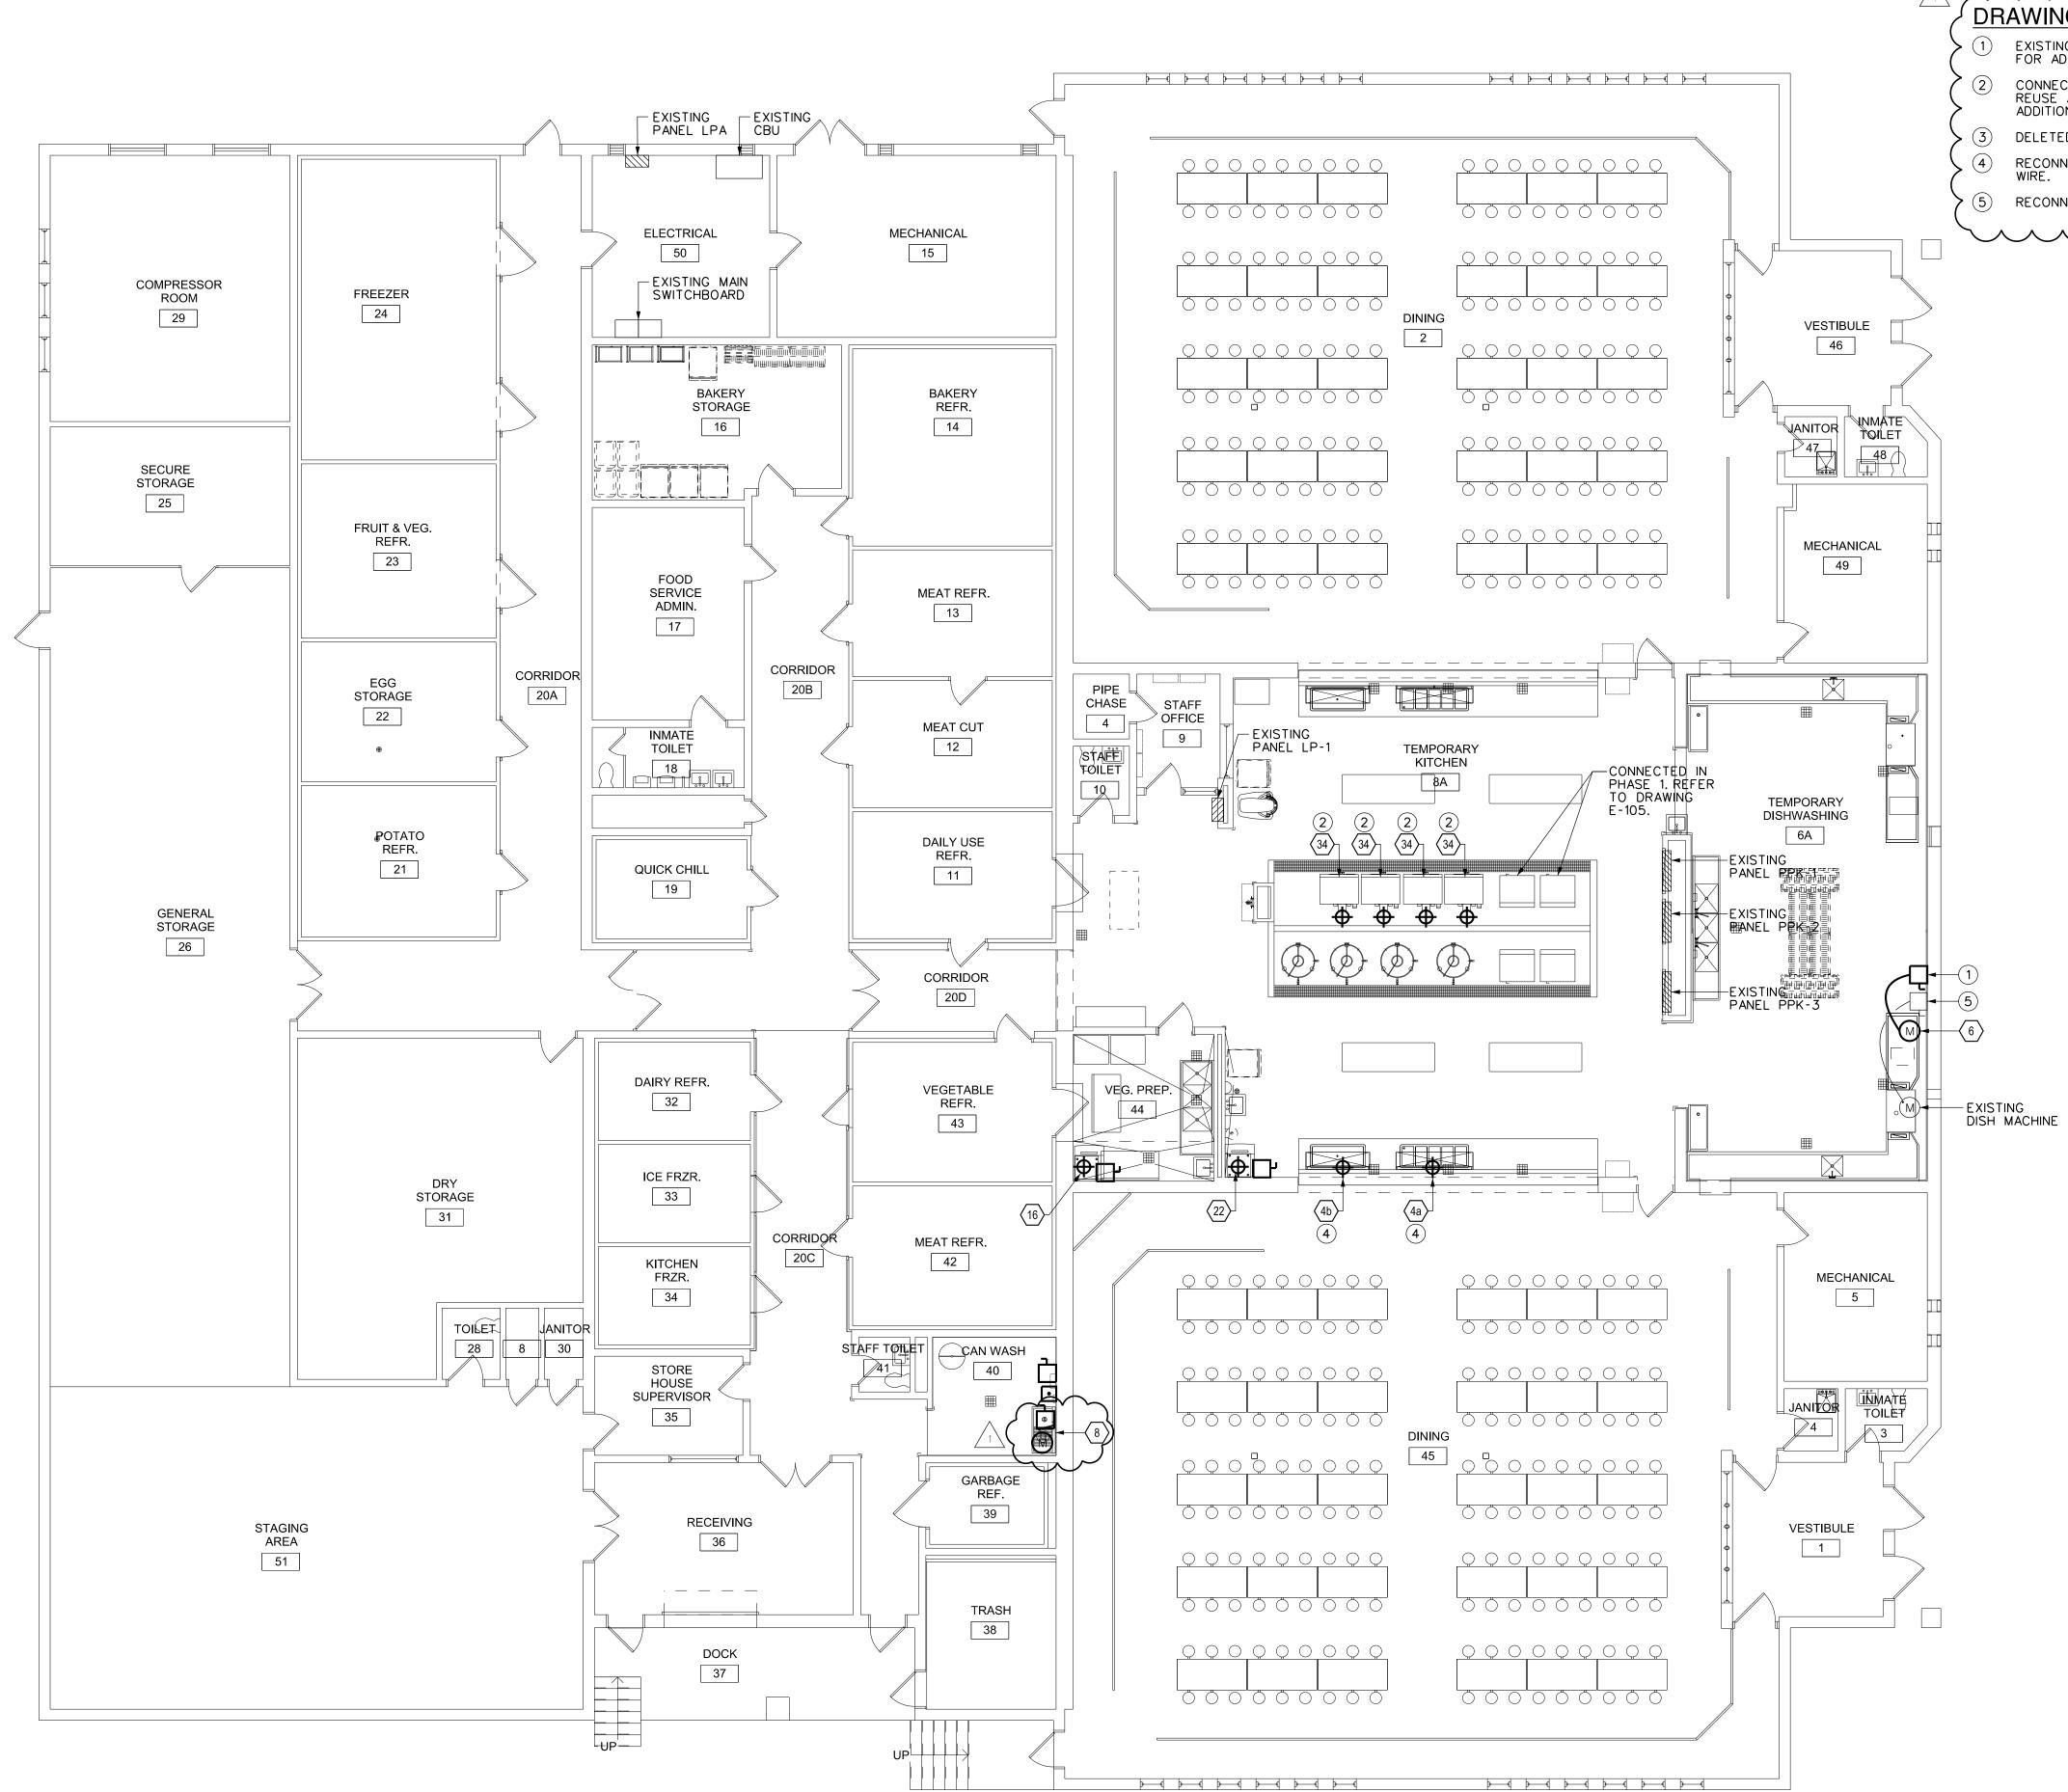

# **RENOVATED KITCHEN - COMPLETE - POWER & SYSTEMS**

SCALE: 1/8" = 1'-0"

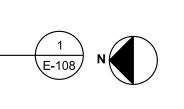

#### **DRAWING NOTES:**

1 EXISTING BOOSTER HEATER REPLACED WITH ITEM 6. REFER TO E-600 FOR ADDITIONAL INFORMATION.

CONNECT EQUIPMENT TO EXISTING CIRCUIT AT ELECTRICAL TROUGH. REUSE AND EXTEND CONDUIT AND WIRE. REFER TO DRAWING E-600 FOR ADDITIONAL INFORMATION. DELETED

RECONNECT SERVING LINES TO EXISTING CIRCUIT. EXTEND CONDUIT AND WIRE. RECONNECT EXISTING DISH MACHINE TO EXISTING CIRCUIT.

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## REVISED DRAWING 02/17/16


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				LOAD							CONNECT		
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KITCHEN EQUIPMENT DESIGNATION	DESCRIPTION	QTY.	HP	ĸw	AMPS	VOLTAGE	PHASE	PANEL	CIRCUIT BREAKER	C <b>I</b> RCUIT NUMBER	NEMA PLUG AND RECEPT	HARD WIRED	NOTES
В		1			14.4	120	1				5-20		EQUIPMENT BEING REMOVED AND REPLACED BY ITEM 16.
Н	DISPOSER		7.5		19.8	208	3	~~~~~~				X	EQUIPMENT BEING REMOVED AND REPLACED. (NOTE E)
J	MIXER		$\cdots$		5.8	208	1					×	RELOCATED TO KITCHEN 8B FOR TEMPORARY USE. (NOTE B)
L	ICE MACHINE	1			14.4	120	1				5-20		EQUIPMENT BEING REMOVED AND REPLACED BY ITEM 22.
Р	TOASTER WITH CART	1			24	208	1				6-20		RELOCATED TO KITCHEN 8B FOR TEMPORARY USE. (NOTE B)
Q	DOUBLE CONVECTION OVEN	3		10.4		208	3					x	RELOCATED FOR TEMPORARY USE. (NOTE C)
R	DOUBLE CONVECTION OVEN	1		10.4		208	3					х	EQUIPMENT BEING REMOVED AND REPLACED BY ITEM 34. (NOTE A)
S	SKILLET	2		20.9		208	3					х	EQUIPMENT BEING REMOVED AND REPLACED BY ITEM 33.
Т	SKILLET	2		20.9		208	3					х	EQUIPMENT BEING REMOVED AND REPLACED BY ITEM 33.
U	KETTLE	2			83.3	208	3					х	RELOCATED TO KITCHEN 8A FOR TEMPORARY USE. (NOTE B)
v	KETTLE	1			40.9	208	3					x	RELOCATED TO KITCHEN 8A FOR TEMPORARY USE. (NOTE B)
w	SERVING LINE	1										x	EQUIPMENT BEING REMOVED AND REPLACED BY ITEM 10 AND 1b. (NOTE A)
x	SERVING LINE	1										x	EQUIPMENT BEING REMOVED AND REPLACED BY ITEM 40 AND 4b. (NOTE A)
AB	DISH MACHINE	1			48.4	208	3					x	EQUIPMENT BEING REMOVED AND REINSTALLED. (NOTE D)
AD	BOOSTER HEATER	1			119	208	3					x	EQUIPMENT BEING REMOVED AND REPLACED BY ITEM 3.
AG	DISH MACHINE	1			48.4	208	3					x	EQUIPMENT BEING REMOVED AND REINSTALLED. (NOTE D)
AI	BOOSTER HEATER	1			119	208	3					x	EQUIPMENT BEING REMOVED AND REPLACED BY ITEM 6.
AJ	60 GAL. KETTLE	1			40.9	208	3					x	EQUIPMENT BEING REMOVED AND REPLACED BY ITEM 28. (NOTE A)


# EXISTING KITCHEN EQUIPMENT SCHEDULE NOTES:



KITCHEN EQUIPMENT – ELECTRICAL CONNECTION SCHEDULE

			1															1		
				LOAD	1									CONNECTION TYPE NEMA 1 DISC. 3	SWITCH (1)	NEMA 3R DISC	C. SWITCH (2)	NEMA 4SS DIS	C. SWITCH (3)	
KITCHEN EQUIPMENT DESIGNATION	DESCRIPTION	QTY.	HP	ĸw	AMPS	VOLTAGE	PHASE	PANEL	CIRCUIT BREAKER	CIRCU <b>I</b> T NUMBER	BRA	NCH CIRCUIT WI	RING	NEMA PLUG HARD WIRED SWITCH AMPS	FUSE SIZE	SWITCH AMPS	FUSE SIZE	SWITCH AMPS	FUSE SIZE	NOTES
											PHASE	GND	CONDUIT							
10	SERVING LINE	1			24	200	1	PPK-1						X						(NOTE A)
1b	SERVING LINE	1	.5		10	115	1	PPK-1						X						(NOTE A)
3	BOOSTER HEATER	1		45	125	200	3	PPK-1	3P.175A.		3-•2/0	1-•4	2''C	x				200	NA	(NOTE B)
40	SERVING LINE	1			24	200	1	РРК-3						x						(NOTE A)
4b	SERVING LINE	1	.5		10	115	1	РРК-3						x						(NOTE A)
A 6	BOOSTER HEATER	1		45	125	200	3	РРК-3	3P.175A.		3-•2/0	1-•4	2''C	x				200	NA	(NOTE B)
∕₁∖{  8	DISPOSER	1	10		30	208	3	PPK-2	3P.40A.		3-•8	1-•8	3/4"C	X						(NOTE C)
10	MIXER	1	2.7		18	208	1	PPK-1	2P.25A.		3-•12	1-•12	3/4"C	X						(NOTE B)
16	ICE MACHINE	1			19.8	208	1	РРК-3	2P.25A.		3-•12	1-•12	3/4"C	X				30	NA	(NOTE B)
22	ICE MACHINE	1			19.8	208	1	РРК-3	2P.25A.		3-•12	1-•12	3/4''C	x				30	NA	(NOTE B)
28	60 GAL. KETTLE	1			40.9	208	3	РРК-3	3P.60A.		3-*6	1-•6	1''C	x						(NOTE B)
33	CONVECTION STEAMER	3		42	117	208	3	PPK-2	3P.150A.		3-•1/0	1-•6	2''C	x						(NOTE B)
33	CONVECTION STEAMER	1		42	117	208	3	PPK-3	3P.150A.		3-•1/0	1-•6	2''C	x						(NOTE B)
34	DOUBLE CONVECTION OVEN	4		10.4		208	3	PPK-1	3P.40A.		3-•8	1- <b>•</b> 8	3/4''C	x						(NOTE B)
						200	5				5 0	. 0	5,70							
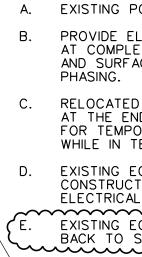
## KITCHEN EQUIPMENT SCHEDULE NOTES:

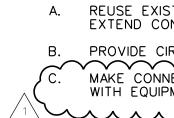

A. EXISTING POWER CONNECTIONS TO BE REUSED. REFER TO FLOOR PLANS. B. PROVIDE ELECTRICAL CONNECTION FOR TEMPORARY USE AS SHOWN ON DRAWINGS. AT COMPLETION OF EQUIPMENT'S TEMPORARY USE, RESTORE EXISTING CONNECTION AND SURFACES AFFECTED BY TEMPORARY LOCATION. REFER TO FLOOR PLANS FOR DRASING

C. RELOCATED FOR TEMPORARY USE, EQUIPMENT IS TO BE REPLACED WITH ITEM 34 AT THE END OF PHASE 2. REFER TO DRAWINGS E-103, E-104, E-105 AND E-107 FOR TEMPORARY LOCATIONS. PROVIDE NEMA 4SS DISCONNECTS FOR EQUIPMENT WHILE IN TEMPORARY EQUIPMENT LOCATIONS.

D. EXISTING EQUIPMENT TO BE REMOVED AND REINSTALLED TO ACCOMMODATE CONSTRUCTION. REFER TO FLOOR PLANS FOR PHASING. REUSE EXISTING ELECTRICAL CONNECTION.


E. EXISTING EQUIPMENT BEING REMOVED AND REPLACED. REMOVE CONDUIT AND WIRE BACK TO SOURCE.

A. REUSE EXISTING EQUIPMENT ELECTRICAL CONNECTION AND CIRCUIT BREAKER. EXTEND CONDUIT AND CABLE.

B. PROVIDE CIRCUIT BREAKER IN EXISTING PANEL. (C. MAKE CONNECTION TO DISCONNECT SWITCH AND CONTROL DEVICE PROVIDED) WITH EQUIPMENT. 

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	Office of General Services
D	DESIGN & CONSTRUCTION
CONSULTANT	
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Arc	Kideney Chitects
	Kideney Architects, P.C. ARCHITECTS   PLANNERS INTERIORS   LANDSCAPE DESIGN KA PROJECT: 2014010.00
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	ENGINEERING P.C.
E	MECHANICAL/ELECTRICAL ENGINEERING CONSULTANTS M/E JOB 141066.20
$\sum$	Roth Consulting Group, Inc.
	7
WARNING:	
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FOR A LANDSC NEW YORK STA	AN ENGINEER OR LANDSCAPE ARCHITECT CAPE ARCHITECT, IS A VIOLATION OF THE ATE EDUCATION LAW AND/OR REGULATIONS SS 'A' MISDEMEANOR.
STATE OF M	VEW YORK
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A POFES	STONAL
CONTRACT:	
	ELECTRICAL
title: R	REHABILITATE KITCHEN Building no. 12
100.775	DUILDHNU INU, IZ
	IEUR CORRECTIONAL FACILITY
CLIENT:	GOUVERNEUR, NY
DEPARTN	MENT OF CORRECTIONS AND
	02/17/2016 REVISED DRAWING
MARK	05/18/2015BID DOCUMENTSDATEDESCRIPTION
PROJECT NUMBER:	44975 - E
DESIGNED BY:	JAS
1713 V (V (V ) 1775	JAS
DRAWN BY: Field check:	
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FIELD CHECK:	ELECTRICAL
FIELD CHECK: APPROVED: SHEET TITLE:	ELECTRICAL

**REVISED DRAWING 02/17/16** 

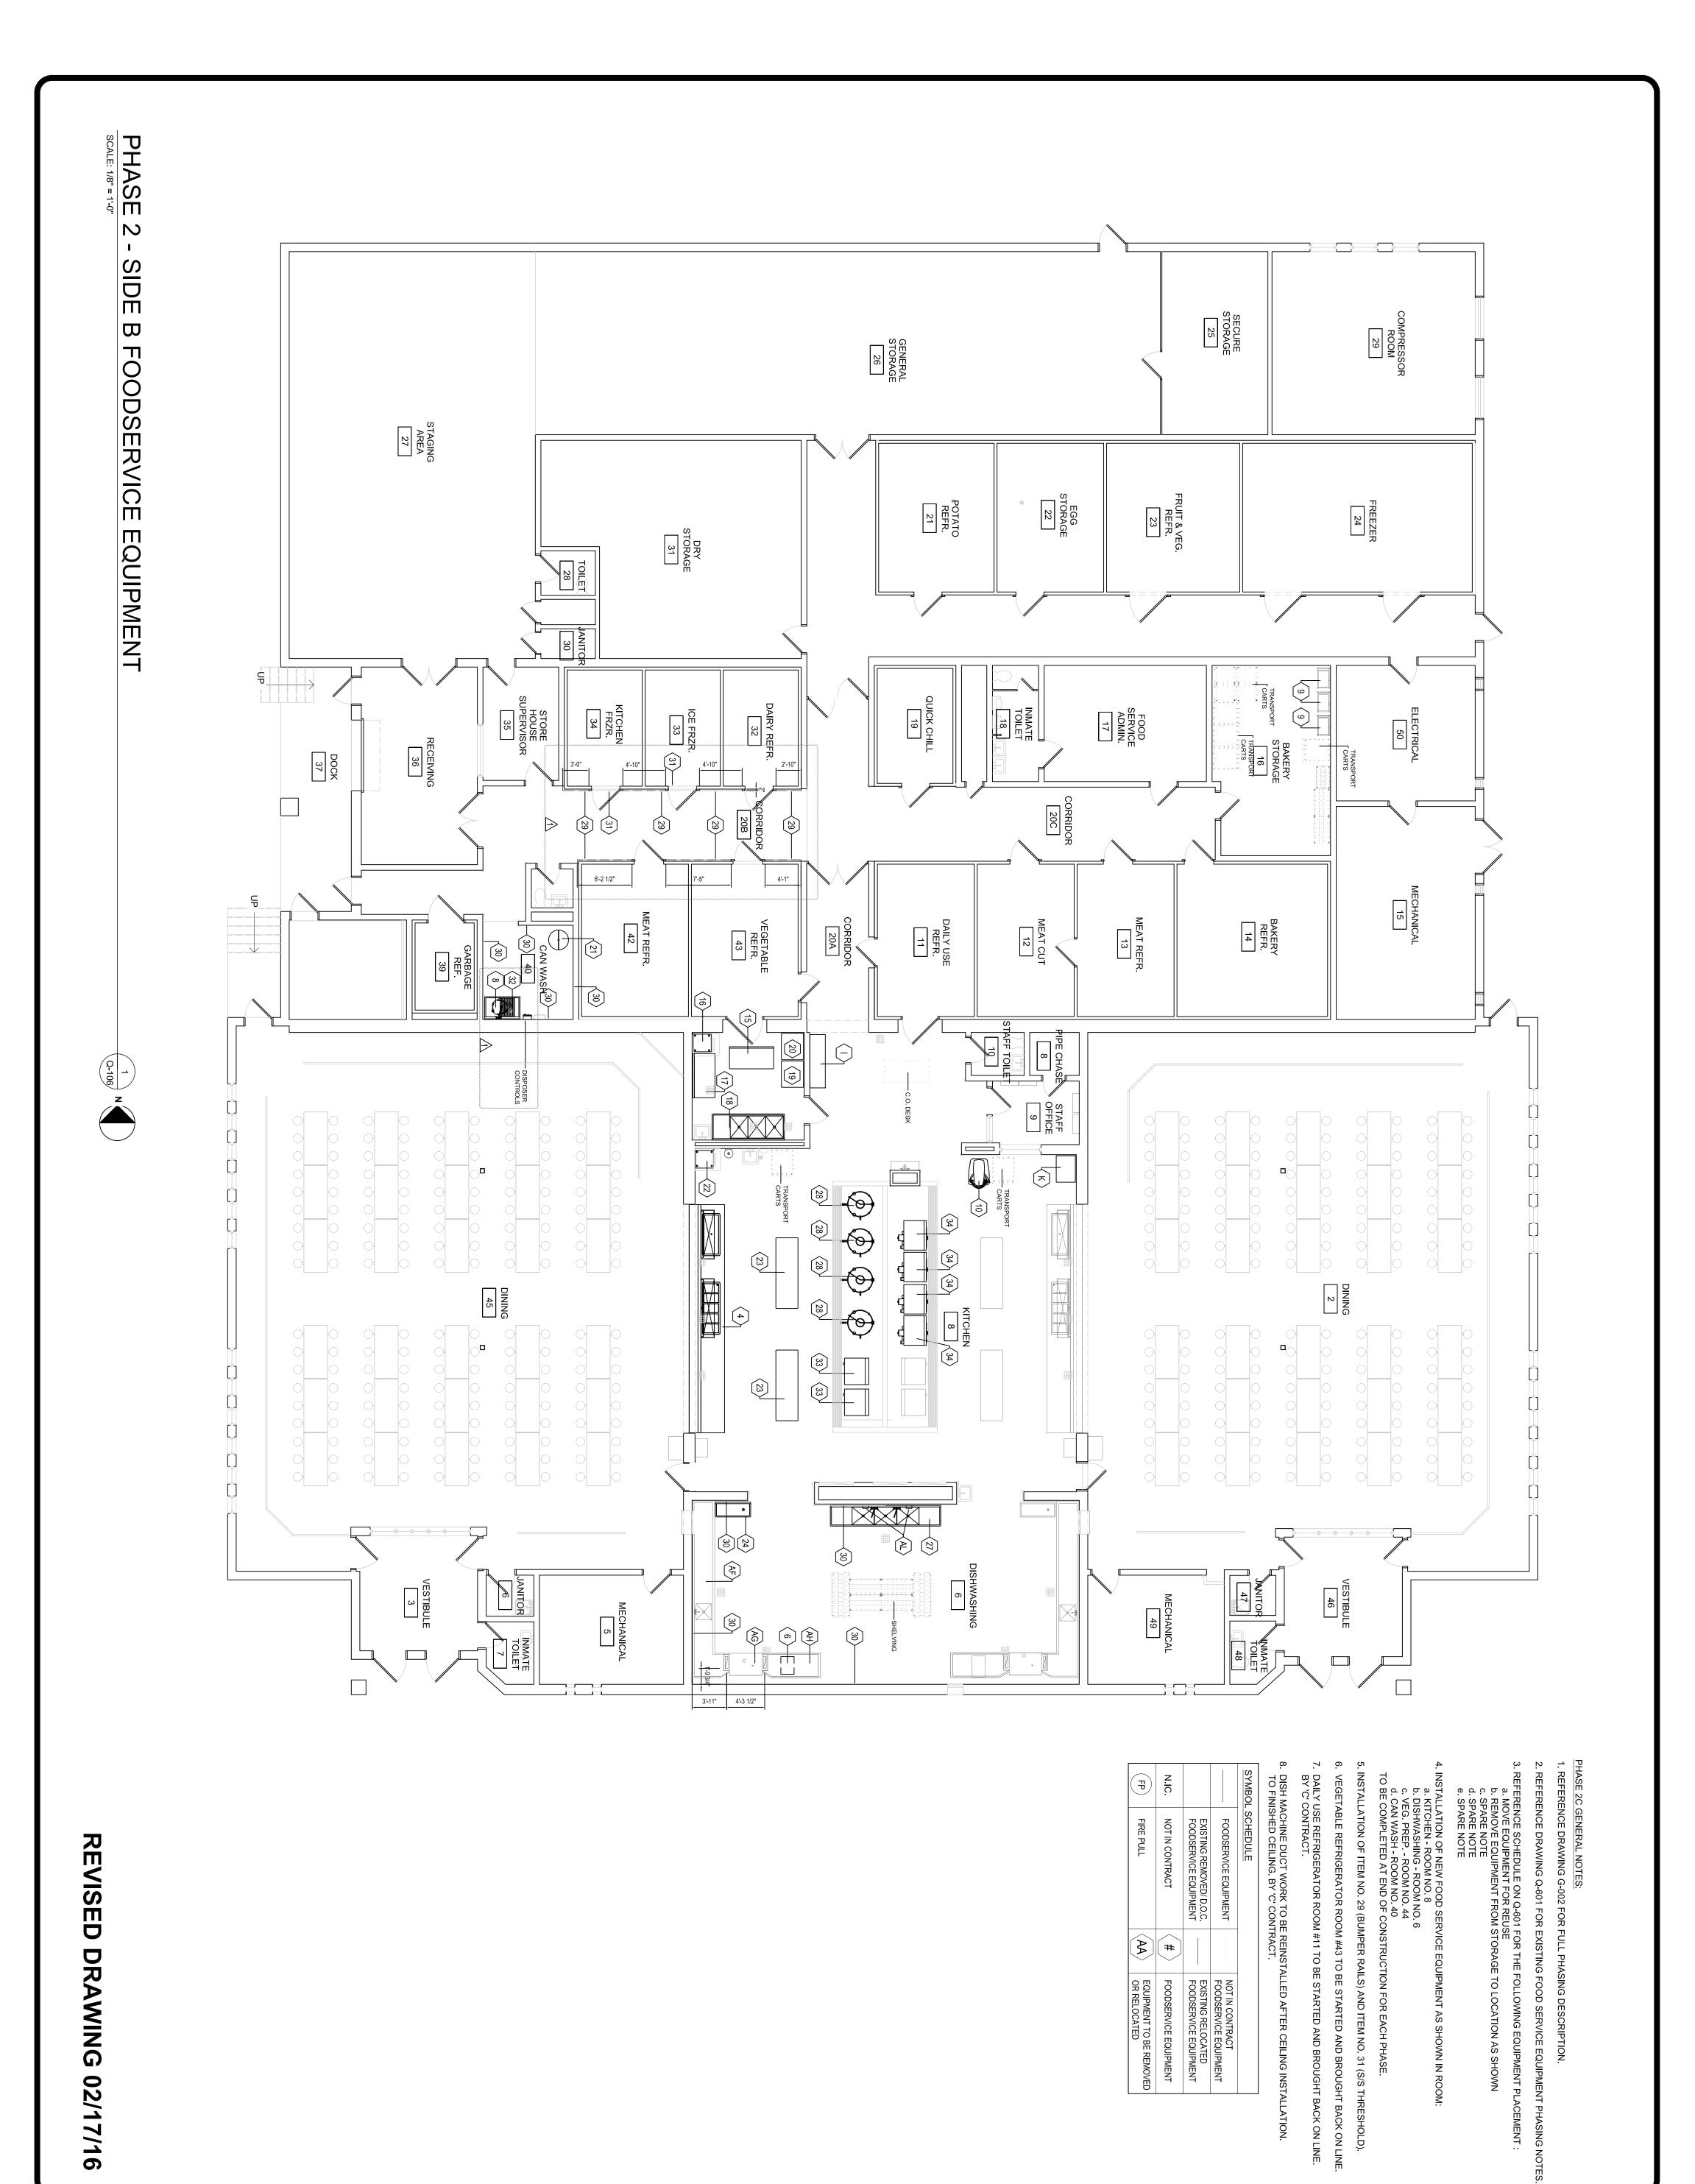

SHEET 25 OF 49	drawing number: Q-106	SHEET TITLE: PHASE 2 - SIDE "B" FOODSERVICE EQUIPMENT	APPROVED: AEG	FIELD CHECK:	DRAWN BY: CY	DESIGNED BY: CY	PROJECT 44975 - (	MARK DATE DESC	05/18/2015 BID	△ 02/17/2016 REVI:				
	)6	SIDE "B" RVICE ENT						DESC RIPTION	BID DOCUMENTS	REVISED DRAWINGS				

**REVISED DRAWING 02/17/16** 

# DEPARTMENT OF CORRECTIONS AND COMMUNITY SUPERVISION

GOUVERNEUR CORRECTIONAL FACILITY SCOTCH SETTLEMENT RD, GOUVERNEUR, NY

REHABILITATE KITCHEN BUILDING NO. 12

C ONSTRUCTION

FIRE PULL

A

EQUIPMENT TO BE REMOVED OR RELOCATED

THE ALTERATION OF THIS MATERIAL IN ANY WAY, UNLESS DONE UNDER THE DIRECTION OF A COMPARABLE PROFESSIONAL, I.E. ARCHITECT FOR AN ARCHITECT, ENGINEER FOR AN ENGINEER OR LANDSCAPE ARCHITECT FOR A LANDSCAPE ARCHITECT, IS A VIOLATION OF THE NEW YORK STATE EDUCATION LAW AND/OR REGULATIONS AND IS A CLASS 'A' MISDEMEANOR.

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NOT IN CONTRACT

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FOODSERVICE EQUIPMENT

Roth Consulting Group, Inc.

FOODSERVICE EQUIPMENT

EXISTING REMOVED/ D.O.C. FOODSERVICE EQUIPMENT

NOT IN CONTRACT FOODSERVICE EQUIPMENT EXISTING RELOCATED FOODSERVICE EQUIPMENT

MECHANICAL/ELECTRICAL ENGINEERING CONSULTANTS M/E JOB 141066.20


ENGINEERING P.C.

Kideney Architects

Kideney Architects, P.C. ARCHITECTS | PLANNERS INTERIORS | LANDSCAPE DESIGN

Office of General Services

**DESIGN & CONSTRUCTION** 

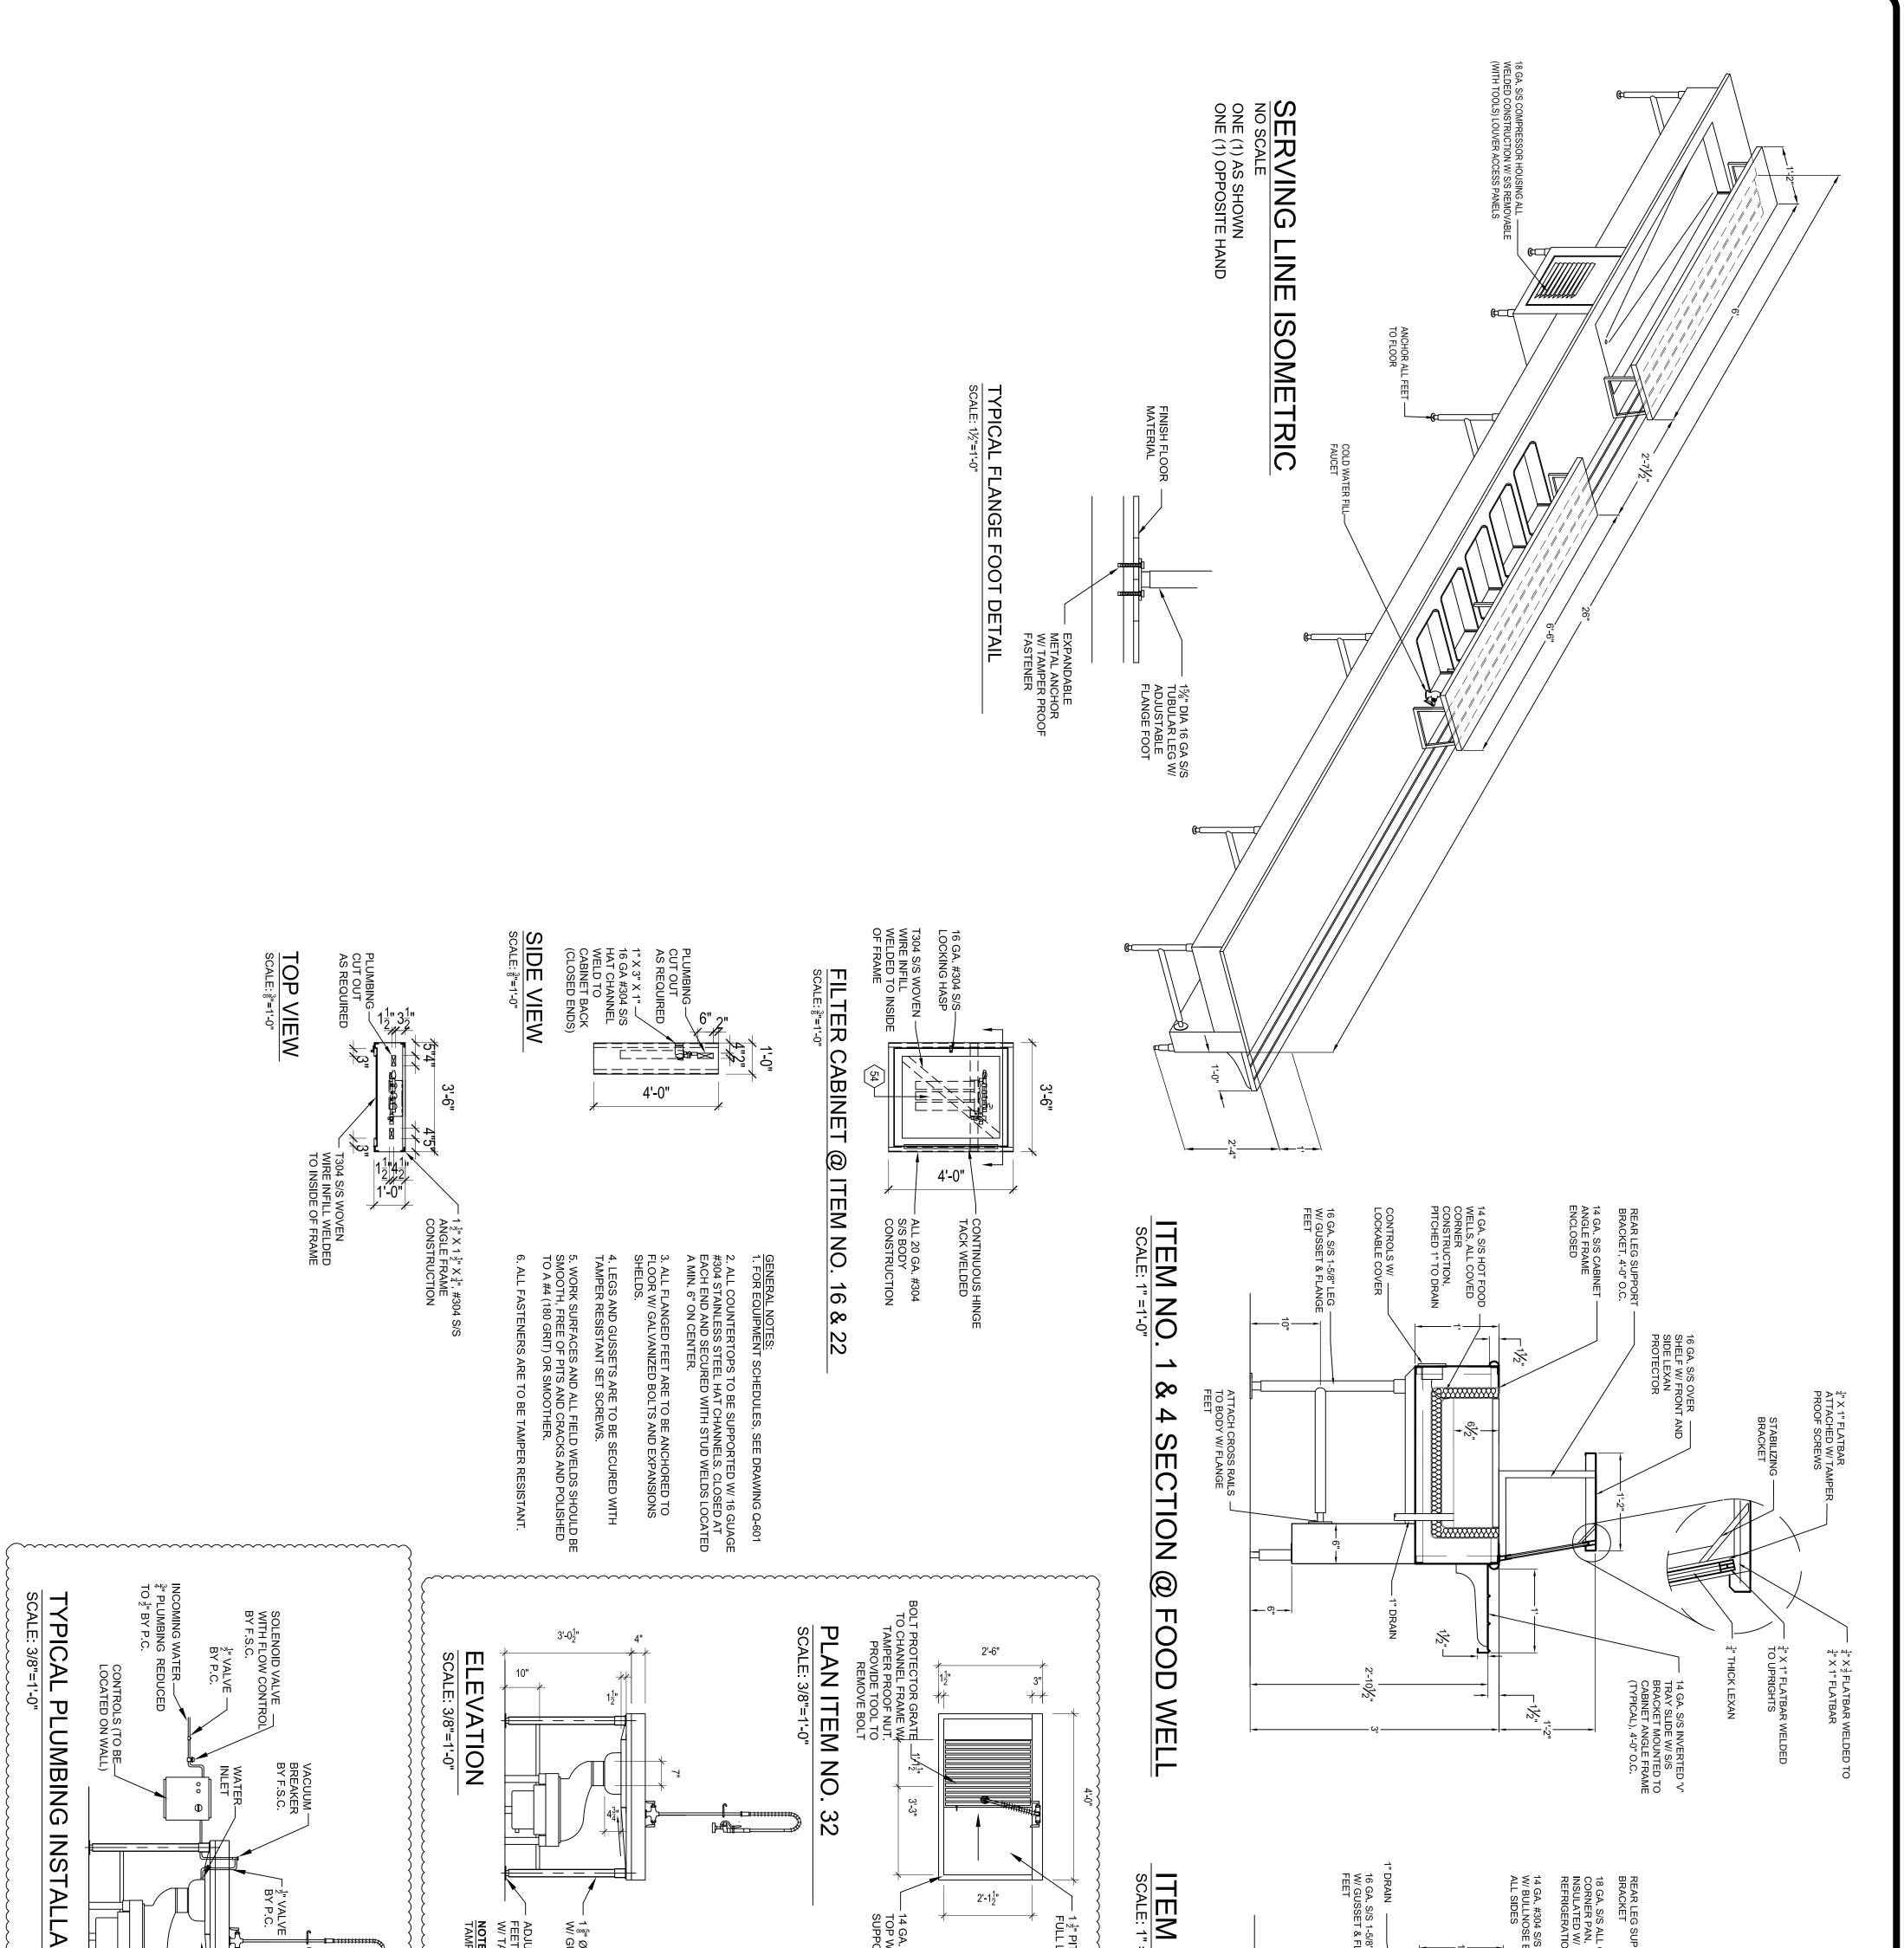

ATION REVISED DRAWING 02/17/16	L REFERENCE ONLY CONNECTIONS, FITTINGS O COMPONENTS TO BE TALLED UNDER 'P' CONTRACT E' CONTRACT	Ø 16 GA SIS LEGS 3USSET SUSSET SUSSET SUSSET USTABLE FLANGE T. ANCHOR TO FLOOR T. ANCHOR TO FLOOR SCALE: 3/8"=1'-0"	FLAT BAR FLAT BAR FLAT BAR	NO. 1 & 4 SECTION @ COLD FOOD	ATTACH CRC TO BODY W/ FEET		16 GA. S/S OVER SHELF W/ FRONT AND SIDE MOUNT LEXAN PROTECTOR PPORT - COVED -	
DRAWING NUMBER: Q-502 SHEET 27 OF 49	Image: Image	COMMUNITY SUPERVISION	CONTRACT: CONSTRUCTION TITLE: REHABILITATE KITCHEN BUILDING NO. 12 LOCATION: GOUVERNEUR CORRECTIONAL FACILITY SCOTCH SETTLEMENT RD, GOUVERNEUR, NY CLIENT: DEPARTMENT OF CORRECTIONS AND	NEW YORK STATE EDUCATION LAW AND/OR REGULATIONS AND IS A CLASS 'A' MISDEMEANOR.	Roth Consulting Group, Inc. WARNING: THE ALTERATION OF THIS MATERIAL IN ANY WAY, UNLESS DONE UNDER THE DIRECTION OF A COMPARABLE PROFESSIONAL, I.E. ARCHITECT FOR AN ARCHITECT, ENGINEER FOR AN ENGINEER OR LANDSCAPE ARCHITECT FOR A LANDSCAPE ARCHITECT, IS A VIOLATION OF THE	MECHANICAL/ELECTRICAL ENGINEERING CONSULTANTS M/E JOB 141066.20	Kideney Architects, P.C.	MEWYORK STATE OF OFFORTUNITY. DESIGN & CONSTRUCTION

	ROUTE TO BOILER 33		ထမ္ ထမ္	×	208 3	P/E 117 42		SEE DWG Q - 103 & Q-106	STEAMER	33 4
			21					DWG Q - 106	SCRAP SINK	
	30			×	120	□ - 0.29			S/S WALL PANELS	30 1 lot.
								DWG Q -	S/S BUMPER RAILS	
7	2		$\begin{array}{c ccccccccccccccccccccccccccccccccccc$	×	208	P ₽/E 40.90		SEE DWG Q - 106	SCULLERY SINK	27 1 28 4
	2								NOT USED	26 -
									NOT USED	
	2						n n n n	SEE DWG Q - 106	WORK TABLE	23 2
	2	/ 1/2	<u>ଷଧ୍</u> ର 4 ଦ୍ରୁ	×	208 1	P/E 19.80		DWG Q -	ICE MACHINE	22 1
	2		일 4 일 4 1 <u>1</u> <u>1</u>			P/E			CAN WASHER	
	2					•			WORK TABLE	20 1
			$(2)\frac{1}{2}$ $(2)\frac{1}{2}$			· τ		SEE DWG Q - 100	WORK TABLE	
		2 	2 2 4 			, ,		SEE DWG Q - 106	WORK TABLE	
	_		<u>نيا</u> ھ يواھ	×	208 1	P/E 19.80			ICE MACHINE	16 1
			,						WORK TABLE	15 1
	14							I I	NOT USED	14 -
	13								NOT USED	13 -
	12					•		SEE DWG Q - 103	WORK TABLE	
							0	103	WORK TABLE	11 2
				×			- 106 C	SEE DWG Q - 103, Q-105 AND Q	MIXER	
			2 <sup></sup>	~~~~~~~~~~~~~~~~~~~~~~~~~~~~~~~~~~~~~~	208 ····			SEE DWG Q - 100		~~~~~~~~~~~~~~~~~~~~~~~~~~~~~~~~~~~~~~
	·····			×		30 00		SEE DWG Q - 102	NALK-IN COOLER DOOR	
	ROUTE TO DISH MACHINE 6		2j4	×	208 3	P/E 125.00 45	) () ) ()	SEE DWG Q - 106	BOOSTER HEATER	
11									NOT USED	თ -
F.D. FLOOR DRAIN	D WELLS	1"		5-15P COLD WEL	1/2 120 1	10.00				
P SIP				X HOT WELLS		24.00	0 0 0 0	DWG Q -	SERVING LINE	
FURN			<u>ال</u>	×	2008 3008	₽/₣ 125.00 45		SFF DWG 0 - 103	BOOSTER HEATER	ω N
່ ເດ	COLD WELLS			5-15P COLD WELLS		10.00				)
LEGEND	HOT WELLS			HOT WELL		C/P/E 24.00	с с	SEE DWG Q - 103	SERVING LINE	
-	E CFM SIZE PRESSURE	ND CFM SIZE PRESSUR		UIR NEMA ELECT	HP VOLIS			MARKS	·   😑	
	MAKE UP AIR		-	FOODSERVICE E						
	AM						04		WALK-IN FREEZER THRESHOLD	AM 2
	AL					AND Q - 106	Q - 102, Q - 104, Q - 105	SER (d) RELOCATE Q - 101,	SOAP & RINSE AGENT DISPENSER	2
		2		_	40.90			(d) REMOVE Q - 1	BUMPER RAILS	7
			1= 1= 1=	208 3	40.00		- 104 - 104 (d) REMOVE O - 105		80 GAL KETTLE	AJ A
<u> </u>			<u> </u>				a) RELOCATE Q-	(b) STORE Q-104	CLEAN DISH TABLE	<u> </u>
		1 1=	211	208 3	48.4		(a) RELOCATE Q-106	(b) STORE Q-104	DISH MACHINE AND EXHAUST [	AG 1
I	A	<u></u>	יביע ביר				$\sim$		SOILED DISH TABLE	
5. ITEM NUMBERS THAT ARE NO LONG			<u>וא</u>	208 3	119.0		- 101 04	(d) (t) REMOVE Q - 101	WORK TABLE	
			2				(a) RELOCATE Q-103	(b) STORE Q-101,	CLEAN DISH TABLE	AC 1
			N11	208 3	48.4		(a) RELOCATE Q-103	DUCT (b) STORE Q-101,	EXHAUST	AB 1
			21-1-22-1-				(a) RELOCATE Q-103			AA 1
								(d) REMOVE Q - 1	WORK TABLE	Z 1
		<u></u>	214		- 105	E Q - 104, (e) (f) REMOVE Q	E Q - 101, Q - 102, (e) RELOCATE	(a) (e) RELOCATE	SCULLERY SINK	Y 1
							- 104	(d) (f) REMOVE Q	SERVING LINE	
a. MOVE EQUIPMENT FOR REUSI			_	_	40.9			(d) (f) REMOVE Q - 101	SERVING LINE	
			1 221		83.3		- Q - 104, (d) REMOVE Q-105			
			<u>+</u> 21 <u>+</u>	208 3				(d) REMOVE Q-10	TILTING SKILLET	
2. CARE IS TO BE TAKEN IN HANDLING		2	221_1	208 3	20.9		)1	(d) REMOVE Q-101		
1. REFERENCE DRAWING G-002 FOR F								(d) REMOVE Q - 1	DOUBLE CONVECTION OVEN	ת ת
GENERAL NOTES:					1		101, Q - 102, Q - 104, (	(a) (e) RELOCATE	DOUBLE CONVECTION OVEN	
				208 1	24.0	3 LUCATION, (d) REMOVE Q- 105	TO REMAIN IN EXISTING	(c) SHOWN Q - 101,	TOASTER W/ CART	
					2	·			TOASTED W// CABT	
⊥ FURN							101	(d) REMOVE Q - 1	WORK TABLE	
V REQ		431	بوانع	120 1	14.4	: Q - 105	- 102, Q- 103	(a) (e) RELOCATE Q	ICE MACHINE	
REFRIG							01, Q - 102, Q-103, Q -106	(a) RELOCATE Q -	C.O. CABINET	K 1
				208 1	5.80	Q - 104	Q - 101, Q - 102, (f) REMOVE	(a) (e) RELOCATE (		د 
				12		106	Q - 104, Q - 105 AND Q	(a) RELOCATE Q	LOCKABLE TOOL CABINET	_
UND HV				71/ 208 3	19.8		- 104	(d) (f) REMOVE Q - 104	DISPOSER	т ( 
투요			-				- 104		CAN WASHER	ד ה
DWG							104	(d) REMOVE Q - 1	WORK TABLE	ı m
		2"	21-1-				104 (d) (f) REMOVE Q - 105	(a) RELOCATE Q-104	VEGETABLE PREP TABLE	
								(d) REMOVE Q - 1	WORK TABLE	C 1
AMPS		<u>ي</u> ا4	۵۱	120 1	14.4		- 104	(d) (f) REMOVE Q - 104	ICE MACHINE	₿
	PRESSURE CEM SIZE PRESSURE SEE NOTE 3						01	(d) REMOVE Q - 1	WORK TABLE	- 0
2	STATIC SUPPLY COLLAR STATIC REMARKS	DRAIN	CW HW	KW   HP   VOLTS   PH   ELECT		(	TES	PHASING NO	DESCRIPTION	

		DRAWING NUMBER:		APPROVED:	FIELD CHECK:	DRAWN BY:	DESIGNED BY:	PROJECT NUMBER:	MARK						
<u> </u>	2	Q-601	FOODSERVICE EQUIPMENT SCHEDULES	AEG	I	СҮ	СҮ	44975	DATE	05/18/2015	02/17/2016				
i	40	<u> </u>	LES					- 0	DESC RIPTION	BID DOCUMENTS	REVISED DRAWINGS				

34

DOUBLE CONVECTION OVEN

SEE DWG Q - 106

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ROUTE TO BOILER ROUTE TO CONDENSER ROUTE TO FD

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**REVISED DRAWING 02/17/16** 

DEPARTMENT OF CORRECTIONS AND COMMUNITY SUPERVISION

GOUVERNEUR CORRECTIONAL FACILITY SCOTCH SETTLEMENT RD, GOUVERNEUR, NY

C ONSTRUCTION

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ATE OF NEW

REHABILITATE KITCHEN BUILDING NO. 12

C CONTRACTOR ELECTRICIAN FURNISHED BY PLUMBER SET IN PLACE BY UTILITY CONNECTION BY FLOOR DRAIN

WHERE PLUMBING REMARKS CALL OUT BY 'P CONTRACTOR' - P CONTRACTOR IS RESPONSIBLE FOR THE PLUMBING CONNECTIONS TO FOOD SERVICE EQUIPMENT. ITEM NUMBERS THAT ARE NO LONGER LISTED ON THE FOOD SERVICE EQUIPMENT SCHEDULE ARE NO LONGER IN THE FOOD SERVICE CONTRACT OR HAVE BEEN DELETED FROM THE PROJECT.

MECHANICAL/ELECTRICAL ENGINEERING CONSULTANTS M/E JOB 141066.20

Roth Consulting Group, Inc.

ENGINEERING P.C.

AMPERE CUBIC FEET PER MINUTE CONNECTION COLD WATER DIRECT CONNECTION DRAWING GREASE TRAP HORESPOWER HOT WATER INDIRECT CONNECTION KILOWATTS 1,000 BRITISH THERMAL UNITS NOT IN CONTRACT PHASE REFRIGERATION REQUIRED WITH FURNISHED BY SET IN PLACE BY UTILITY CONNECTION BY

Kideney Architects

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Kideney Architects, P.C. ARCHITECTS | PLANNERS INTERIORS | LANDSCAPE DESIGN KA PROJECT: 201401000

NEW YORK STATE OF OPPORTUNITY. General Services

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SET IN PLACE BY
UTILITY CONNECTION BY

GENERAL NOTES: **GENERAL NOTES: GENERAL NOTES: INDEED ARAWING G-002 FOR FULL PHASING DESCRIPTION. CARE IS TO BE TAKEN IN HANDLING EQUIPMENT.** DO NOT DAMAGE EQUIPMENT THAT IS TO BE TURNED OVER TO FACILITY. **3. REFERENCE (SMALL LETTERS) IN PHASING NOTES COLUMN FOR DIRECTION, AND HANDLING EQUIPMENT: a.** MOVE EQUIPMENT FOR REUSE **b.** REMOVE EQUIPMENT AND STORE FOR FUTURE RELOCATION **c.** TO REMAIN IN EXISTING LOCATION, COVER TO PROTECT IF REQUIRED **b.** REMOVE EQUIPMENT AND STORE FOR FUTURE RELOCATION **c.** TO REMAIN IN EXISTING LOCATION, COVER TO PROTECT IF REQUIRED **b.** REMOVE EQUIPMENT AND STORE FOR FUTURE RELOCATION **c.** TO REMAIN IN EXISTING LOCATION, COVER TO PROTECT IF REQUIRED **b.** REMOVE EQUIPMENT TO BE DISCONNECTED BY RESPECTIVE TRADES AND RELOCATED WHEN KITCHEN IS NOT OPERATIONAL - OVERNIGHT HOURS PERO (11000) **f.** FOOD SERVICE EQUIPMENT TO BE REMOVED IS TO BE DISCONNECTED BY RESPECTIVE TRADES AND TURNED OVER TO THE FACILITY **RESPECTIVE TRADES AND TURNED OVER TO THE FACILITY**