



STATE OF NEW YORK
OFFICE OF GENERAL SERVICES
DESIGN AND CONSTRUCTION GROUP
THE GOVERNOR NELSON A. ROCKEFELLER
EMPIRE STATE PLAZA
ALBANY, NY 12242



ADDENDUM NO. 2 TO PROJECT NO. M3039

**CONSTRUCTION WORK
REBUILD SITE STORM DRAINAGE,
BUILDINGS 842, 878
ROCKLAND PC, HUDSON RIVER CAMPUS
10 ROSS CIRCLE
POUGHKEEPSIE, NY 12601**

March 18, 2014


NOTE: This Addendum forms a part of the Contract Documents. Insert it in the Project Manual. Acknowledge receipt of this Addendum in the space provided on the Bid Form.

DRAWINGS

1. Drawings C-101 thru C-103, "ADDENDUM No. 1, 3/12/14", riprap hatch has been lightened, existing contours have been darkened and some existing spot grades have been removed.

END OF ADDENDUM

Margaret F. Larkin
Acting Executive Director

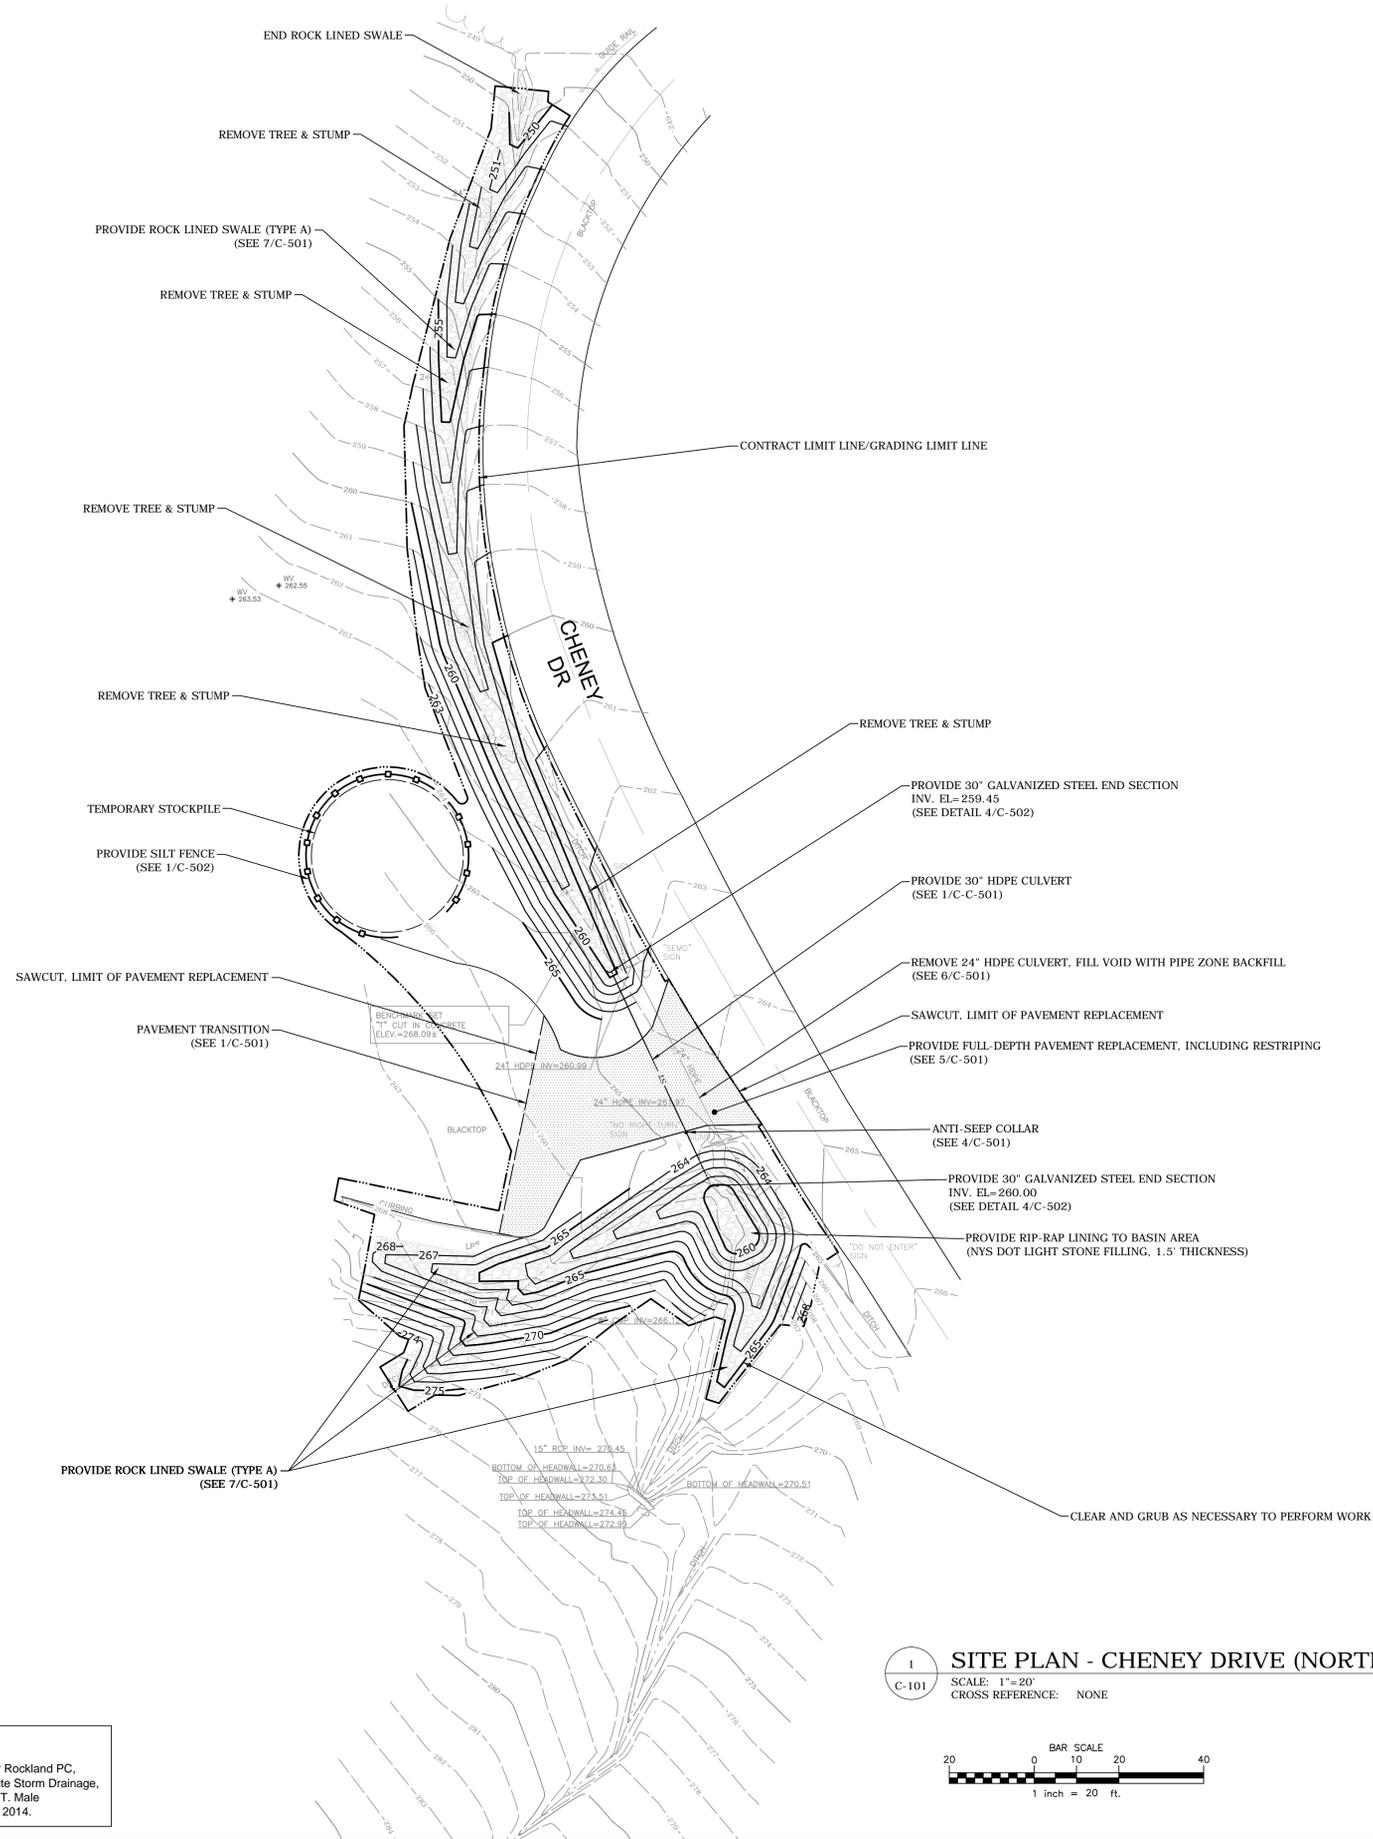

1 SITE PLAN - CHENEY DRIVE (NORTH)
 SCALE: 1"=20'
 CROSS REFERENCE: NONE



CONSTRUCTION SEQUENCING NOTES - CHENEY DRIVE (NORTH)

1. COORDINATE WORK IN THIS AREA WITH SEMO THROUGH DIRECTOR'S REPRESENTATIVE AND FACILITY REPRESENTATIVE.
2. REMOVE TREES AND STUMPS ALONG CHENEY DRIVE.
3. PROVIDE SILT FENCE AND PREPARE TEMPORARY STOCKPILE AREA.
4. EXCAVATE AND ROUGH GRADE THE STORMWATER CONVEYANCE AREAS. EXISTING SWALE STONE FILLING SHALL NOT BE REUSED UNLESS IT CAN BE DEMONSTRATED TO COMPLY WITH THE QUALITY AND GRADATION REQUIREMENTS IDENTIFIED IN THE CONTRACT SPECIFICATIONS AND UNDER NYS DOT FIGURE 620-1 FOR EACH TYPE OF STONE FILLING.
5. REMOVE EXISTING PAVEMENT AND CULVERT.
6. PROVIDE THE CULVERT, END SECTIONS, AND ANTI-SEEP COLLAR.
7. PROVIDE PAVEMENT REPLACEMENT, INCLUDING RESTRIPING.
8. FINISH GRADE AND STABILIZE THE STORMWATER CONVEYANCE AREAS. PROVIDE TEMPORARY EROSION CONTROL BLANKET AND STONE FILLING.
9. STABILIZE (SEED AND MULCH) AREAS OF INCIDENTAL DISTURBANCE. REMOVE ALL CONSTRUCTION DEBRIS FROM THE SITE, AND SWEEP AND REMOVE ANY SEDIMENT FROM THE PARKING LOT AND ROADWAY.
10. REMOVE SILT FENCE ONCE ALL DISTURBED AREAS HAVE ACHIEVED 80 PERCENT VEGETATIVE COVER.

NOTE:
 ESTABLISH TEMPORARY BENCHMARK PRIOR TO DISTURBING EXISTING BENCHMARK.

MAP REFERENCE:
 *Topographic Survey Prepared For Rockland PC, Hudson River Campus - Rebuild Site Storm Drainage, Buildings 842, 878" prepared by C.T. Male Associates, P.C., dated December 2014.



ANDREW M. CUOMO
 Governor
 ROANN M. DESTITO
 Commissioner

CONSULTANT:



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 C.T. MALE ASSOCIATES P.C.

CTM PROJECT NO: 13.3581
 CTM DRAWING NO: 14-0116

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CONSTRUCTION

TITLE:
 REBUILD SITE STORM DRAINAGE BUILDINGS 842, 878

LOCATION:
 ROCKLAND PC, HUDSON RIVER CAMPUS 10 ROSS CIRCLE, POUGHKEEPSIE, NY 12601

CLIENT:
 NEW YORK STATE OFFICE OF MENTAL HEALTH

BID DOCUMENT

BID	DATE	DESCRIPTION
	03/12/2014	ADDENDUM NO. 2
	02/07/2014	BID DOCUMENT

PROJECT NUMBER: **M3039 - C**

DESIGNED BY: TJH

DRAWN BY: MFJ


FIELD CHECK:

APPROVED:

SHEET TITLE:
 SITE PLAN - CHENEY DRIVE (NORTH)

DRAWING NUMBER:
 C-101

SHEET 3 of 7

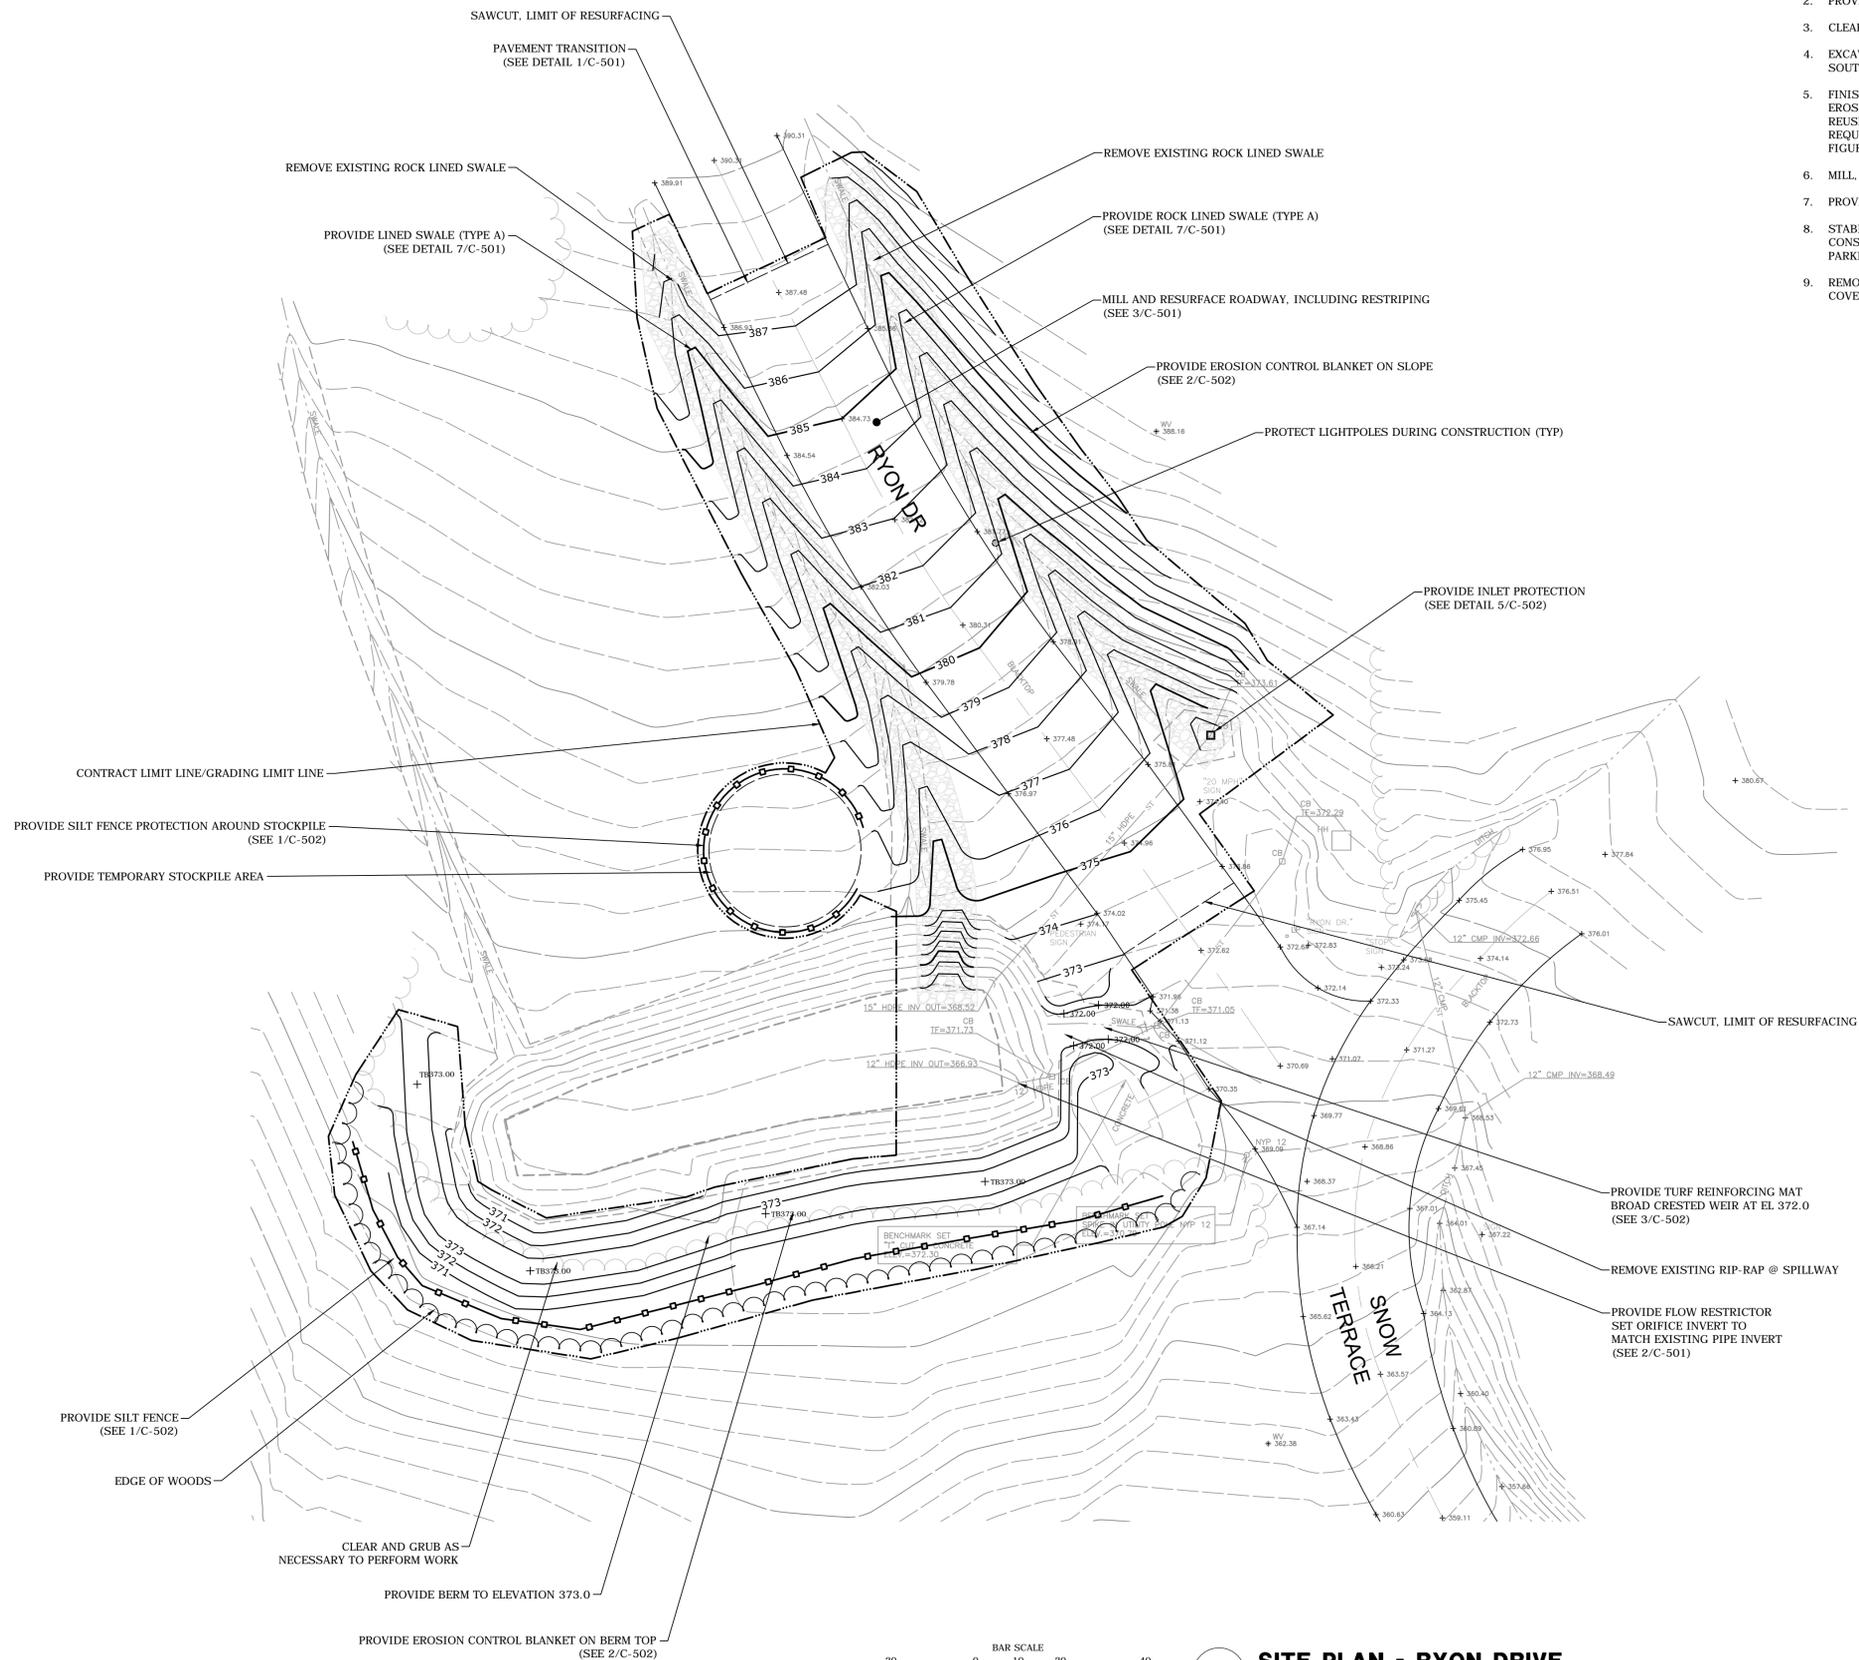

CONSTRUCTION SEQUENCING NOTES - RYON DRIVE

1. CLOSE ROADWAY TO TRAFFIC AS NEEDED, AND PROVIDE ADEQUATE DETOUR SIGNAGE. ROAD CLOSINGS SHALL BE KEPT TO A MINIMUM, AND SHALL BE COORDINATED WITH SEMO THROUGH DIRECTOR'S REPRESENTATIVE AND FACILITY REPRESENTATIVE.
2. PROVIDE SILT FENCE AND PREPARE TEMPORARY STOCKPILE AREA.
3. CLEAR AND GRUB AREA SOUTH OF EXISTING BASIN.
4. EXCAVATE AND ROUGH GRADE THE ROADSIDE SWALES ALONG RYON DRIVE, AND THE SOUTHERN BERM OF THE BASIN.
5. FINISH GRADE AND STABILIZE THE ROADSIDE SWALES AND BERM. PROVIDE TEMPORARY EROSION CONTROL BLANKET AND STONE FILLING. EXISTING STONE FILLING SHALL NOT BE REUSED UNLESS IT CAN BE DEMONSTRATED TO COMPLY WITH THE QUALITY AND GRADATION REQUIREMENTS IDENTIFIED IN THE CONTRACT SPECIFICATIONS AND UNDER NYS DOT FIGURE 620-1 FOR EACH TYPE OF STONE FILLING.
6. MILL, RESURFACE AND RESTRIPE ROADWAY.
7. PROVIDE FLOW RESTRICTOR ON BASIN OUTLET PIPE.
8. STABILIZE (SEED AND MULCH) AREAS OF INCIDENTAL DISTURBANCE, REMOVE ALL CONSTRUCTION DEBRIS FROM THE SITE, AND SWEEP AND REMOVE ANY SEDIMENT FROM THE PARKING LOT AND ROADWAY.
9. REMOVE SILT FENCE ONCE ALL DISTURBED AREAS HAVE ACHIEVED 80 PERCENT VEGETATIVE COVER.



ANDREW M. CUOMO
Governor
ROANN M. DESTITTO
Commissioner



Engineering, Surveying, Architecture & Landscape Architecture, P.C.

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CTM PROJECT NO: 13.3581
CTM DRAWING NO: 14-0116

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CONSTRUCTION

REBUILD SITE STORM DRAINAGE BUILDINGS 842, 878

LOCATION: ROCKLAND PC, HUDSON RIVER CAMPUS 10 ROSS CIRCLE, POUGHKEEPSIE, NY 12601

CLIENT: NEW YORK STATE OFFICE OF MENTAL HEALTH

BID DOCUMENT

BID	DATE	DESCRIPTION
	03/12/2014	ADDENDUM NO. 2
	02/07/2014	BID DOCUMENT

PROJECT NUMBER: **M3039 - C**
DESIGNED BY: TJH
DRAWN BY: MFJ
FIELD CHECK:
APPROVED:

SHEET TITLE:
SITE PLAN - RYON DRIVE
DRAWING NUMBER:
C-102
SHEET 4 of 7

MAP REFERENCE:
Topographic Survey Prepared For Rockland PC, Hudson River Campus - Rebuild Site Storm Drainage, Buildings 842, 878 prepared by C.T. Male Associates, P.C., dated December 2014.



SITE PLAN - RYON DRIVE
SCALE: 1"=20'
CROSS REFERENCE: NONE

CAD DWG. FILE NAME: G-002.DWG 36X24 PLOT SHEET

CAD DWG. FILE NAME: G-002.DWG



ANDREW M. CUOMO
Governor
ROANN M. DESTITO
Commissioner

CONSULTANT:

C.T. MALE ASSOCIATES
50 CENTURY HILL DRIVE, LATHAM, NY 12110

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CONSTRUCTION

REBUILD SITE STORM DRAINAGE BUILDINGS 842, 878

LOCATION: ROCKLAND PC, HUDSON RIVER CAMPUS 10 ROSS CIRCLE, POUGHKEEPSIE, NY 12601

CLIENT: NEW YORK STATE OFFICE OF MENTAL HEALTH

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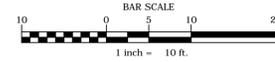
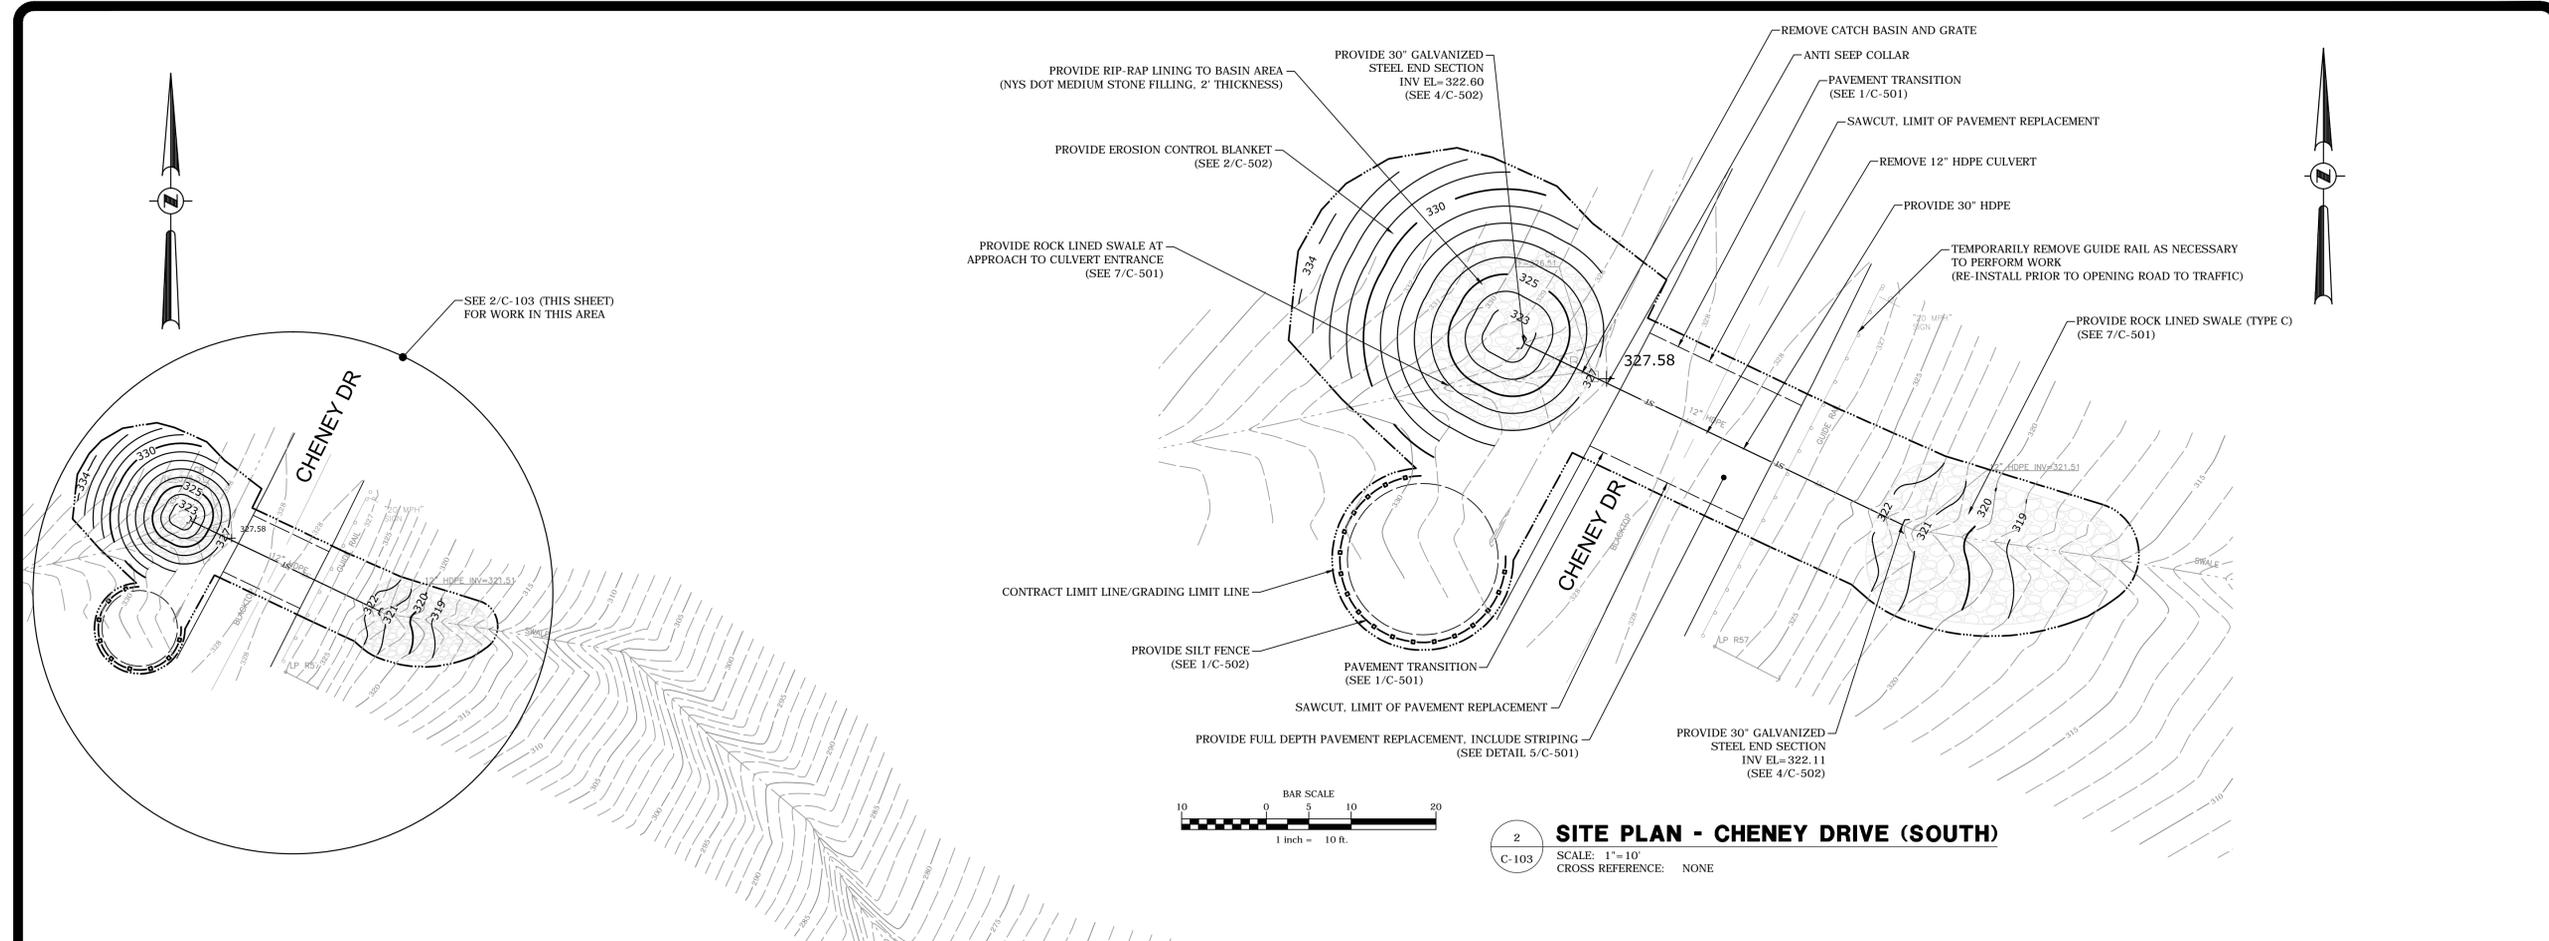
MARK	DATE	DESCRIPTION
	03/12/2014	ADDENDUM NO. 2
	02/07/2014	BID DOCUMENT

PROJECT NUMBER: **M3039 - C**
DESIGNED BY: TJH
DRAWN BY: MFJ
FIELD CHECK:
APPROVED:

SHEET TITLE:
SITE PLAN - CHENEY DR (SOUTH)/ TRANSITIONAL RESIDENCE

DRAWING NUMBER:
C-103

SHEET 5 of 7



2 SITE PLAN - CHENEY DRIVE (SOUTH)
SCALE: 1"=10'
CROSS REFERENCE: NONE

CONSTRUCTION SEQUENCING NOTES - CHENEY DRIVE (SOUTH)

- CLOSE ROADWAY TO TRAFFIC AS NEEDED, AND PROVIDE ADEQUATE DETOUR SIGNAGE. ROAD CLOSINGS SHALL BE KEPT TO A MINIMUM, AND SHALL BE COORDINATED WITH SEMO THROUGH DIRECTOR'S REPRESENTATIVE AND FACILITY REPRESENTATIVE.
- PROVIDE SILT FENCE AND PREPARE TEMPORARY STOCKPILE AREA.
- EXCAVATE AND ROUGH GRADE THE STORMWATER CONVEYANCE AREAS.
- REMOVE EXISTING PAVEMENT AND CULVERT.
- PROVIDE THE CULVERT, END SECTIONS, AND ANTI-SEEP COLLAR.
- PROVIDE PAVEMENT REPLACEMENT, INCLUDE RESTRIPIING.
- FINISH GRADE AND STABILIZE THE ROADSIDE SWALES AND BERM. PROVIDE TEMPORARY EROSION CONTROL BLANKET AND STONE FILLING. EXISTING STONE FILLING SHALL NOT BE REUSED UNLESS IT CAN BE DEMONSTRATED TO COMPLY WITH THE QUALITY AND GRADATION REQUIREMENTS IDENTIFIED IN THE CONTRACT SPECIFICATIONS AND UNDER NYS DOT FIGURE 620-1 FOR EACH TYPE OF STONE FILLING.
- STABILIZE (SEED AND MULCH) AREAS OF INCIDENTAL DISTURBANCE. REMOVE ALL CONSTRUCTION DEBRIS FROM THE SITE, AND SWEEP AND REMOVE ANY SEDIMENT FROM THE ROADWAY.
- REMOVE SILT FENCE ONCE ALL DISTURBED AREAS HAVE ACHIEVED 80 PERCENT VEGETATIVE COVER.

CONSTRUCTION SEQUENCING NOTES - TRANSITIONAL RESIDENCE

- RELOCATE METAL SHED (COORDINATE WITH FACILITY STAFF).
- PROVIDE SILT FENCE AND PREPARE TEMPORARY STOCKPILE AREA.
- CLEAR AND GRUB AREAS OF SWALE CONSTRUCTION.
- EXCAVATE AND ROUGH GRADE THE SWALES.
- FINISH GRADE AND STABILIZE THE SWALES. PROVIDE TEMPORARY EROSION CONTROL BLANKET AND STONE FILLING. EXISTING STONE FILLING SHALL NOT BE REUSED UNLESS IT CAN BE DEMONSTRATED TO COMPLY WITH THE QUALITY AND GRADATION REQUIREMENTS IDENTIFIED IN THE CONTRACT SPECIFICATIONS AND UNDER NYS DOT FIGURE 620-1 FOR EACH TYPE OF STONE FILLING.
- STABILIZE (SEED AND MULCH) AREAS OF INCIDENTAL DISTURBANCE. REMOVE ALL CONSTRUCTION DEBRIS FROM THE SITE, AND SWEEP AND REMOVE ANY SEDIMENT FROM THE PARKING LOT AND ROADWAY.
- REMOVE SILT FENCE ONCE ALL DISTURBED AREAS HAVE ACHIEVED 80 PERCENT VEGETATIVE COVER.

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1 SITE PLAN - TRANSITIONAL RESIDENCE AREA
SCALE: 1"=20'
CROSS REFERENCE: NONE